


ABBREVIATIONS		GENERAL NOTES		FIRE ALARM GENERAL NOTES		MOUNTING HEIGHTS - FIRE ALARM EQUIPMENT		DOB FIRE ALARM FILING NOTE	
(E)	EXISTING ITEM	1.	THE WORK TO BE DONE UNDER THESE SPECIFICATIONS AND THE DRAWINGS CONSISTS OF PROVIDING ALL EQUIPMENT, MATERIALS, LABOR AND SERVICES AND PERFORMING ALL OPERATIONS TO COMPLETE THE CONSTRUCTION WORK FOR THIS PROJECT. ANY WORK NOT SPECIFICALLY COVERED BY THESE SPECIFICATIONS OR INDICATED ON THE CONTRACT DRAWINGS, BUT NECESSARY TO COMPLETE OR PERFECT ANY PART OF THIS INSTALLATION IN A SUBSTANTIAL MANNER, SHALL BE PROVIDED WITHOUT EXTRA COST TO THE OWNER.	1.	PROVIDE ALL EQUIPMENT, MATERIALS, LABOR AND PERFORM ALL OPERATIONS ASSOCIATED WITH THE INSTALLATION OF FIRE ALARM NOTIFICATION DEVICES (AUDIO AND VISUAL), SMOKE DETECTORS, HEAT DETECTORS AND SMOKE DUCT DETECTORS FOR FA UNITS AND OTHER RELATED FIRE ALARM DEVICES AS REQUIRED.	9" BELOW FINISH CEILING		THIS PLAN IS APPROVED ONLY FOR THE WORK INDICATED ON THE APPLICATION SPECIFICATION SHEET. ALL OTHER MATTERS SHOWN ARE NOT TO BE RELIED UPON, OR TO BE CONSIDERED AS EITHER BEING APPROVED OR IN ACCEPTANCE WITH ANY APPLICABLE CODES.	
(ED)	EXISTING ITEM TO BE DEMOLISHED	2.	THE WORK SHALL CONFORM TO THE MORE STRINGENT OF ALL APPLICABLE CODES & REGULATIONS, AS GUIDELINES, MANUFACTURERS LITERATURE AND RECOMMENDATIONS, AND TO THE REQUIREMENTS OF FEDERAL, STATE AND LOCAL REGULATORY AGENCIES AND AUTHORITIES HAVING JURISDICTION.	2.	PROVIDE FIRE ALARM SYSTEM COVERAGE FOR THE NEW TENANT AREA.	CENTERED ABOVE DOOR OR WINDOW OPENING		AUDIBLE NOTIFICATION DESIGN CRITERIA	
(ER)	EXISTING ITEM TO BE RELOCATED	3.	THE DRAWINGS ARE DIAGRAMMATIC IN NATURE AND INDICATE THE EXTENT, GENERAL CHARACTER, LOCATION AND ARRANGEMENT OF THE WORK UNDER THIS CONTRACT. WHERE JOB CONDITIONS REQUIRE MINOR CHANGES OR ADJUSTMENTS IN THE INDICATED LOCATIONS OR ARRANGEMENT OF THE WORK, SUCH CHANGES SHALL BE PROVIDED WITHOUT EXTRA COST. THE CONTRACTOR SHALL RE-INSTALL EQUIPMENT THAT HAS INADEQUATE OR UNSURE ACCESSIBILITY.	3.	THE SYSTEM SHALL BE COMPLETELY WIRED, CONNECTED, TESTED AND VERIFIED TO BE IN GOOD OPERATING CONDITION.	6" F		DESIGN CRITERIA	
(F)	FUTURE	4.	INSTALLATION OF WORK SHALL PROVIDE REASONABLE ACCESSIBILITY FOR OPERATION, INSPECTION AND MAINTENANCE OF EQUIPMENT AND ACCESSORIES. PROVIDE CLEARANCES REQUIRED BY MANUFACTURERS AND APPLICABLE CODES. ALL CEILING MOUNTED EQUIPMENT SHALL BE INSTALLED IN SUCH A MANNER THAT LIGHTS, PIPING, AND DUCTWORK DO NOT BLOCK ACCESS TO EQUIPMENT AND RELATED ACCESSORIES.	4.	THE CONTRACTOR SHALL VISIT THE SITE TO VERIFY EXISTING FIRE ALARM SYSTEM CONDITION PRIOR TO SUBMISSION OF BIDS.			AMBIENT LEVELS	
(N)	NEW	5.	THE TERM "FURNISH" SHALL MEAN TO OBTAIN AND SUPPLY TO THE JOB SITE. THE TERM "INSTALL" SHALL MEAN TO FIX IN POSITION AND CONNECT FOR USE. THE TERM "PROVIDE" SHALL MEAN TO FURNISH AND INSTALL. THE TERM "MECHANICAL WORK," "ELECTRICAL WORK," "PLUMBING WORK," ETC. SHALL MEAN ALL LABOR, MATERIAL, EQUIPMENT, SCAFFOLDING, RIGGING, TOOLS, SUPERVISION, SERVICES AND OTHER INCIDENTALS NECESSARY FOR COMPLETE AND OPERABLE INSTALLATION.	5.	COORDINATE WITH THE BUILDING'S FIRE ALARM VENDOR FOR CONNECTION OF NEW FIRE ALARM DEVICES TO THE EXISTING BASE BUILDING FIRE ALARM SYSTEM.			DESIGN GOALS	
(RL)	EXISTING ITEM RELOCATED	6.	THE OWNER SHALL MAKE SETS OF THE BID DOCUMENTS CONSISTING OF COMPLETE SETS OF DRAWINGS AND SPECIFICATIONS, AND ISSUE THEM TO EACH OF THE PRIME AND SUB-CONTRACTORS. EVERY PRIME AND SUB-CONTRACTOR ON EACH BIDDING TEAM SHALL RECEIVE COMPLETE SETS OF DRAWINGS AND SPECIFICATIONS. THERE ARE NOTES AND CROSS-REFERENCES FOR VARIOUS TRADE CONTRACTORS IN MULTIPLE TRADE OR DISCIPLINE DRAWINGS AND SPECIFICATIONS. THIS EACH CONTRACTOR IS TO RECEIVE COMPLETE SETS OF THE BID DOCUMENTS, IT IS THE CONTRACTORS RESPONSIBILITY TO OBTAIN THESE DRAWINGS FROM OCMG. EACH CONTRACTOR IS RESPONSIBLE FOR THEIR WORK. AS NOTED ON THE OTHER DISCIPLINE DOCUMENTS, BIDDERS ARE RESPONSIBLE FOR ALL COSTS FOR EACH SET OF BID DOCUMENTS REQUESTED.	6.	THE CONTRACTOR SHALL PAY ALL CHARGES FOR THE CONNECTION TO, MODIFICATIONS TO THE EXISTING SYSTEM AND REPROGRAMMING OF THE EXISTING BASE BUILDING FIRE ALARM SYSTEM. FIRE ALARM VENDORS FEE SHALL BE INCLUDED IN THE BID.				
A	AMP	7.	CONTRACTOR IS RESPONSIBLE FOR PROVIDING A FULL COORDINATION EFFORT IN ORDER TO CREATE A FINALIZED COORDINATED LAYOUT OF ALL EQUIPMENT, SYSTEMS, DUCTWORK, PIPING AND ALL OTHER ITEMS WITHIN THEIR RESPECTIVE SCOPE. THE CONTRACTORS COORDINATION EFFORT SHALL INCLUDE COORDINATED INFORMATION FROM ALL OTHER TRADE CONTRACTORS INVOLVED IN THE PROJECT SCOPE IN ORDER TO PROVIDE COORDINATION BETWEEN TRADES AND ALL EXISTING CONDITIONS. ALL ERRORS MADE AS A RESULT OF A LACK OF COORDINATION SHALL BE THE RESPONSIBILITY OF THE CONTRACTOR AND CORRECTED AT NO ADDITIONAL COST TO THE PROJECT. MINOR RELOCATIONS AND SHIFTS OF EQUIPMENT, DUCTWORK, AND PIPING WHICH DO NOT CHANGE THE DESIGN INTENT INDICATED ON THE CONTRACT DOCUMENTS, REQUIRED TO ACCOMMODATE FIELD CONDITIONS ARE AT THE CONTRACTORS DISCRETION AND DO NOT REQUIRE ENGINEER APPROVAL.	7.	ALL EQUIPMENT SHALL BE UL LISTED.				
AV	AUDIO VISUAL	8.	CONTRACTOR SHALL ARRANGE AND OBTAIN ALL PERMITS, INSPECTIONS AND APPROVALS, AND PAY ALL RELATED FEES.	8.	ALL WORK SHALL BE DONE IN ACCORDANCE WITH THE INTERNATIONAL BUILDING CODE, AMERICANS DISABILITY ACT (ADA), NFPA 72 NATIONAL FIRE ALARM CODE, FIRE DEPARTMENT RULES AND REGULATIONS, APPLICABLE REQUIREMENTS OF THE NATIONAL ELECTRICAL CODE WITH AMENDMENTS AND THE LANDLORDS DESIGN CRITERIA REQUIREMENTS FOR TENANT ALTERATIONS.				
AC	AIR CONDITIONING	9.	THE DRAWINGS INDICATE APPROXIMATE LOCATIONS BASED UPON INFORMATION OBTAINED WITHOUT REMOVING CEILING TILES OR WALLS. THEREFORE, THE CONTRACTOR SHALL INCLUDE IN THEIR BID CONTINGENCY COSTS TO ADDRESS CONFLICTS BETWEEN DESIGN AND EXISTING CONDITIONS. ANY CHANGES AND MODIFICATIONS MUST BE REVIEWED AND APPROVED BY THE ENGINEER AND/OR OWNER REPRESENTATIVE PRIOR TO CONSTRUCTION.	9.	UPON COMPLETION OF ALL FIRE ALARM WORK AND ASSOCIATED TESTS, THE CONTRACTOR SHALL FILE AN APPLICATION WITH THE FIRE DEPARTMENT FOR A CERTIFICATE OF APPROVAL OF THE SYSTEM.				
AF	AMP FRAME / AMP TRIP	10.	FOR ANY DISCREPANCY BETWEEN DRAWINGS AND/OR SPECIFICATIONS, THE CONTRACTOR SHALL BASE THEIR BID UPON THE MOST STRINGENT REQUIREMENT (QUALITY, QUANTITY, SIZE, ETC.). THE CONTRACTOR SHALL IDENTIFY DISCREPANCIES AS PART OF THEIR BID.	10.	SUBMIT CERTIFICATE OF APPROVAL TO THE BUILDING ENGINEER OR OWNERS REPRESENTATIVE BEFORE REQUESTING FINAL PAYMENT AND ACCEPTANCE OF WORK.				
AFI	ABOVE FINISHED FLOOR	11.	PRIOR TO DEMOLITION, THE CONTRACTOR SHALL LOG ALL EXISTING EQUIPMENT AND TRACE ELECTRICAL, FIRE ALARM, AND CONTROL CIRCUITS THAT SERVE SUCH EQUIPMENT.	11.	ALL ITEMS AND EQUIPMENT SHALL BE COMPATIBLE WITH THE EXISTING BASE BUILDING FIRE ALARM SYSTEM. CONTRACTOR SHALL COORDINATE WITH BUILDINGS FIRE ALARM VENDOR FOR EXACT EQUIPMENT SPECIFICATION.				
AHJ	AUTHORITY HAVING JURISDICTION	12.	ALL SERVICES TO EXISTING BUILDINGS SHALL BE MAINTAINED DURING CONSTRUCTION UNLESS OTHERWISE INDICATED. CONTRACTOR SHALL COORDINATE ALL SYSTEM SHUT DOWNS AND TRIMMING WITH OWNER.	12.	FIRE ALARM SPEAKER, WHETHER IN COMBINATION WITH A STROBE LIGHT UNIT OR AS A STAND ALONE DEVICE SHALL BE COMPATIBLE WITH THE EXISTING BASE BUILDING FIRE ALARM SYSTEM AND SHALL BE UL/ULM LISTED. COLORS AND FINISHES SHALL BE COORDINATED WITH ARCHITECT.				
AIC	AMPS INTERRUPTING CURRENT	13.	THE CONTRACTOR SHALL EFFECTIVELY PROTECT ALL MATERIALS AND EQUIPMENT FROM ENVIRONMENTAL AND PHYSICAL DAMAGE UNTIL FINAL ACCEPTANCE. CLOSE AND PROTECT ALL OPENINGS DURING CONSTRUCTION. PROVIDE NEW MATERIALS AND EQUIPMENT TO REPLACE ITEMS DAMAGED.	13.	FIRE ALARM STROBE LIGHTS, WHETHER IN COMBINATION WITH A SPEAKER UNIT OR AS A STAND ALONE DEVICE, SHALL HAVE A XENON STROBE OR EQUIVALENT WITH A CLEAR WHITE LENS. MAXIMUM PULSE DURATION OF 0.2 SECONDS. MAX DUTY CYCLE OF 40%. 7% CANDELA MINIMUM. FLASH RATE MINIMUM OF 1 HZ/MAXIMUM 1 HZ AND WITH ADA AND SHALL BE UL/ULM LISTED. UNIT SHALL BE MANUFACTURED BY FARADAY, WHELOCK OR APPROVED EQUAL.				
AL	ALUMINUM	14.	EXISTING EQUIPMENT THAT INTERFERES WITH NEW ARRANGEMENT SHALL BE REMOVED, REINSTALLED, RELOCATED, RECONFIGURED, EXTENDED OR REMOVED AS REQUIRED, TO SUIT THE NEW ARRANGEMENT.	14.	AREA AND SMOKE DETECTORS SHALL BE BUILDING STANDARD.				
ARF	ABOVE BASED FLOOR	15.	WHERE BEAMS ARE INDICATED TO BE PENETRATED WITH DUCTWORK AND/OR PIPING, CAREFULLY COORDINATE SIZES AND LOCATIONS OF THE ELEMENTS BEFORE FABRICATION, COORDINATE WITH FINAL LOCATION OF BEAM PENETRATIONS AND SHEAR WALL PENETRATIONS.	15.	CONTROL MODULES SHALL BE BUILDING STANDARD.				
ARF	ARC FAULT	16.	CONTRACTOR SHALL COORDINATE LOCATION OF ALL WALL, FLOOR AND ROOF OPENINGS WITH STRUCTURAL AND OTHER TRADES.	16.	PROVIDE #14 AWG WIRING (MINIMUM) FOR ALL DEVICES, U.O.N. BY BUILDING'S FIRE ALARM VENDOR. ALL SPEAKER CABLEING SHALL BE TWISTED SHIELDED TYPE OR AS SPECIFIED BY BUILDING'S FIRE ALARM VENDOR. FIRE ALARM CABLEING SHALL BE UL/ULM APPROVED, COLORED FIRE DEPARTMENT RED, PLENUM RATED, CABLE PRINTING AS PER UL1424, MUST BEAR ADDITIONAL DESCRIPTION "ALSO CLASSIFIED CERT. FIRE."				
AS	AMP SWITCH / AMP FUSE	17.	PROVIDE CUTTING AND PATCHING AS REQUIRED AND WHERE NECESSARY TO ACCOMMODATE NEW WORK AND THE REPAIR OF EXISTING WORK.	17.	WIRING SHALL BE INSTALLED IN HEAVY WALL THREADED RIGID GALVANIZED CONDUIT IN VERTICAL RISERS AND AREAS WHERE SUBJECT TO MECHANICAL DAMAGE.				
ATS	AUTOMATIC TRANSFER SWITCH	18.	WHEN WORK INVOLVES CONTACT WITH MATERIALS CONTAINING ASBESTOS, PCB, OR OTHER TOXIC MATERIALS, NOTIFY OWNER, WHO WILL ESTABLISH PROCEDURES FOR REMEDIATION AND REMOVAL.	18.	ALL WIRING IN EXPOSED CEILING SHALL BE IN HEAVY WALL THREADED RIGID GALVANIZED STEEL CONDUIT.				
AWG	AMERICAN WIRE GAUGE	19.	CONTRACTOR SHALL SCHEDULE THE WORK UNDER THIS CONTRACT WITH WORK OF OTHER TRADES AS NOT TO DELAY THE OVERALL PROGRESS OF THE PROJECT.	19.	ALL WIRING IN MECHANICAL ROOM AND ELEVATOR ROOM SHALL BE IN HEAVY WALL THREADED RIGID GALVANIZED STEEL CONDUIT.				
BLDG	BUILDING	20.	CONTRACTOR SHALL NOTIFY ARCHITECT/ENGINEER OF ANY CONFLICTS PRIOR TO PURCHASING EQUIPMENT AND PRIOR TO CUTTING OPENINGS.	20.	WIRING MAY BE RUN EXPOSED IN HUNG CEILINGS, PROVIDED IT IS UL LISTED AND APPROVED WORK. LIMITED PROTECTIVE SIGNALING CABLE PPL OR EQUAL (TEFLON COATED/PLENUM RATED).				
CLS	CONDUIT	21.	CONTRACTOR SHALL PROVIDE SHOP DRAWINGS PER SPECIFICATIONS PRIOR TO PURCHASING OR INSTALLING EQUIPMENT AND SYSTEMS INDICATED ON CONTRACT DOCUMENTS. PRIOR TO SUBMITTAL, CONTRACTOR SHALL VERIFY THAT ADEQUATE SPACE EXISTS FOR THE SUBMITTED EQUIPMENT. SHOP DRAWINGS MUST BE REVIEWED BY ARCHITECT/ENGINEER.	21.	ALL LOW VOLTAGE WIRING SHALL COMPLY WITH NFPA 72 AND LOCAL AND STATE BUILDING CODES.				
CAB	CABINET	22.	CONTRACTOR SHALL BE RESPONSIBLE FOR ALL COSTS INCURRED BY OTHER TRADES DUE TO SUBSTITUTION OF OTHER THAN SCHEDULED EQUIPMENT. WHEN EQUIPMENT FURNISHED IS DIFFERENT THAN INDICATED, THE COST OF ADDITIONAL ELECTRICAL SERVICE, STRUCTURAL, AND RELATED WORK SHALL BE PAID BY THIS CONTRACTOR.	22.	THE FIRE ALARM DEVICES SHALL BE INSTALLED IN A WORKMANLIKE MANNER, IN ACCORDANCE WITH APPROVED MANUFACTURERS WIRING DIAGRAM. THE CONTRACTOR SHALL PROVIDE ALL CONDUIT WIRING, WIRING, OUTLET BOXES, JUNCTION BOXES AND SIMILAR DEVICES NECESSARY FOR THE COMPLETE FIRE ALARM INSTALLATION.				
CB	CIRCUIT BREAKER	23.	ALL WORK SHALL BE EXECUTED IN A NEAT AND WORKMANLIKE MANNER AND SHALL BE DONE IN ACCORDANCE WITH GOOD TRADE PRACTICE AND IN CONFORMANCE WITH APPLICABLE MANUFACTURERS' RECOMMENDATIONS.	23.	THE CONTRACTOR SHALL BE RESPONSIBLE FOR PROVIDING AND INSTALLING ALL NEW LIFE SAFETY DEVICES AND ASSOCIATED CABLEING AND CONDUIT. THE CONTRACTOR SHALL COORDINATE AND PAY FOR ALL REQUIRED MODIFICATIONS AND CONNECTIONS TO THE FIRE ALARM SYSTEM WHICH INCLUDE BUT ARE NOT LIMITED TO THE FOLLOWING:				
COT	CIRCUIT	24.	CONTRACTOR SHALL REMOVE ALL TRASH, DEBRIS AND DEMOLITION MATERIAL FROM PREMISES AT THE END OF EACH DAY.	24.	a. HARDWARE MODIFICATIONS TO THE FIRE COMMAND STATION PANEL.				
CL	CENTER LINE	25.	RESTORE ALL SURFACES (WALLS, CEILINGS, FLOORS AND ROOFS) THAT ARE DAMAGED BY THE WORK OF THIS CONTRACT TO THEIR ORIGINAL CONDITION AT NO EXTRA COST TO THE OWNER.	25.	b. MODIFICATIONS/REPROGRAMMING OF FIRE ALARM SYSTEM SOFTWARE.				
CLF	CURRENT LIMITING FUSE	26.	PRIOR TO EQUIPMENT STARTUP, CONTRACTOR SHALL PERFORM THE SPECIFIED STARTUP AND COMMISSIONING PROCEDURES.	26.	c. INCORPORATE NEW PANELS OR DEVICES TO EXISTING DATA GATHERING PANELS.				
CLS	CEILING	27.	IN THE ABSENCE OF OTHER SPECIFIC INSTRUCTIONS, ALL WORK AND MATERIALS SUPPLIED SHALL BE GUARANTEED FOR A PERIOD OF ONE (1) YEAR FROM THE DATE OF THEIR ACCEPTANCE BY THE OWNER.	27.	d. ADDITIONAL POWER FROM NEW FUSE CUT-OUTS TO SERVE ADDITIONAL SYSTEM OR SUB-SYSTEM.				
CONTR	CONTRACTOR	28.	BALA CONSULTING ENGINEERS, INC. (BALA) WILL PROVIDE CONTRACTOR WITH ELECTRONIC CAD FILES OF THE ENGINEERING DESIGNS FOR THE SOLE USE IN EXISTING SHOP DRAWINGS. BALAS FILES SHALL NOT BE DIRECTLY COPIED AND ISSUED AS SHOP DRAWINGS. THE CONTRACTOR SHALL BE RESPONSIBLE FOR ALL FIELD COORDINATION, DIMENSIONING AND ADHERENCE TO THE SHOP DRAWING REQUIREMENTS AS NOTED IN THE SPECIFICATIONS. SHOULD THE SHOP DRAWINGS SUBMITTED PROVE TO BE A DIRECT COPY OF OUR FILES WITHOUT THE NECESSARY FIELD COORDINATION, DIMENSIONING AND ADHERENCE TO THE SHOP DRAWING REQUIREMENTS AS NOTED IN THE SPECIFICATIONS, THESE SHOP DRAWINGS WILL BE RETURNED AS REJECTED. BALAS ELECTRONIC FILES ARE SAVED IN VERSION REVIT 2021 AND ARE COMPATIBLE WITH ALL VERSIONS AFTER THAT. BALA MAKES NO REPRESENTATION AS TO THE COMPATIBILITY OF THESE FILES WITH THE CONTRACTORS' HARDWARE OR THEIR SOFTWARE. DATA CONTAINED ON THESE ELECTRONIC FILES ARE PART OF BALAS' INSTRUMENTS OF SERVICE AND ARE COPYRIGHTED. CONTRACTORS USE OF FILES FOR THE SOLE PURPOSE AS A CONVENIENCE IN THE PREPARATION OF DRAWINGS FOR THE REFERENCED PROJECT. ANY OTHER USE OR REUSE BY CONTRACTOR IS UNLAWFUL.	28.	28. THE CONTRACTOR SHALL SEPARATELY ZONE LIFE SAFETY DEVICES SHOWN ON RISER DIAGRAM AND CONNECT TO THE EXISTING BASE BUILDING FIRE ALARM SYSTEM.				
CONV	CONVENIENCE			29.	SECURELY FASTEN IN POSITION ALL DEVICES AND WIRES USED IN THE FIRE ALARM SYSTEM. SUPPORT WIRING INDEPENDENTLY FROM BUILDING STRUCTURE. DO NOT USE HVAC DUCT, PIPES, LINES, HUNG CEILING TO SUPPORT FIRE ALARM WIRING.				
CT	CURRENT TRANSFORMER			30.	TWO OR MORE VISIBLE APPLIANCE IN THE SAME FIELD OF VIEW SHALL BE SYNCHRONIZED.				
CU	COPPER			31.	ALL CABLE AND CONDUIT PENETRATIONS THRU FIRE RATED WALLS AND FLOORS SHALL BE FIRESTOPPED IN ACCORDANCE WITH LOCAL AND STATE BUILDING CODE.				
D.O.	DRAWOUT			32.	WHERE SHIELDED WIRING IS USED, SPLICE AND INSULATE DOWN WIRE FOR THE FULL LENGTH OF THE WIRE RUN. SHIELDS TO BE GROUNDED ONLY AS INDICATED. ALL SHIELDED CABLE SHALL HAVE INSULATING JACKET.				
DC	DOOR CONTACT			33.	SPLICES IN VERTICAL RISERS ARE PROHIBITED EXCEPT WHEN THE LENGTH OF CONDUCTORS EXCEEDS 100 FT. IN WHICH CASE AN APPROVED TERMINAL CABBINET MAY BE USED. SPLICES IN HORIZONTAL RUNS SHALL BE AVOIDED, IF NECESSARY, THEY SHALL BE MADE IN APPROVED JUNCTION BOXES. SPLICES SHALL BE MADE WITH UL LISTED MECHANICAL CONNECTOR OR SOLDERED AND TAPED.				
DISC	DISCONNECT			34.	IDENTIFY FIRE ALARM SYSTEM TERMINAL AND JUNCTION LOCATIONS IN ACCORDANCE WITH NFPA STANDARD 70, SECTION 760.3. TERMINAL AND JUNCTION BOXES SHALL BE PAINTED RED AND STENCILED IN WHITE LETTERS "FIRE ALARM".				
DIST	DISTRIBUTION			35.	A TRAINED MANUFACTURERS TECHNICAL REPRESENTATIVE SHALL TEST THE COMPLETED SYSTEM FOR PROPER OPERATION IN THE PRESENCE OF THE OWNERS REPRESENTATIVE. ANY SYSTEM EQUIPMENT, DEVICE OR WIRING FAILURE DISCOVERED DURING THE TEST SHALL BE REPAIRED OR REPLACED BEFORE REQUESTING A SCHEDULE FOR A FINAL ACCEPTANCE TEST.				
DW	DISHWASHER			36.	THE CONTRACTOR SHALL FILE FORM APPLICATION FOR ELECTRICAL INSPECTION AND SUMMARY OF CONTRACT EQUIPMENT TO BE INSTALLED WITH THE DIVISION OF FIRE DEPARTMENT. THIS FORM SHALL BE FILED IN PREPARATION FOR THE FINAL TEST OF THE SYSTEM.				
DWG	DRAWING			37.	PERFORM ANY ADDITIONAL TESTS REQUESTED BY THE FIRE DEPARTMENT.				
EC	ELECTRICAL CONTRACTOR								
EF	EXHAUST FAN								
ELEC	ELECTRICAL								
EM EMRG	EMERGENCY								
EMT	ELECTRICAL METALLIC TUBING								
ENCL	ENCLOSURE								
EPO	EMERGENCY POWER OFF EQUIPMENT								
EWC	ELECTRIC WATER COOLER								
EWH	ELECTRIC WATER HEATER								
FA	FIRE ALARM								
FDR	FEEDER								
FXT	FIXTURE								
FL	FLOOR								
FP	FIRE PROTECTION								
G, GND	GROUND								
GEN	GENERATOR								
GF	GROUND FAULT								
GFI	GROUND FAULT INTERRUPTOR								
HOA	HAND OFF AUTOMATIC SWITCH								
HP	HORSE POWER								
HVAC	HEATING VENTILATION AND AIR CONDITIONING								
HWH	HOT WATER HEATER								
HZ	HERTZ								
IG	ISOLATED GROUND								
JB	JUNCTION BOX								
KAC	KILO AMPERE INTERRUPTING CURRENT								
KMILS	THOUSAND CIRCULAR MILS								
KW	KILOWATT								
KW	KILOWATTS								
LSIG	LONG, SHORT INSTANTANEOUS AND GROUND FAULT TRIP FUNCTION								
LGT	LIGHTING								
MAX	MAXIMUM								
MB	MOTORIZED BACKBOARD								
MC	METAL CLAD								
MC	MOTORIZED CURTAIN								
MCS	MAIN CIRCUIT BREAKER								
MCC	MOTOR CONTROL CENTER								
MFG	MANUFACTURER								
MH	MOUNTING HEIGHT								
MI	MINERAL INSULATED								
MLO	MAIN LUGS ONLY								
MOD	MOTORIZED OVERHEAD DOOR								
MPS	MOTORIZED PROJECTION SCREEN								
MS	MOTORIZED SHADES								
MTO	MOUNTED								
MW	MICROWAVE								
N	NEUTRAL								
NC	NORMALLY CLOSED								
NC	NOT IN CONTACT								
NL	NIGHT LIGHT								
NO	NORMALLY OPEN								
NO	NUMBER								
NTS	NOT TO SCALE								
OFE	OWNER FURNISHED EQUIPMENT								
P	POLES								
PB	PULL BOX								
PC	PLUMBING CONTRACTOR								
PH	PHASE								
PL	OUTLET DEVICE WITH PLATE ONLY								
PNE	PRE-PURCHASED EQUIPMENT								
PRT	PRINTER								
PT	POTENTIAL TRANSFORMER								
PVC	POLYVINYL CHLORIDE								
PWR	POWER								
QUAD	QUADPLEX								
REC	RECESSED								
RECEPT	RECEPTACLE								
REF	REFRIGERATOR								
RF	RETURN FAN								
RGS	RIGID GALVANIZED STEEL								
RM	ROOM								
SB	SCORE BOARD								
SEC	SECONDARY								
SF	SUPPLY FAN								
SKRU	SOLENOID KEY RELEASE UNIT								
SPD	SURGE PROTECTION DEVICE								
SSCAF	SHORT CIRCUIT COORDINATION ARC FLASH								
ST	SHUNT TRIP								
SW	SWITCH								
SWBD	SWITCH BOARD								
SWGR	SWITCH GEAR								
TC	TELECOM TELECOMMUNICATIONS								
TD	TIME DELAY RELAY								
TEL	TELEPHONE								
TF	TRANSFER FAN								
TP	TAMPER PROOF								
TPS	TWISTED PAIR SHIELDED								
TR	TYPICAL								
UC	UNDERCOUNTER								
UCR	UNDER COUNTER REFRIGERATOR								
UF	UNDERFLOOR								
UH	UNIT HEATER								
UN	UNLESS OTHERWISE NOTED								
UPS	UNINTERRUPTIBLE POWER SUPPLY								
V	VOLTS								
VA	VOLT AMPS								
W	WATTS								
WP	WEATHER PROOF								
XMR	TRANSFORMER								

FIRE ALARM GENERAL NOTES	
1.	SMOKE DETECTORS SHALL BE PROVIDED WITH EACH OF THE ELECTRICAL ROOM LOCATED ON THE MEZZANINE LEVEL IN ACCORDANCE WITH NFPA 72. AN EQUAL AMOUNT OF REMOTE INDICATORS SHALL BE PROVIDED FOR THE NUMBER OF SMOKE DETECTORS/DETECTORS REQUIRED TO PROTECT THE ELECTRICAL ROOMS.
2.	TO DATE BALA HAS NOT COORDINATED WITH THE ARCHITECT ABOUT THE LOCATION OF DOOR HOLD DEVICES AND/OR FIRE SHUTTERS. THIS WILL IMPACT THE NUMBER OF SMOKE DETECTORS AND CONTROL MODULES REQUIRED TO INITIATE SPECIFIC ADDRESSABLE INTERFACES.
3.	THE QUANTITY OF FIRE-SMOKE DAMPERS, DUCT SMOKE DETECTORS AND REMOTE TEST STATIONS HAS NOT BEEN COORDINATED YET. A FIRE-SMOKE DAMPER WILL BE PROVIDED AT EACH DUCT PENETRATION. A DUCT SMOKE DETECTOR WILL BE PROVIDED AT EACH AHJ AND EACH FIRE-SMOKE DAMPER.
4.	THE QUANTITY OF CONTROL MODULES TO SHUNT SOUNDING EQUIPMENT HAS NOT BEEN COORDINATE WITH THE THERABEST CONSULTANT AND OTHER ANY RELATED CONSULTANTS.
5.	THERE NEEDS TO BE A MEETING BETWEEN THE PROJECT TEAM AND THE LOCAL FIRE DEPARTMENT TO DETERMINE IF THE ADDRESSABLE FIRE ALARM SYSTEM SERVING THE HIGH SCHOOL BUILDING WILL NEED TO BE EXTENDED TO SERVE THE MAINTENANCE BUILDING, CONCESSION BUILDING, AND LOCKER ROOM BUILDING. THIS WILL IMPACT THE NEED TO PROVIDE A 2-HR RATED DUCT BANK TO HOUSE THE CONDUITS THAT WILL BE REQUIRED.

MOUNTING HEIGHTS - FIRE ALARM EQUIPMENT	
9" BELOW FINISH CEILING	WALL MOUNTED BELLS AND FIRE ALARM SOUNDING DEVICE OR AS SHOWN ON ARCHITECTURAL DETAILS
CENTERED ABOVE DOOR OR WINDOW OPENING	TV MONITOR OUTLET AND SERVICE RECEPTACLE FOR SHELF MOUNTED TV
6" F	WARNING AND SIGNALING FIXTURES / SIGNS
6" F	FIRE ALARM STRO ST



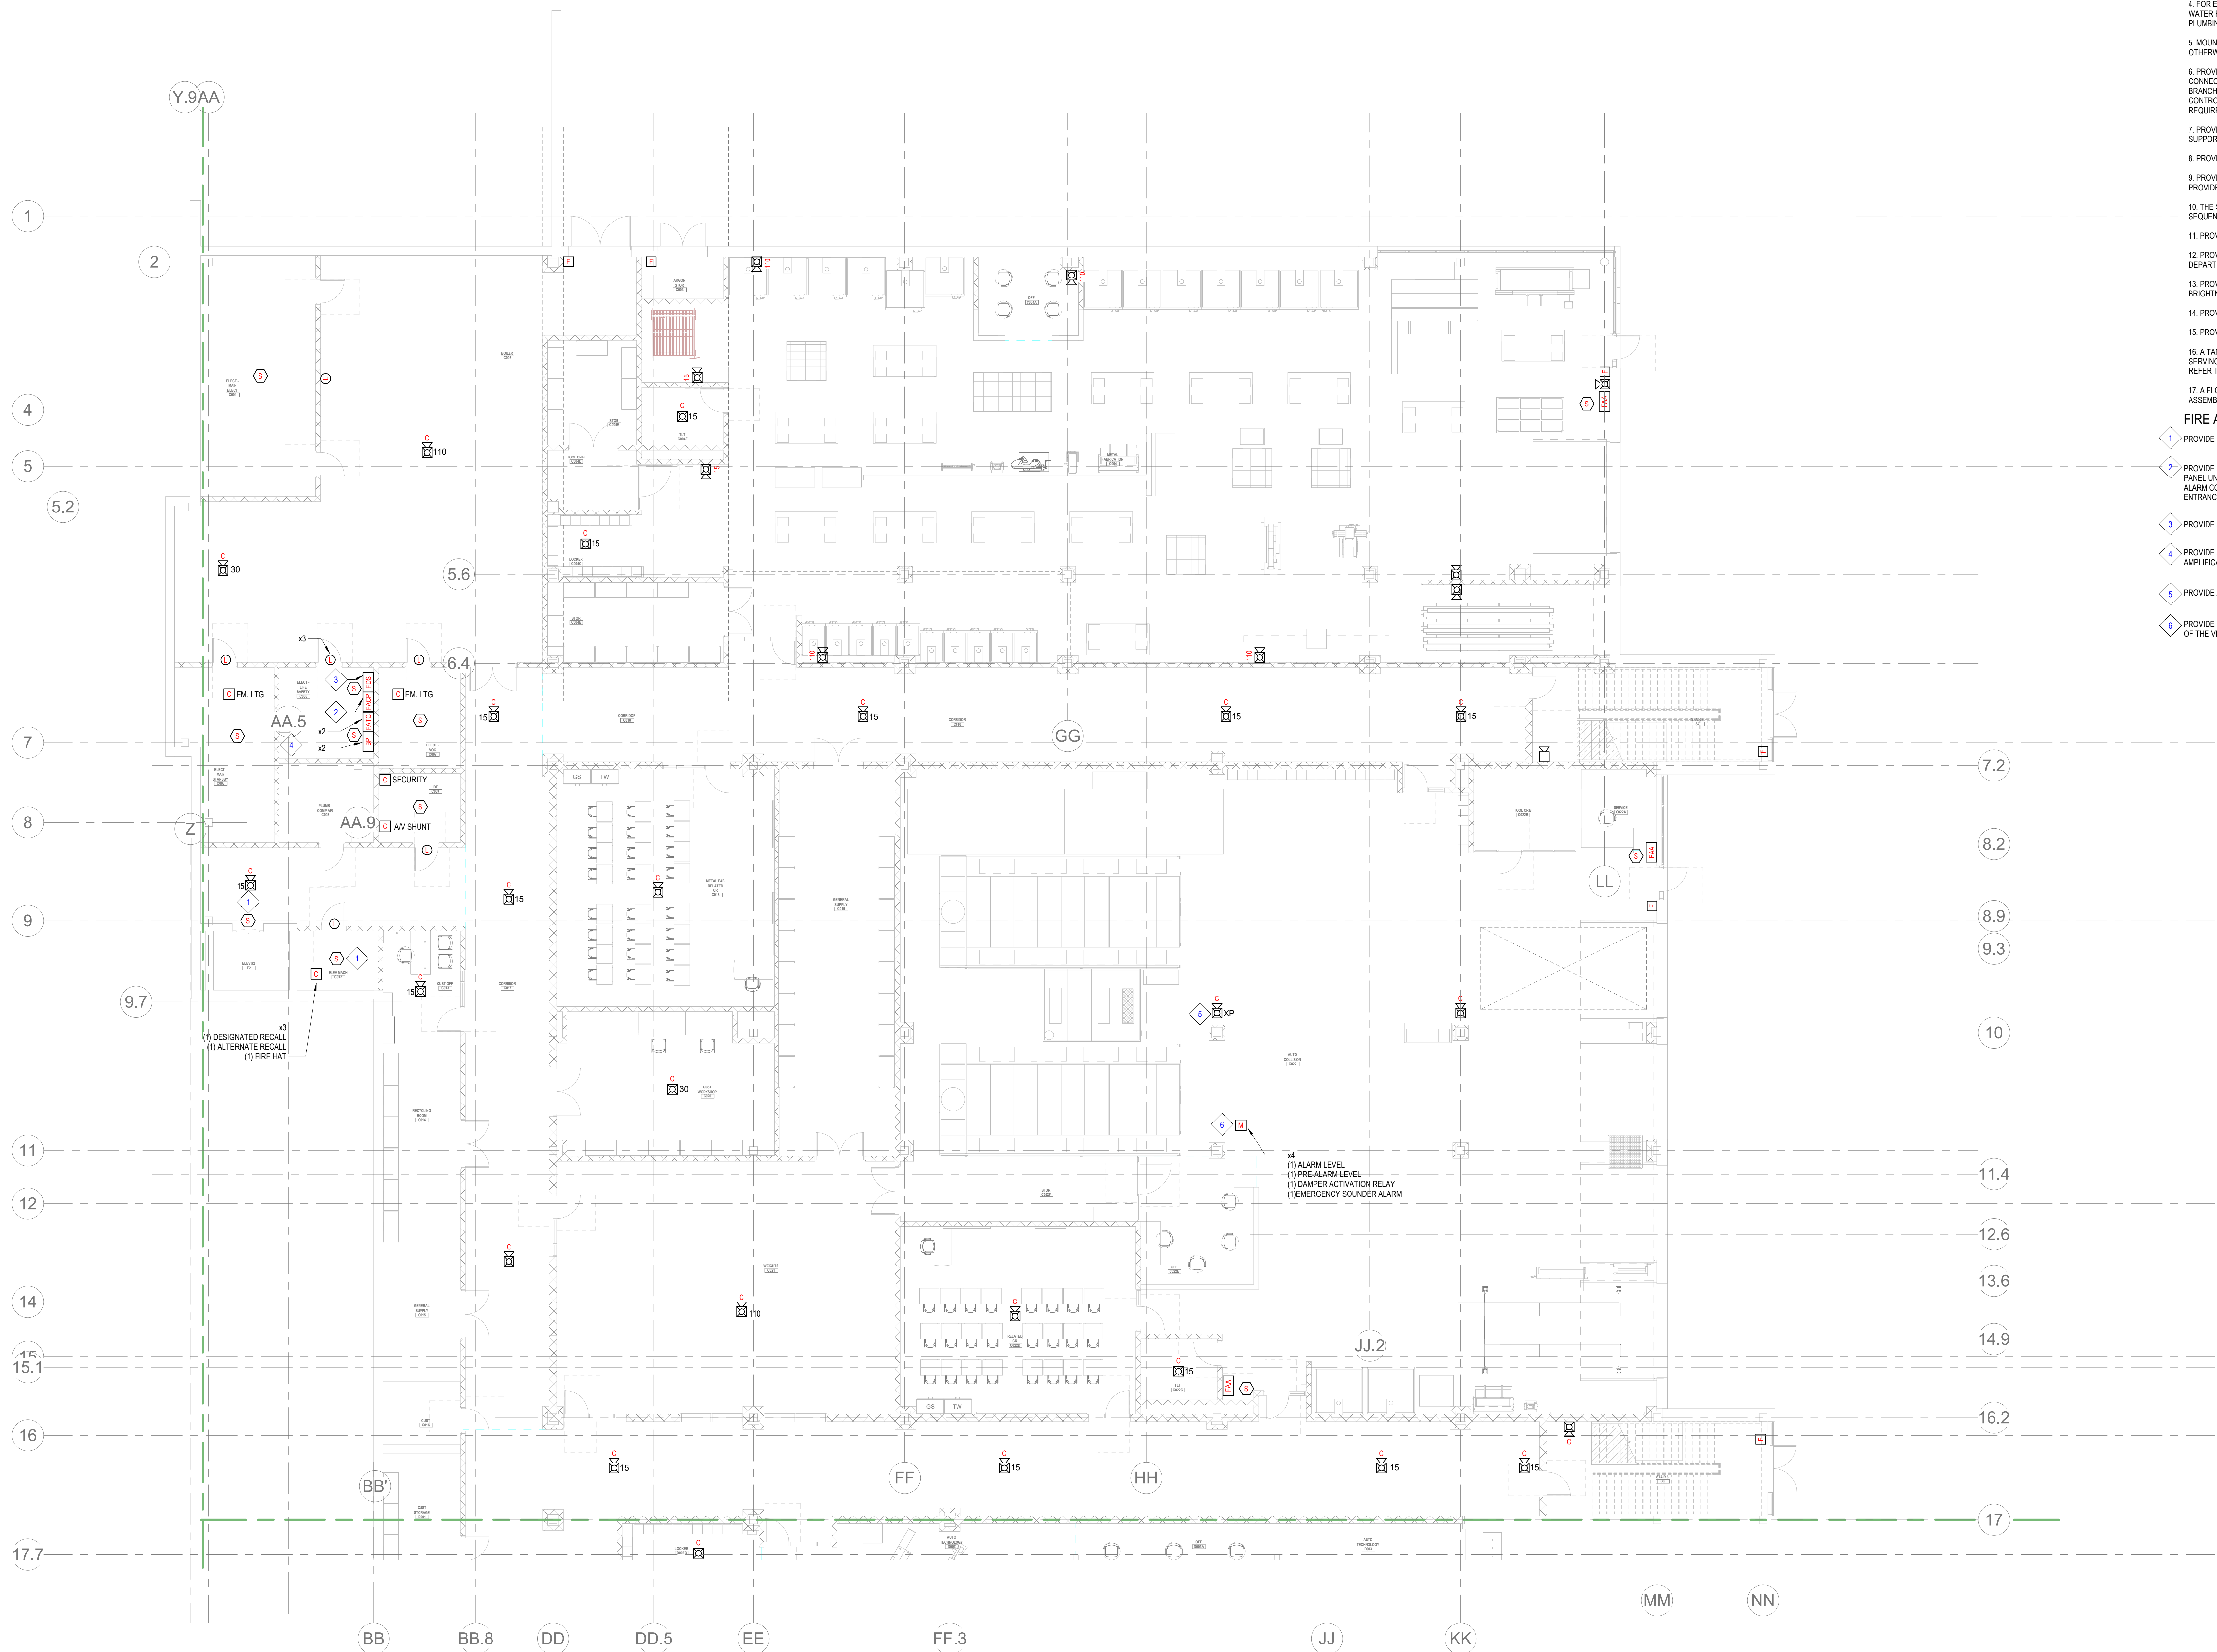


2 FIRE ALARM LOWER LEVEL FLOOR PLAN - AREA C  
1/8" = 1'-0"

GENERAL FIRE ALARM NOTES:

1. PROVIDE A FULLY OPERATIONAL TEMPORARY FIRE ALARM SYSTEM DURING ALL WORK. APPROVED BY LOCAL FIRE DEPARTMENT. PROVIDE FIRE ALARM SYSTEM PROGRAMMING AND TESTING ACCORDING TO LOCAL FIRE DEPARTMENT REQUESTS. TEMPORARY SYSTEM SHALL REMAIN UNTIL NEW SYSTEM HAS BEEN APPROVED FOR OPERATION.
2. COORDINATE LOCATION OF FIRE ALARM APPLIANCES AND DEVICES IN AREAS WITH CEILING SYSTEM, DUCTWORK, FIXTURES, FURNITURE, AND OTHER EQUIPMENT PRIOR TO ALL WORK.
3. FINAL LOCATIONS AND ARRANGEMENTS OF FIRE ALARM DEVICES SHALL BE OBTAINED FROM THE ARCHITECTURAL REFLECTED CEILING PLAN AND ELEVATION VIEWS.
4. FOR EXACT LOCATIONS OF SMOKE/FIRE DAMPERS, DUCT-MOUNTED SMOKE DETECTORS, WATER FLOW SWITCHES AND VALVE TAMPER SWITCHES, REFER TO FIRE PROTECTION, PLUMBING AND MECHANICAL/RAC DRAWINGS.
5. MOUNTING HEIGHTS SHALL BE TO CENTER OF DEVICE OR EQUIPMENT, UNLESS OTHERWISE NOTED.
6. PROVIDE RACEWAY, CONDUCTORS AND CABLE, ASSOCIATED FITTINGS AND CONNECTORS, AND COMPLETE CONNECTIONS REQUIRED FOR DESIGNATED FIRE ALARM BRANCH CIRCUITS FROM DEVICES TO FIRE ALARM TERMINAL CABINETS OR FIRE ALARM CONTROL PANEL OR FIRE COMMAND CENTER PER FIRE ALARM PRODUCT MANUFACTURER REQUIREMENTS.
7. PROVIDE ADDITIONAL POWER SUPPLIES, AMPLIFICATION AND BATTERY BACKUP TO SUPPORT NEW/ADDED DEVICES.
8. PROVIDE TEMPORARY HEAT DETECTORS AS REQUIRED BY LOCAL FIRE DEPARTMENT.
9. PROVIDE NEW AV DEVICES WITH INTEGRAL SYNCHRONIZATION CAPABILITIES AND/OR PROVIDE SYNCHRONIZATION MODULES FOR SYNCHRONIZATION OF ALL VISUAL DEVICES.
10. THE SCOPE OF THIS PROJECT SHALL IN NO WAY IMPACT THE DAILY OPERATION OR THE SEQUENCE OF OPERATION OF THE EXISTING FIRE ALARM SYSTEM.
11. PROVIDE ALL PROGRAMMING/RE-PROGRAMMING PER REVISED SPACE DESIGNATIONS.
12. PROVIDE ALL PRETESTS AND FINAL TESTS PER TOWN OF STONEHAM FIRE DEPARTMENT.
13. PROVIDE FIRE ALARM INTERFACE TO BRING ALL DIMMED LUMINAIRES TO FULL BRIGHTNESS UPON ALARM.
14. PROVIDE FIRE ALARM INTERFACE TO SHUNT ALL AV AND/OR SOUND EQUIPMENT.
15. PROVIDE FIRE ALARM INTERFACE TO RELEASE ALL SECURITY DEVICES.
16. A TAMPER SWITCH SHALL BE PROVIDED AT EACH ISOLATION CONTROL VALVE SERVING THE COMBINATION STAMPER/SPRINKLER SYSTEM. FOR MORE INFORMATION REFER TO THE FIRE PROTECTION DRAWINGS.
17. A FLOW AND SUPERVISORY SWITCH SHALL BE PROVIDED FOR EACH CONTROL VALVE ASSEMBLY. FOR MORE INFORMATION REFER TO THE FIRE PROTECTION DRAWINGS.

FIRE ALARM KEYNOTES:

- 1. PROVIDE SMOKE DETECTION TO INITIATE ELEVATOR RECALL.
- 2. PROVIDE A NEW ANALOG ADDRESSABLE FIRE ALARM CONTROL PANEL UNIT IN THE FA ROOM. AN ANNUNCIATOR FOR THE FIRE ALARM CONTROL PANEL SHALL BE INSTALLED AT THE MAIN ENTRANCE VESTIBULE, MAIN OFFICE, AND SHOP AREAS.
- 3. PROVIDE A FIRE ALARM DRILL SWITCH TO ACTUATE A FIRE DRILL.
- 4. PROVIDE A REMOTE ANNUNCIATOR FOR THE BI-DIRECTIONAL AMPLIFICATION SYSTEM.
- 5. PROVIDE AN EXPLOSION PROOF COMBINATION SPEAKER/STROBE.
- 6. PROVIDE MONITOR RELAY MODULES TO MONITOR THE INPUTS OF THE VENTILATION CONTROL PANEL.

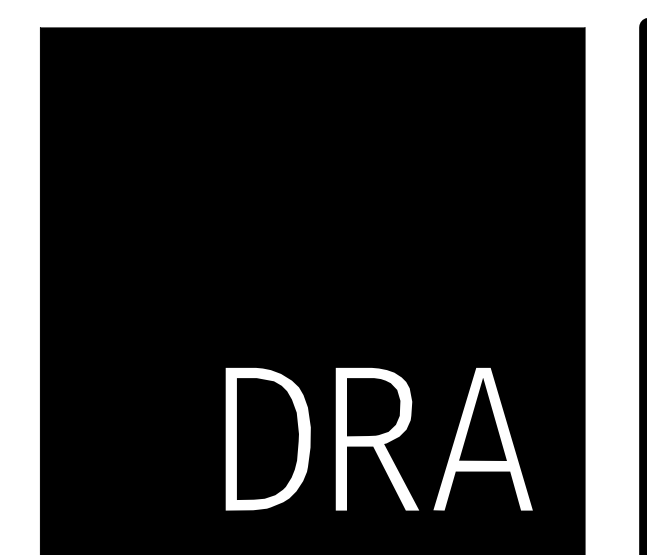

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Waltham, MA 02453  
Tel: 817.984.1700  
www.dra.com


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Regional  
Vocational High  
School

Wakefield, MA 01880


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August 4th, 2022



KEY PLAN

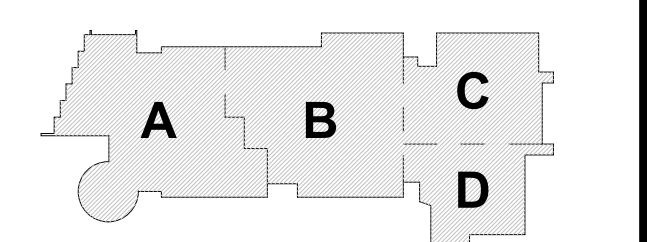


FIRE ALARM  
LOWER LEVEL  
FLOOR PLAN -  
AREA C

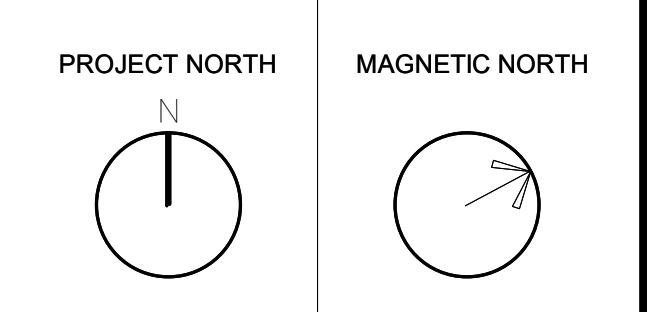Scale: 1/8" = 1'-0"  
Job No.: 20202  
Drawn By: DRA  
Date: August 4th, 2022

FA1-1-0C



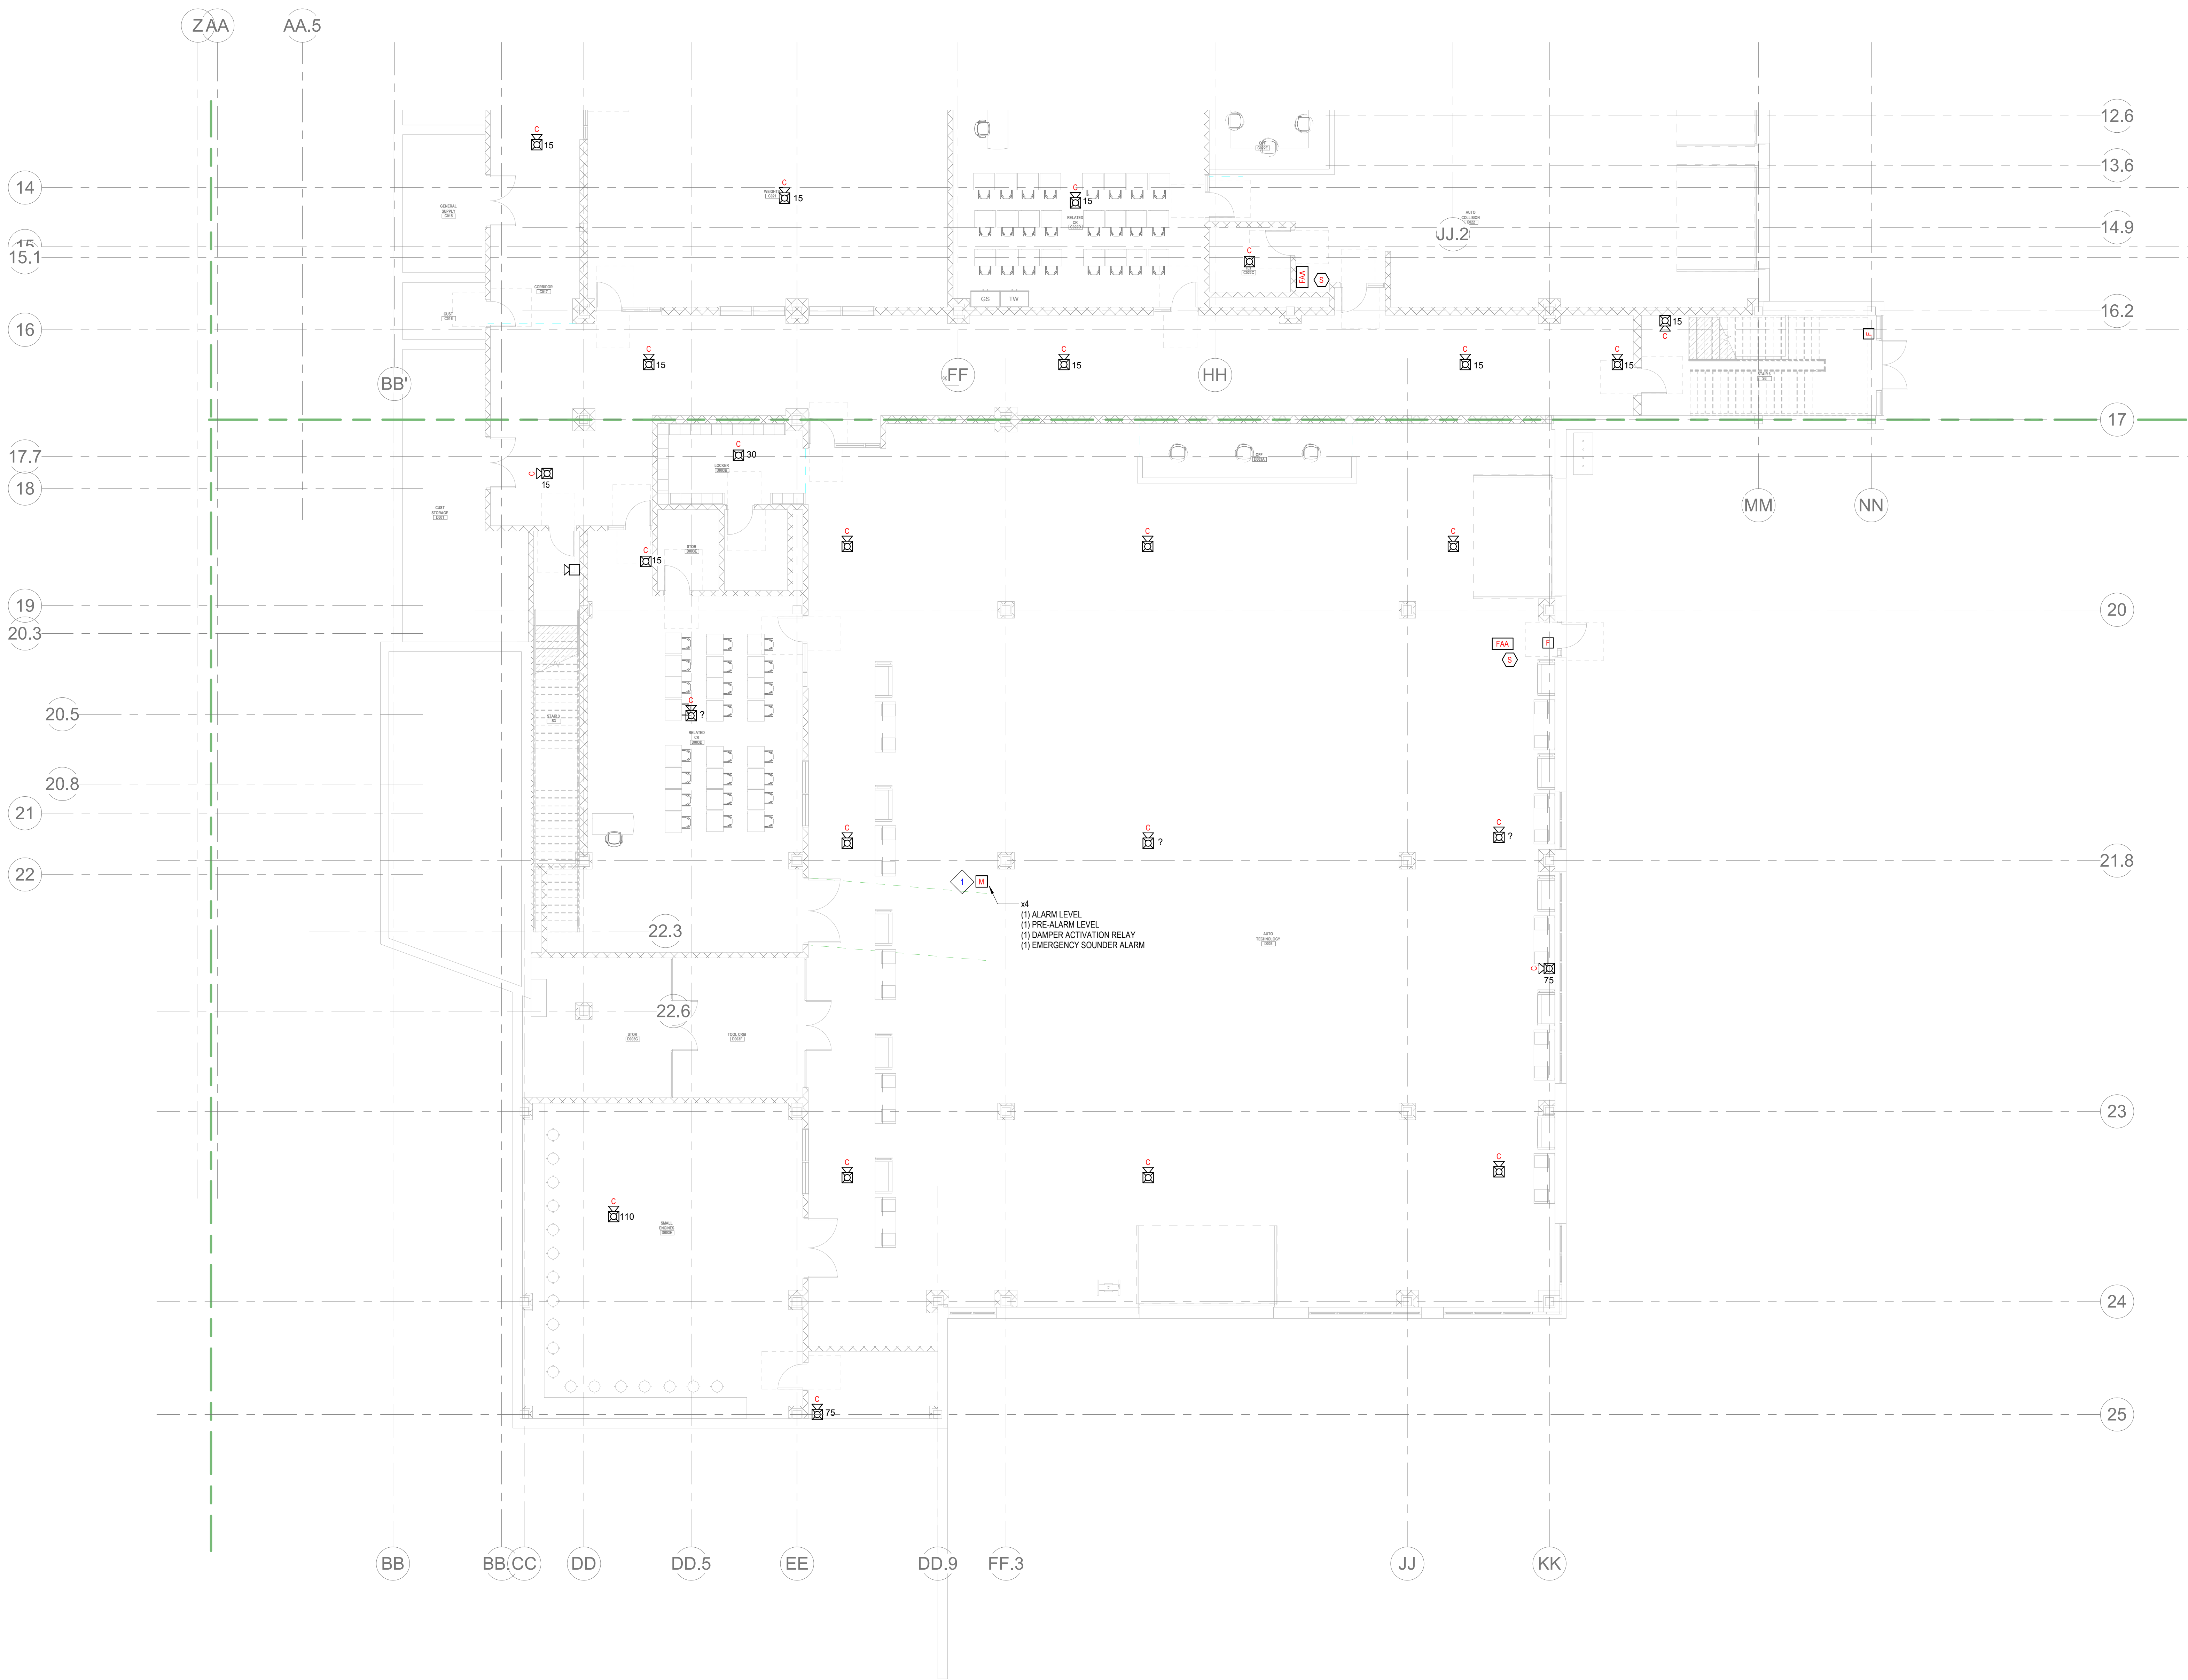

2 FIRE ALARM LOWER LEVEL FLOOR PLAN - AREA D  
1/8" = 1'-0"

GENERAL FIRE ALARM NOTES:

1. PROVIDE A FULLY OPERATIONAL TEMPORARY FIRE ALARM SYSTEM DURING ALL WORK, APPROVED BY LOCAL FIRE DEPARTMENT. PROVIDE FIRE ALARM SYSTEM PROGRAMMING AND TESTING ACCORDING TO LOCAL FIRE DEPARTMENT REQUESTS. TEMPORARY SYSTEM SHALL REMAIN UNTIL NEW SYSTEM HAS BEEN APPROVED FOR OPERATION.
2. COORDINATE LOCATION OF FIRE ALARM APPLIANCES AND DEVICES IN AREAS WITH CEILING SYSTEM, DUCTWORK, FIXTURES, FURNITURE, AND OTHER EQUIPMENT PRIOR TO ALL WORK.
3. FINAL LOCATIONS AND ARRANGEMENTS OF FIRE ALARM DEVICES SHALL BE OBTAINED FROM THE ARCHITECTURAL REFLECTED CEILING PLAN AND ELEVATION VIEWS.
4. FOR EXACT LOCATIONS OF SMOKE/FIRE DAMPERS, DUCT-MOUNTED SMOKE DETECTORS, WATER FLOW SWITCHES AND VALVE TAMPER SWITCHES, REFER TO FIRE PROTECTION, PLUMBING AND MECHANICAL/RAC DRAWINGS.
5. MOUNTING HEIGHTS SHALL BE TO CENTER OF DEVICE OR EQUIPMENT, UNLESS OTHERWISE NOTED.
6. PROVIDE RACEWAY, CONDUCTORS AND CABLE, ASSOCIATED FITTINGS AND CONNECTORS, AND COMPLETE CONNECTIONS REQUIRED FOR DESIGNATED FIRE ALARM BRANCH CIRCUITS FROM DEVICES TO FIRE ALARM TERMINAL CABINETS (OR FIRE ALARM CONTROL PANEL OR FIRE COMMAND CENTER PER FIRE ALARM PRODUCT MANUFACTURER REQUIREMENTS).
7. PROVIDE ADDITIONAL POWER SUPPLIES, AMPLIFICATION AND BATTERY BACKUP TO SUPPORT NEW/ADDED DEVICES.
8. PROVIDE TEMPORARY HEAT DETECTORS AS REQUIRED BY LOCAL FIRE DEPARTMENT.
9. PROVIDE NEW AV DEVICES WITH INTEGRAL SYNCHRONIZATION CAPABILITIES AND/OR PROVIDE SYNCHRONIZATION MODULES FOR SYNCHRONIZATION OF ALL VISUAL DEVICES.
10. THE SCOPE OF THIS PROJECT SHALL IN NO WAY IMPACT THE DAILY OPERATION OR THE SEQUENCE OF OPERATION OF THE EXISTING FIRE ALARM SYSTEM.
11. PROVIDE ALL PROGRAMMING/RE-PROGRAMMING PER REVISED SPACE DESIGNATIONS.
12. PROVIDE ALL PRETESTS AND FINAL TESTS PER TOWN OF STONEHAM FIRE DEPARTMENT.
13. PROVIDE FIRE ALARM INTERFACE TO BRING ALL DIMMED LUMINAIRES TO FULL BRIGHTNESS UPON ALARM.
14. PROVIDE FIRE ALARM INTERFACE TO SHUNT ALL AV AND/OR SOUND EQUIPMENT.
15. PROVIDE FIRE ALARM INTERFACE TO RELEASE ALL SECURITY DEVICES.
16. A TAMPER SWITCH SHALL BE PROVIDED AT EACH ISOLATION CONTROL VALVE SERVING THE COMBINATION STAMPER/SPRINKLER SYSTEM. FOR MORE INFORMATION REFER TO THE FIRE PROTECTION DRAWINGS.
17. A FLOW AND SUPERVISORY SWITCH SHALL BE PROVIDED FOR EACH CONTROL VALVE ASSEMBLY. FOR MORE INFORMATION REFER TO THE FIRE PROTECTION DRAWINGS.

FIRE ALARM KEYNOTES:


- ◇ PROVIDE MONITOR RELAY MODULES TO MONITOR THE INPUTS OF THE VENTILATION CONTROL PANEL.

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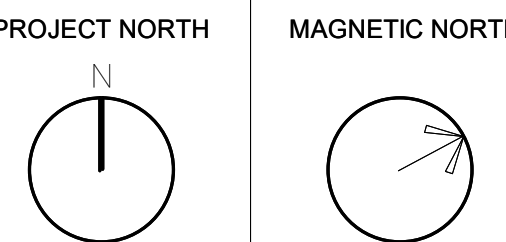
Wakefield, MA 01880

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SUBMISSION  
August 4th, 2022



KEY PLAN

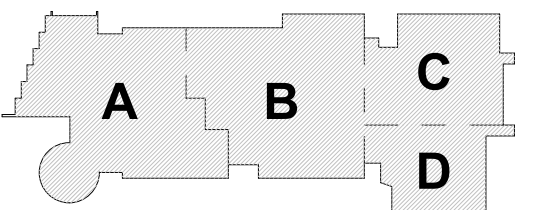

FIRE ALARM  
LOWER LEVEL  
FLOOR PLAN -  
AREA D

Scale: 1/8" = 1'-0"  
Job No.: 20202  
Drawn By: DRA  
Date: August 4th, 2022

FA1-1-0D









- GENERAL FIRE ALARM NOTES:**
1. PROVIDE A FULLY OPERATIONAL TEMPORARY FIRE ALARM SYSTEM DURING ALL WORK, APPROVED BY LOCAL FIRE DEPARTMENT. PROVIDE FIRE ALARM SYSTEM PROGRAMMING AND TESTING ACCORDING TO LOCAL FIRE DEPARTMENT REQUESTS. TEMPORARY SYSTEM SHALL REMAIN UNTIL NEW SYSTEM HAS BEEN APPROVED FOR OPERATION.
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  6. PROVIDE RACEWAY, CONDUCTORS AND CABLE, ASSOCIATED FITTINGS AND CONNECTORS, AND COMPLETE CONNECTIONS REQUIRED FOR DESIGNATED FIRE ALARM BRANCH CIRCUITS FROM DEVICES(S) TO FIRE ALARM TERMINAL CABINET(S) OR FIRE ALARM CONTROL PANEL OR FIRE COMMAND CENTER PER FIRE ALARM PRODUCT MANUFACTURER REQUIREMENTS.
  7. PROVIDE ADDITIONAL POWER SUPPLIES, AMPLIFICATION AND BATTERY BACKUP TO SUPPORT NEW/ADDED DEVICES.
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  11. PROVIDE ALL PROGRAMMING/RE-PROGRAMMING PER REVISED SPACE DESIGNATIONS.
  12. PROVIDE ALL PRETESTS AND FINAL TESTS PER TOWN OF STONEHAM FIRE DEPARTMENT.
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**1 FIRE ALARM FIRST FLOOR PLAN - AREA B**  
1/11/22 1/8" = 1'-0"

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August 4th, 2022

A B C

D

KEY PLAN

PROJECT NORTH

MAGNETIC NORTH

**FIRE ALARM  
FIRST FLOOR  
PLAN - AREA B**

Scale: 1/8" = 1'-0"

Job No.: 20022

Drawn By: DRA

Date: August 4th, 2022

**FA1-1-B**



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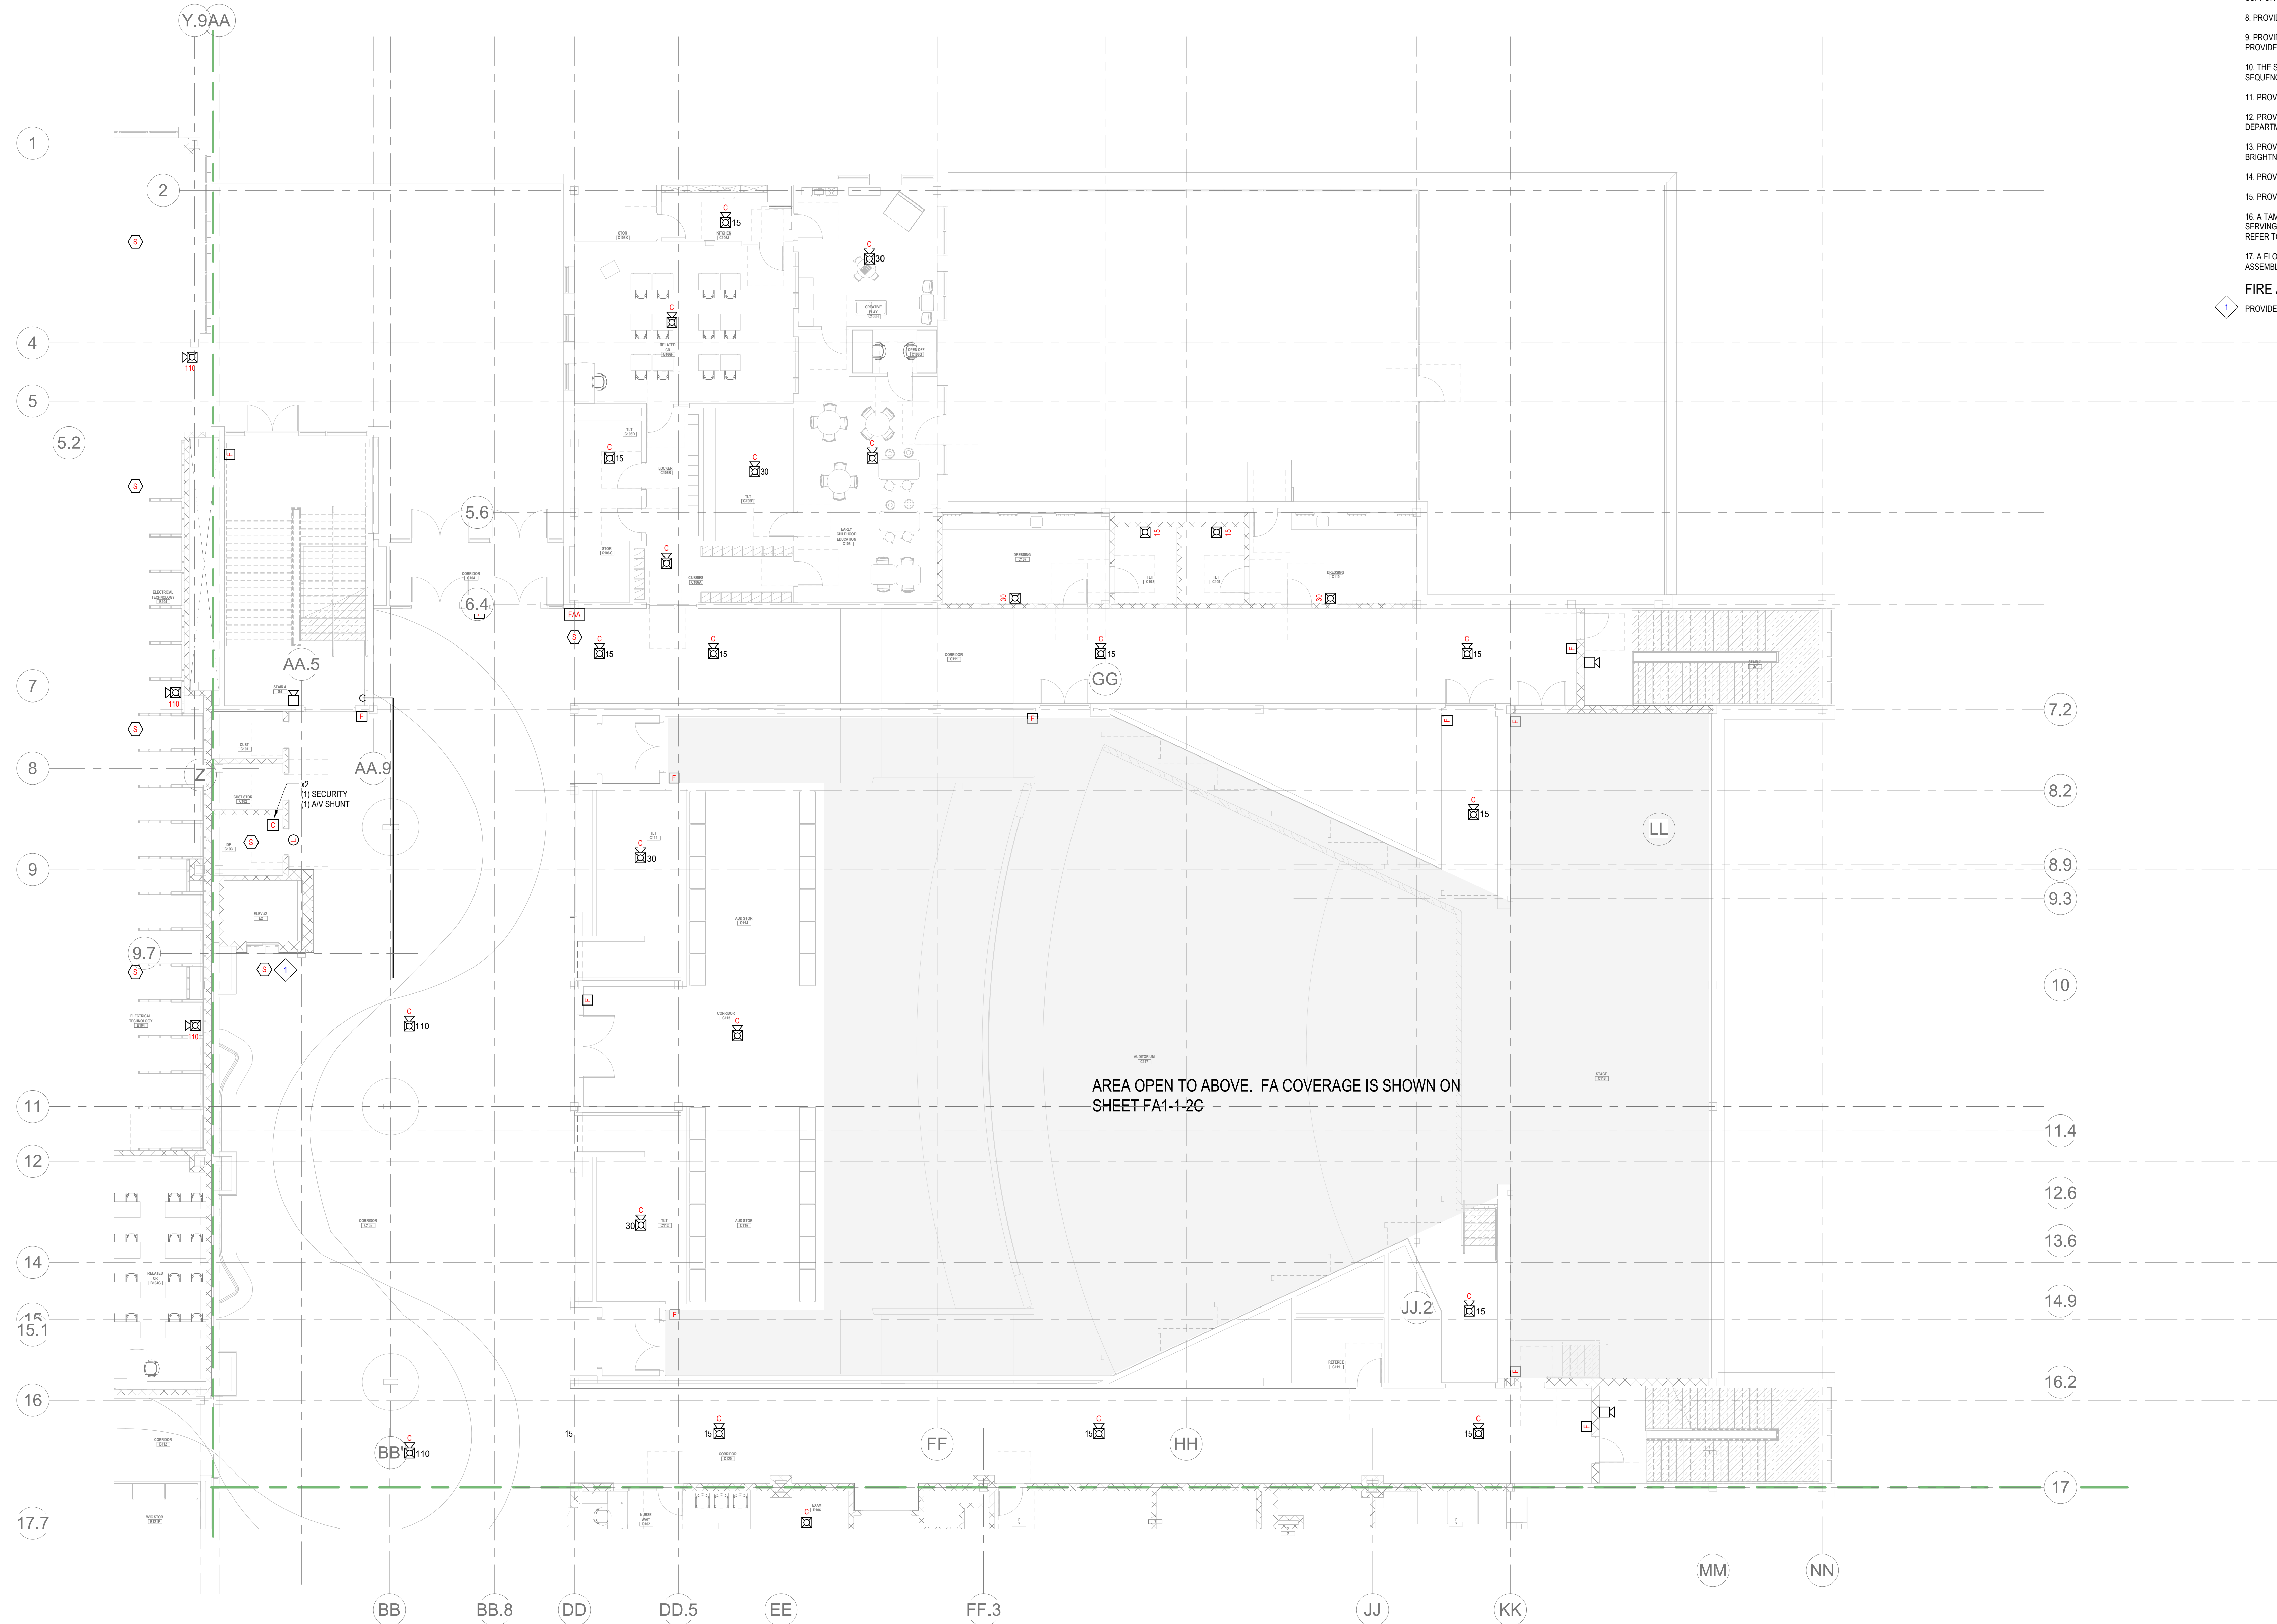
Wakefield, MA 01880

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5. MOUNTING HEIGHTS SHALL BE TO CENTER OF DEVICE OR EQUIPMENT, UNLESS OTHERWISE NOTED.
6. PROVIDE RACEWAY, CONDUCTORS AND CABLE, ASSOCIATED FITTINGS AND CONNECTORS, AND COMPLETE CONNECTIONS REQUIRED FOR DESIGNATED FIRE ALARM BRANCH CIRCUITS FROM DEVICES TO FIRE ALARM TERMINAL CABINET(S) OR FIRE ALARM CONTROL PANEL OR FIRE COMMAND CENTER PER FIRE ALARM PRODUCT MANUFACTURER REQUIREMENTS.
7. PROVIDE ADDITIONAL POWER SUPPLIES, AMPLIFICATION AND BATTERY BACKUP TO SUPPORT NEW/ADDED DEVICES.
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17. A FLOW AND SUPERVISORY SWITCH SHALL BE PROVIDED FOR EACH CONTROL VALVE ASSEMBLY. FOR MORE INFORMATION REFER TO THE FIRE PROTECTION DRAWINGS.

FIRE ALARM KEYNOTES:

- 1 PROVIDE SMOKE DETECTION TO INITIATE ELEVATOR RECALL.





1 FIRE ALARM FIRST FLOOR PLAN - AREA C  
1/8" = 1'-0"

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August 4th, 2022



FIRE ALARM  
FIRST FLOOR  
PLAN - AREA C

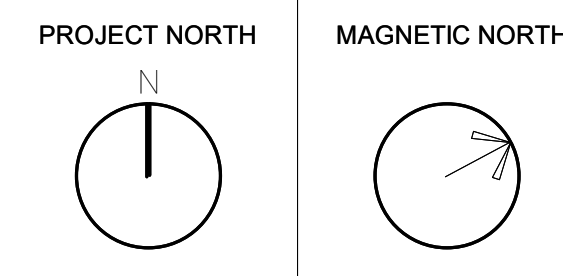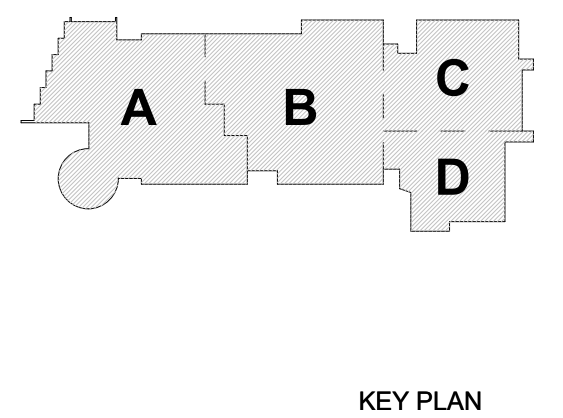Scale: 1/8" = 1'-0"  
Job No.: 20202  
Drawn By: DRA  
Date: August 4th, 2022  
FA1-1-1C





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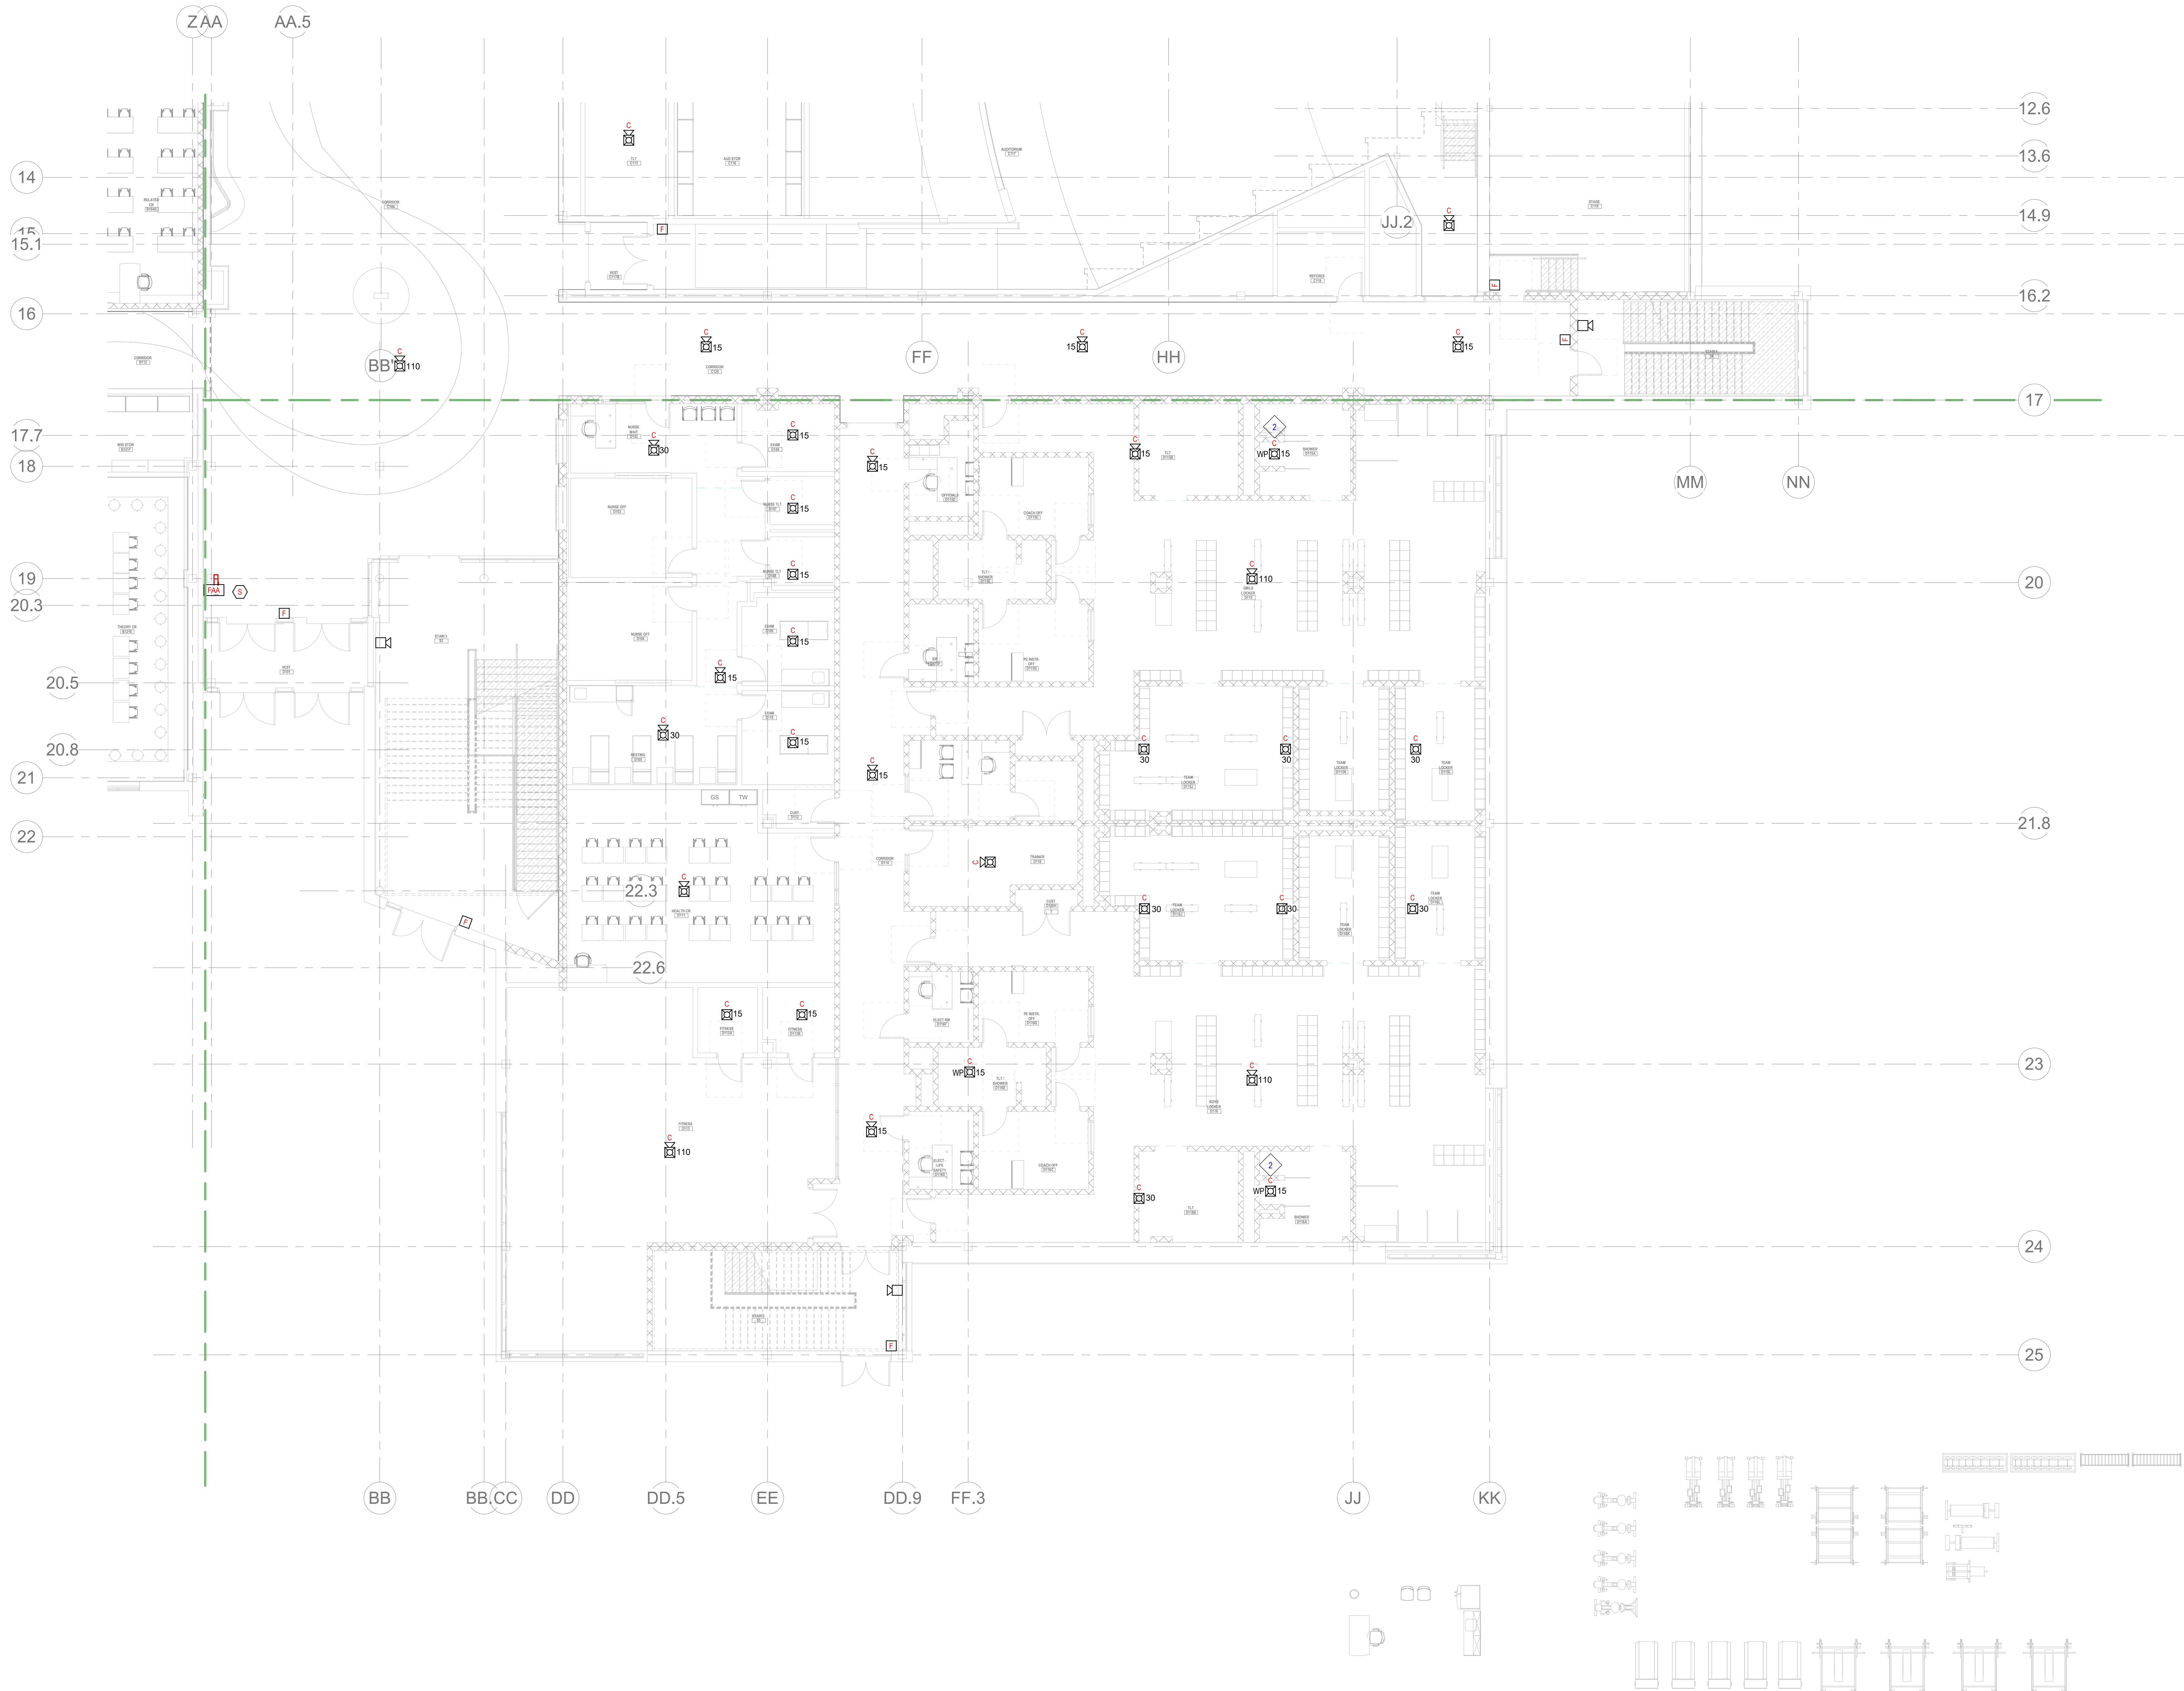
Wakefield, MA 01880

**GENERAL FIRE ALARM NOTES:**

1. PROVIDE A FULLY OPERATIONAL TEMPORARY FIRE ALARM SYSTEM DURING ALL WORK, APPROVED BY LOCAL FIRE DEPARTMENT. PROVIDE FIRE ALARM SYSTEM PROGRAMMING AND TESTING ACCORDING TO LOCAL FIRE DEPARTMENT REQUESTS. TEMPORARY SYSTEM SHALL REMAIN UNTIL NEW SYSTEM HAS BEEN APPROVED FOR OPERATION.
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6. PROVIDE RACEWAY, CONDUCTORS AND CABLE, ASSOCIATED FITTINGS AND CONNECTORS, AND COMPLETE CONNECTIONS REQUIRED FOR DESIGNATED FIRE ALARM BRANCH CIRCUITS FROM DEVICES TO FIRE ALARM TERMINAL CABINET(S) OR FIRE ALARM CONTROL PANEL OR FIRE COMMAND CENTER FOR FIRE ALARM PRODUCT MANUFACTURER REQUIREMENTS.
7. PROVIDE ADDITIONAL POWER SUPPLIES, AMPLIFICATION AND BATTERY BACKUP TO SUPPORT NONWAGED DEVICES.
8. PROVIDE TEMPORARY HEAT DETECTORS AS REQUIRED BY LOCAL FIRE DEPARTMENT.
9. PROVIDE NEW AV DEVICES WITH INTEGRAL SYNCHRONIZATION CAPABILITIES AND/OR PROVIDE SYNCHRONIZATION MODULES FOR SYNCHRONIZATION OF ALL VISUAL DEVICES.
10. THE SCOPE OF THIS PROJECT SHALL IN NO WAY IMPACT THE DAILY OPERATION OR THE SEQUENCE OF OPERATION OF THE EXISTING FIRE ALARM SYSTEM.
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17. A FLOW AND SUPERVISORY SWITCH SHALL BE PROVIDED FOR EACH CONTROL VALVE ASSEMBLY. FOR MORE INFORMATION REFER TO THE FIRE PROTECTION DRAWINGS.

**KEYNOTES:**

- 1 PROVIDE SMOKE DETECTOR TO INITIATE ELEVATOR RECALL.
- 2 PROVIDE WEATHER PROOF DEVICE NOTE.




**1 FIRE ALARM FIRST FLOOR PLAN - AREA D**  
1/8" = 1'-0"


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August 4th, 2022



**KEY PLAN**

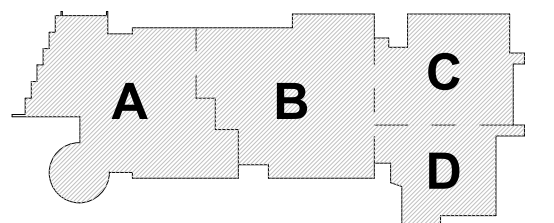

**FIRE ALARM  
FIRST FLOOR  
PLAN - AREA D**

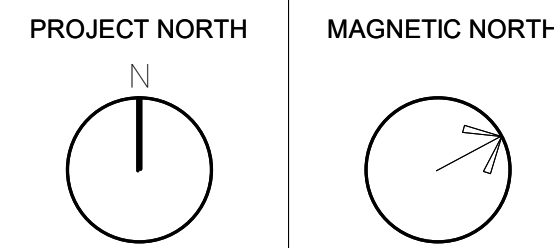
Scale: 1/8" = 1'-0"  
Job No.: 20202  
Drawn By: DRA  
Date: August 4th, 2022

**FA1-1-1D**




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Regional  
Vocational High  
School**

Wakefield, MA 01880
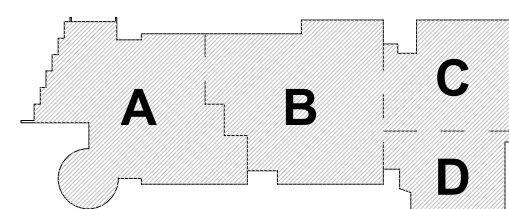
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DEVELOPMENT  
SUBMISSION**  
August 4th, 2022

KEY PLAN

PROJECT NORTH MAGNETIC NORTH

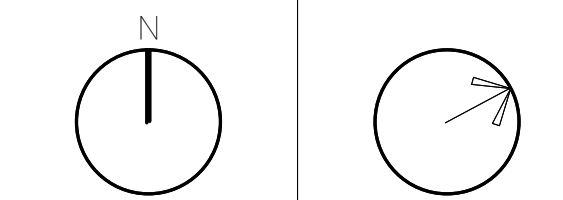**FIRE ALARM  
FIRST FLOOR  
MEZZANINE  
PLAN - AREA A**

Scale: 1" = 10'-0"


Job No.: 2002

Drawn By: DRA

Date: August 4th, 2022

**FA1-1-1MA****GENERAL FIRE ALARM NOTES:**

1. PROVIDE A FULLY OPERATIONAL TEMPORARY FIRE ALARM SYSTEM DURING ALL WORK, APPROVED BY LOCAL FIRE DEPARTMENT. PROVIDE FIRE ALARM SYSTEM PROGRAMMING AND TESTING ACCORDING TO LOCAL FIRE DEPARTMENT REQUESTS. TEMPORARY SYSTEM SHALL REMAIN UNTIL NEW SYSTEM HAS BEEN APPROVED FOR OPERATION.
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5. MOUNTING HEIGHTS SHALL BE TO CENTER OF DEVICE OR EQUIPMENT, UNLESS OTHERWISE NOTED.
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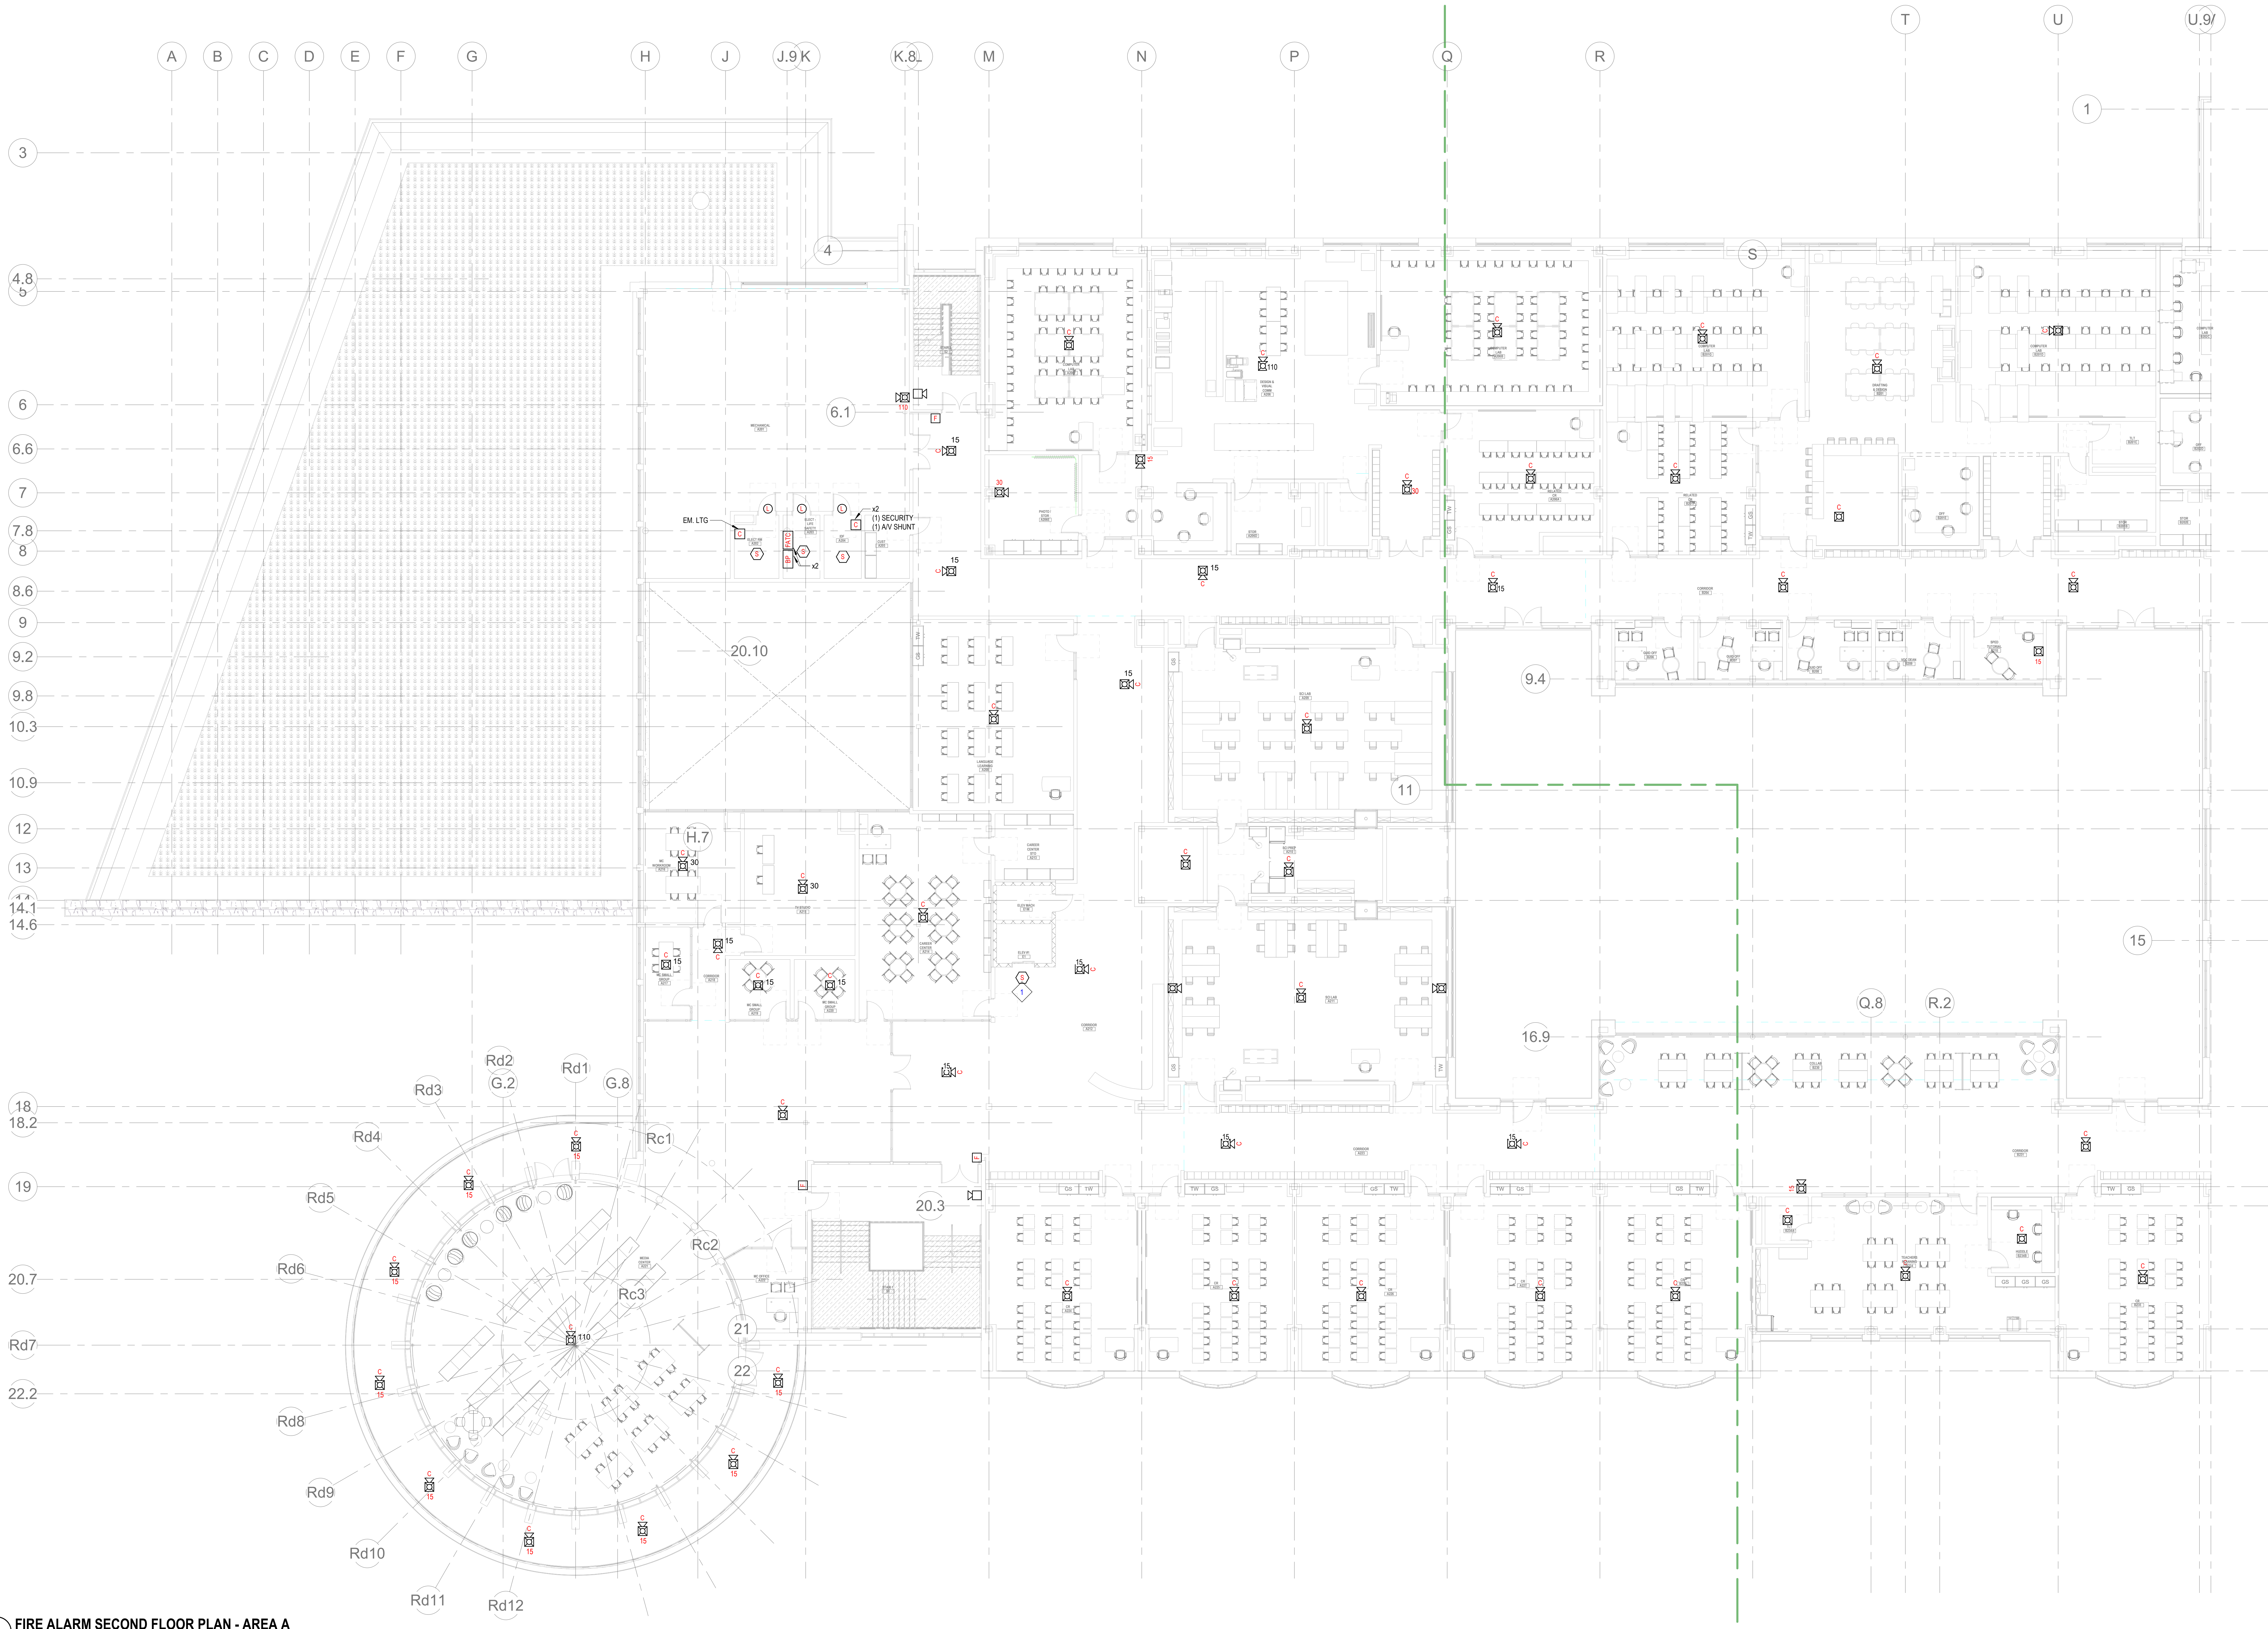


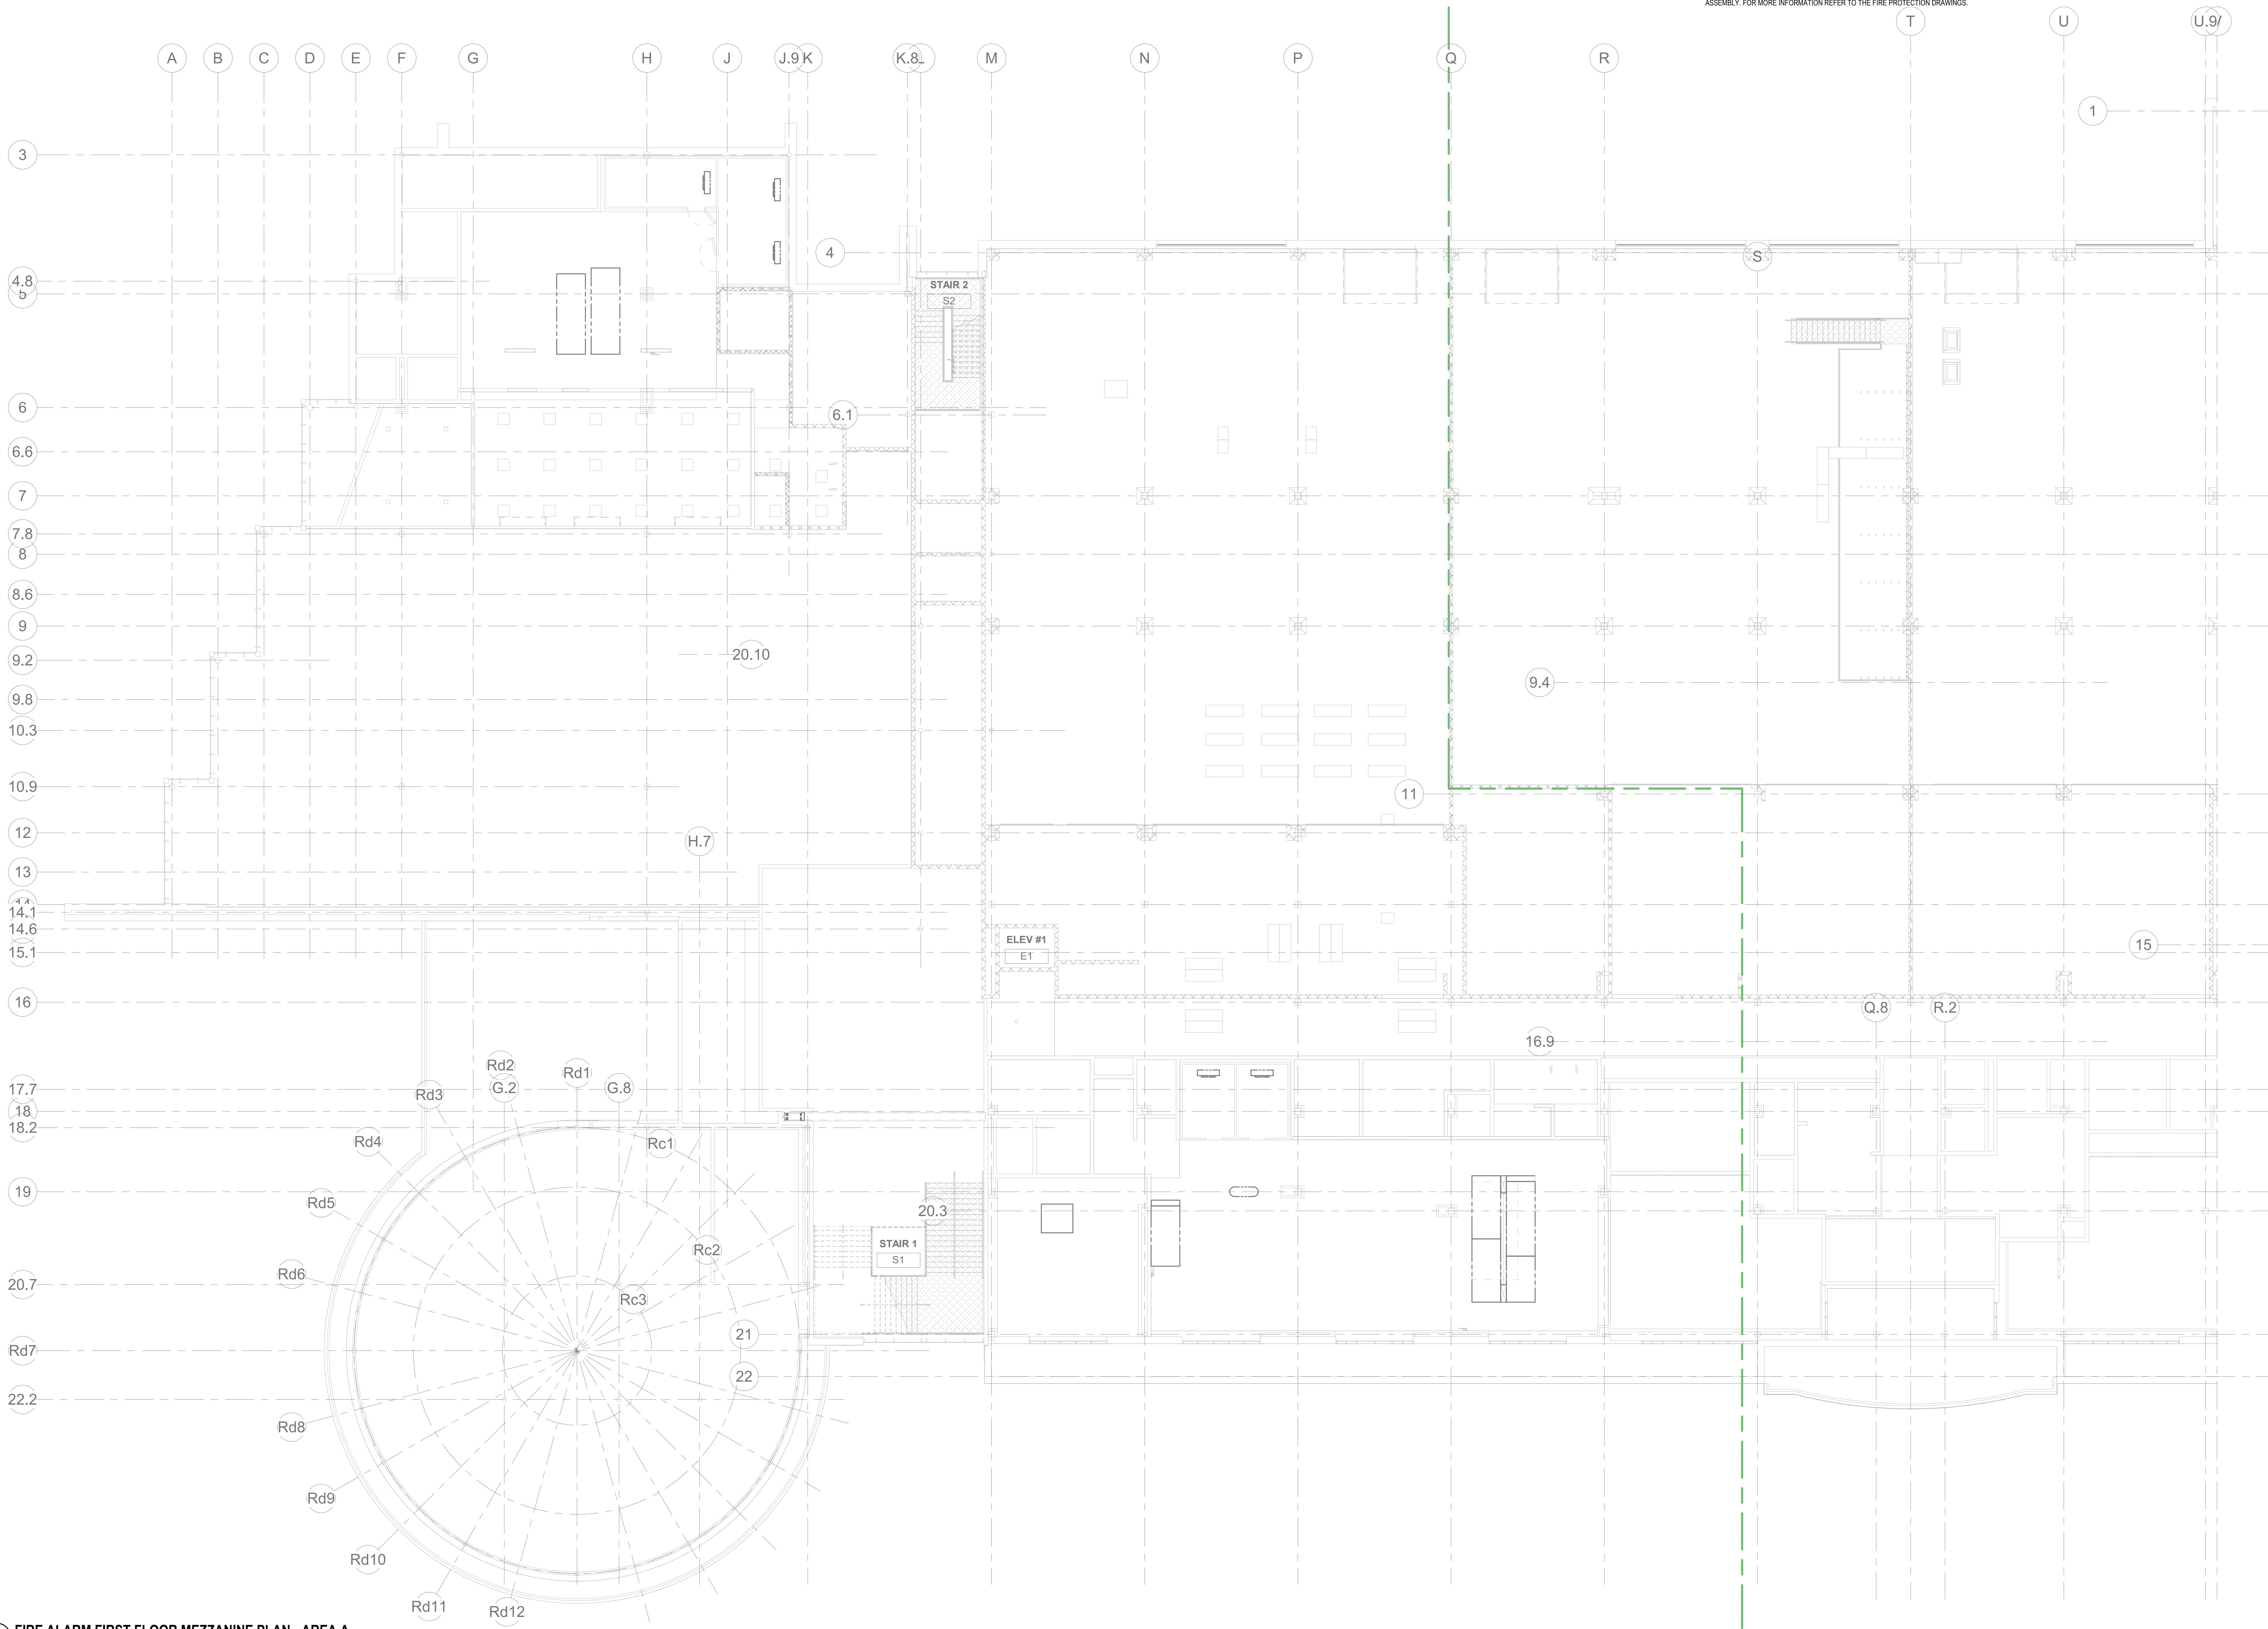GENERAL FIRE ALARM NOTES:

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12. PROVIDE ALL PRETESTS AND FINAL TESTS PER TOWN OF STONEHAM FIRE DEPARTMENT.
13. PROVIDE FIRE ALARM INTERFACE TO BRING ALL DIMMED LUMINAIRES TO FULL BRIGHTNESS UPON ALARM.
14. PROVIDE FIRE ALARM INTERFACE TO SHUNT ALL AV AND/OR SOUND EQUIPMENT.
15. PROVIDE FIRE ALARM INTERFACE TO RELEASE ALL SECURITY DEVICES.
16. A TAMPER SWITCH SHALL BE PROVIDED AT EACH ISOLATION CONTROL VALVE SERVING THE COMBINATION STANDPIPE/SPRINKLER SYSTEM. FOR MORE INFORMATION REFER TO THE FIRE PROTECTION DRAWINGS.
17. A FLOW AND SUPERVISORY SWITCH SHALL BE PROVIDED FOR EACH CONTROL VALVE ASSEMBLY. FOR MORE INFORMATION REFER TO THE FIRE PROTECTION DRAWINGS.

FIRE ALARM KEYNOTES:

1. PROVIDE SMOKE DETECTION TO INITIATE ELEVATOR RECALL.



1 FIRE ALARM SECOND FLOOR PLAN - AREA A  
KAL:JSA 1" = 10'-0"

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A B C  
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KEY PLAN


PROJECT NORTH MAGNETIC NORTH

FIRE ALARM  
SECOND FLOOR  
PLAN - AREA A

Scale: 1" = 10'-0"  
Job No.: 20202  
Drawn By: DRA  
Date: August 4th, 2022

FA1-1-2A



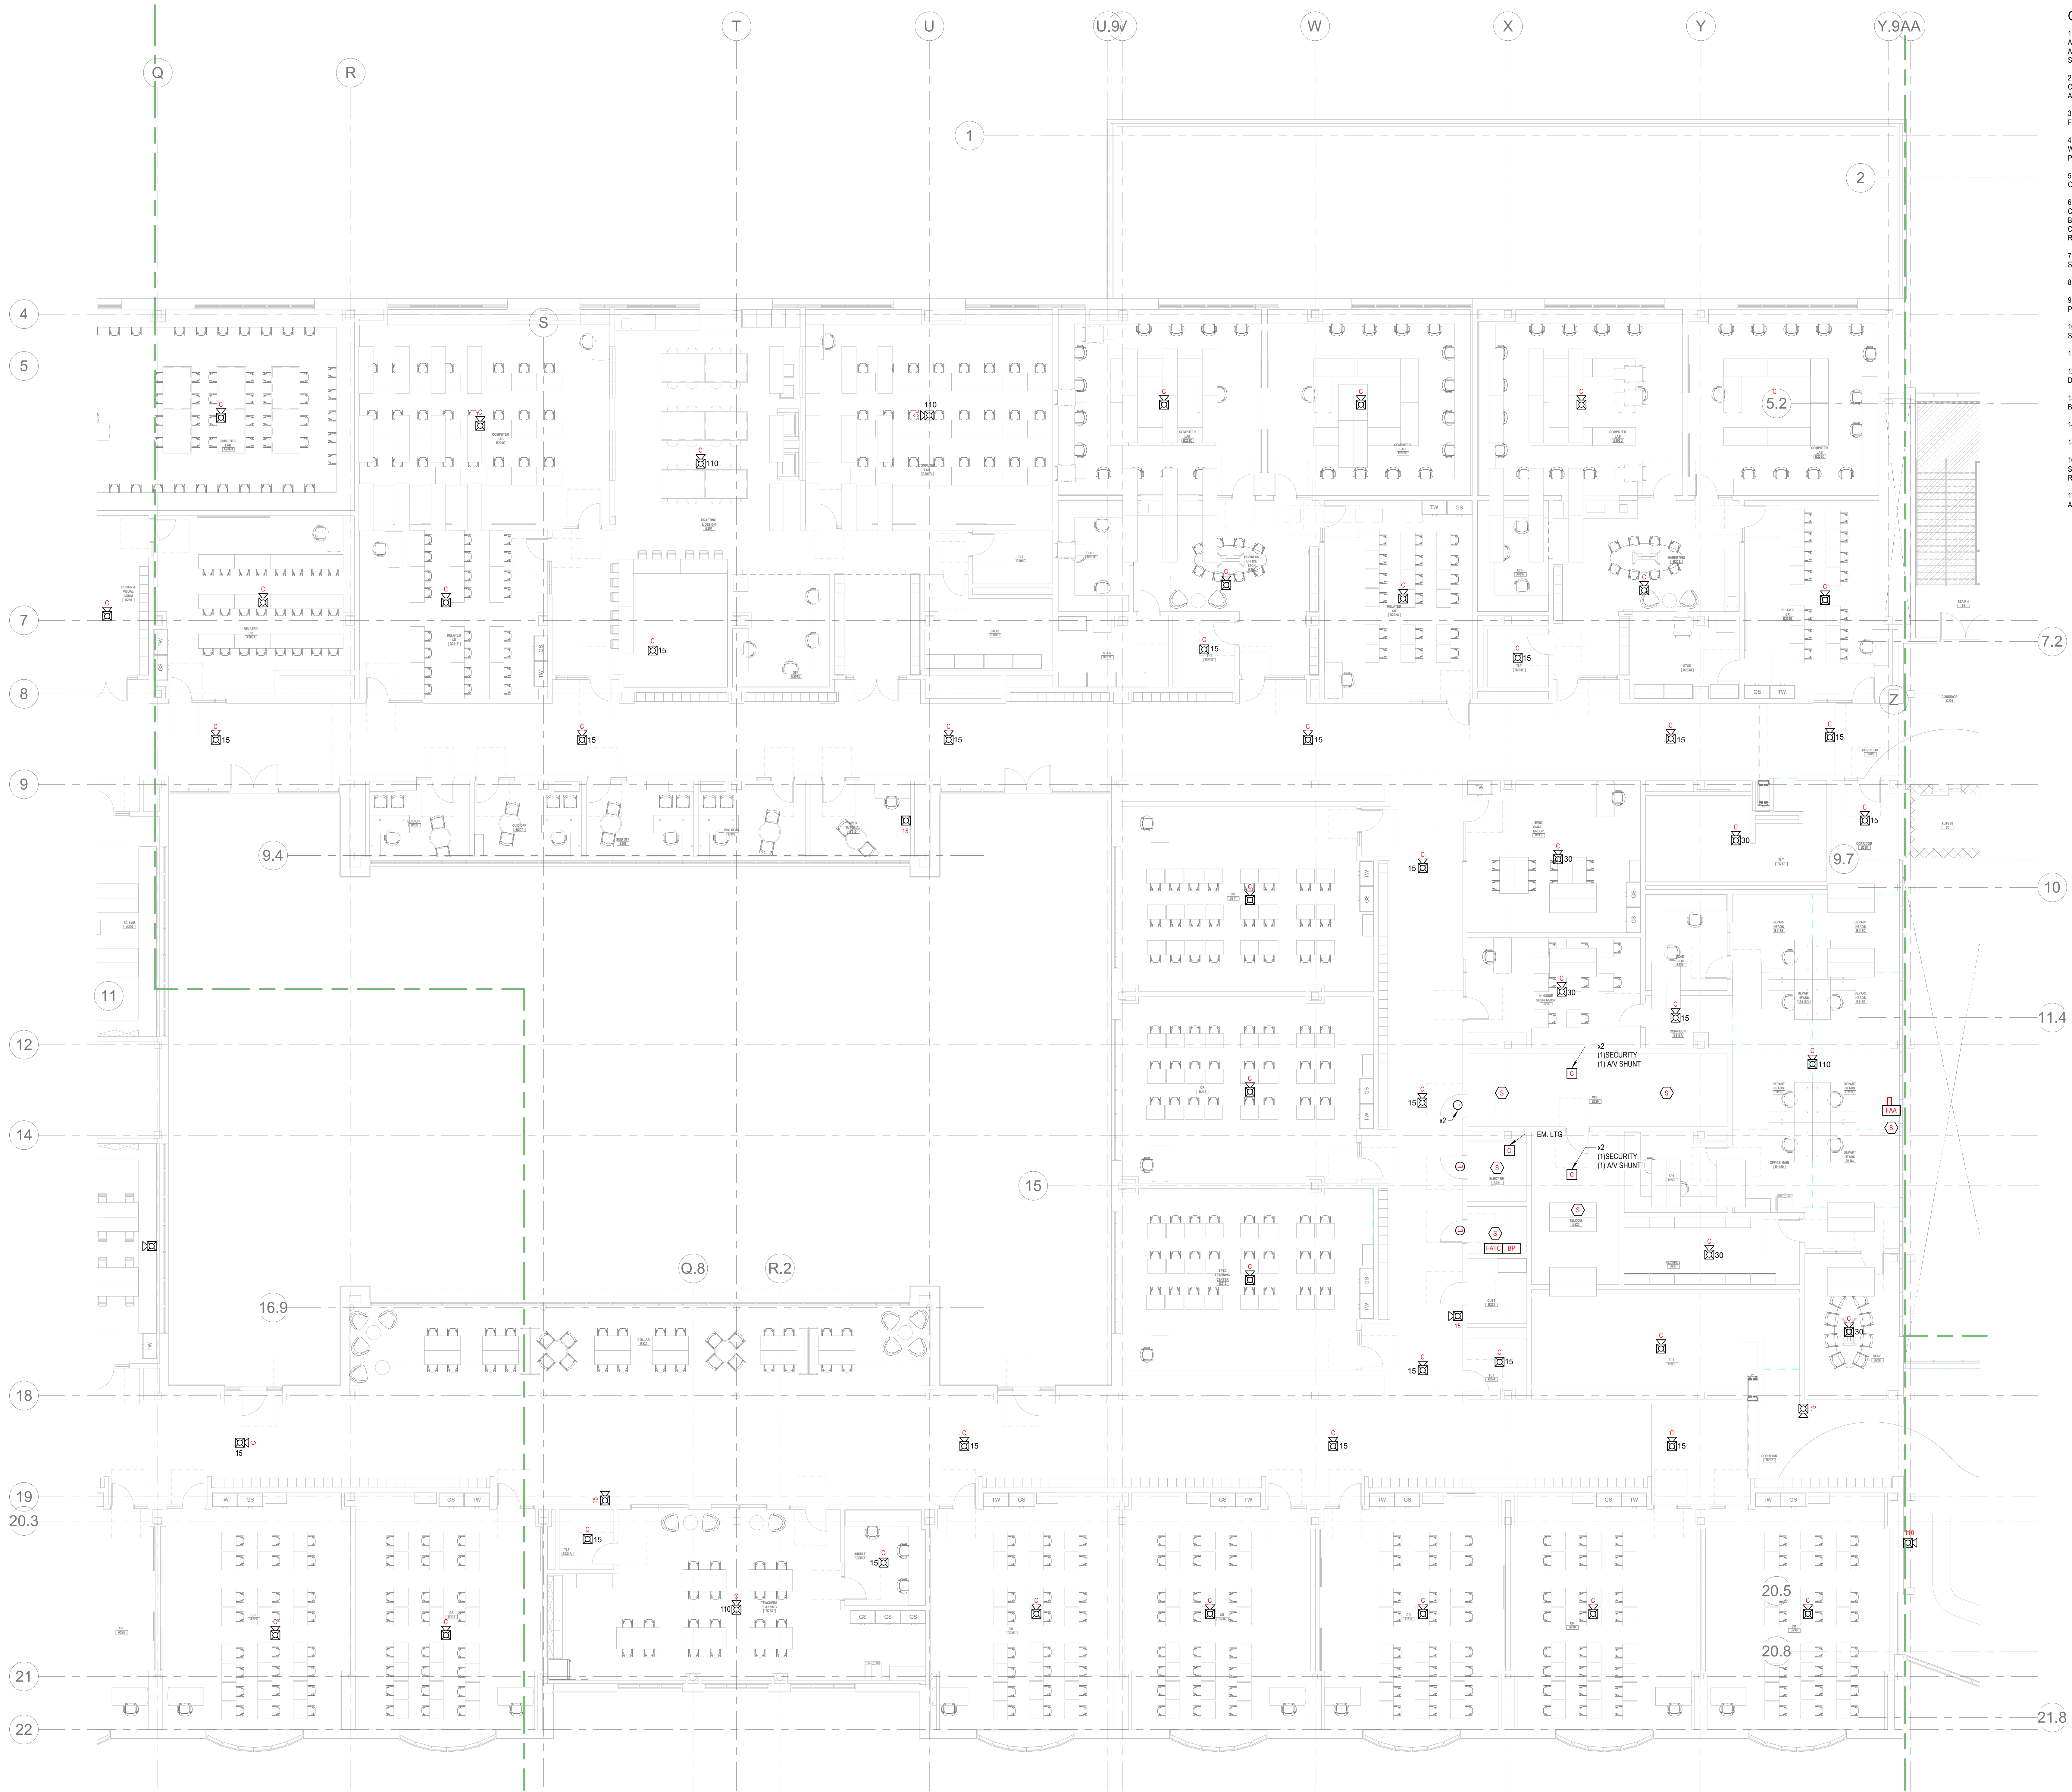

- GENERAL FIRE ALARM NOTES:**
1. PROVIDE A FULLY OPERATIONAL TEMPORARY FIRE ALARM SYSTEM DURING ALL WORK, APPROVED BY LOCAL FIRE DEPARTMENT. PROVIDE FIRE ALARM SYSTEM PROGRAMMING AND TESTING ACCORDING TO LOCAL FIRE DEPARTMENT REQUESTS. TEMPORARY SYSTEM SHALL REMAIN UNTIL NEW SYSTEM HAS BEEN APPROVED FOR OPERATION.
  2. COORDINATE LOCATION OF FIRE ALARM APPLIANCES AND DEVICES IN AREAS WITH CEILING SYSTEM, DUCTWORK, FIXTURES, FURNITURE, AND OTHER EQUIPMENT PRIOR TO ALL WORK.
  3. FINAL LOCATIONS AND ARRANGEMENTS OF FIRE ALARM DEVICES SHALL BE OBTAINED FROM THE ARCHITECTURAL REFLECTED CEILING PLAN AND ELEVATION VIEWS.
  4. FOR EXACT LOCATIONS OF SMOKE/FIRE DAMPERS, DUCT MOUNTED SMOKE DETECTORS, WATER FLOW SWITCHES AND VALVE TAMPER SWITCHES, REFER TO FIRE PROTECTION, PLUMBING AND MECHANICAL/MEV DRAWINGS.
  5. MOUNTING HEIGHTS SHALL BE TO CENTER OF DEVICE OR EQUIPMENT, UNLESS OTHERWISE NOTED.
  6. PROVIDE RACEWAY, CONDUCTORS AND CABLE, ASSOCIATED FITTINGS AND CONNECTORS, AND COMPLETE CONNECTIONS REQUIRED FOR DESIGNATED FIRE ALARM BRANCH CIRCUITS FROM DEVICES TO FIRE ALARM TERMINAL CABINETS (OR FIRE ALARM CONTROL PANEL OR FIRE COMMAND CENTER PER FIRE ALARM PRODUCT MANUFACTURER REQUIREMENTS).
  7. PROVIDE ADDITIONAL POWER SUPPLIES, AMPLIFICATION AND BATTERY BACKUP TO SUPPORT NEW/ADOPTED DEVICES.
  8. PROVIDE TEMPORARY HEAT DETECTORS AS REQUIRED BY LOCAL FIRE DEPARTMENT.
  9. PROVIDE NEW AV DEVICES WITH INTEGRAL SYNCHRONIZATION CAPABILITIES AND/OR PROVIDE SYNCHRONIZATION MODULES FOR SYNCHRONIZATION OF ALL VISUAL DEVICES.
  10. THE SCOPE OF THIS PROJECT SHALL IN NO WAY IMPACT THE DAILY OPERATION OR THE SEQUENCE OF OPERATION OF THE EXISTING FIRE ALARM SYSTEM.
  11. PROVIDE ALL PROGRAMMING/RE-PROGRAMMING PER REVISED SPACE DESIGNATIONS.
  12. PROVIDE ALL PRETESTS AND FINAL TESTS PER TOWN OF STONEHAM FIRE DEPARTMENT.
  13. PROVIDE FIRE ALARM INTERFACE TO BRING ALL DIMMED LUMINAIRES TO FULL BRIGHTNESS UPON ALARM.
  14. PROVIDE FIRE ALARM INTERFACE TO SHUNT ALL AV AND/OR SOUND EQUIPMENT.
  15. PROVIDE FIRE ALARM INTERFACE TO RELEASE ALL SECURITY DEVICES.
  16. A TAMPER SWITCH SHALL BE PROVIDED AT EACH ISOLATION CONTROL VALVE SERVING THE COMBINATION STANDPIPE/SPRINKLER SYSTEM. FOR MORE INFORMATION REFER TO THE FIRE PROTECTION DRAWINGS.
  17. A FLOW AND SUPERVISORY SWITCH SHALL BE PROVIDED FOR EACH CONTROL VALVE ASSEMBLY. FOR MORE INFORMATION REFER TO THE FIRE PROTECTION DRAWINGS.

**FIRE ALARM SECOND FLOOR PLAN - AREA B**  
1/11-1/20 1/8" = 1'-0"

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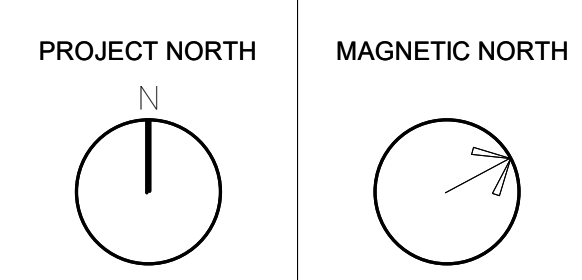
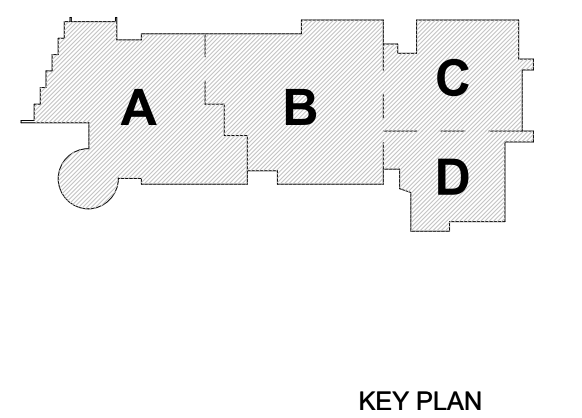
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August 4th, 2022



**FIRE ALARM  
SECOND FLOOR  
PLAN - AREA B**

Scale: 1/8" = 1'-0"  
Job No.: 20202  
Drawn By: DRA  
Date: August 4th, 2022

**FA1-1-2B**



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1. PROVIDE A FULLY OPERATIONAL TEMPORARY FIRE ALARM SYSTEM DURING ALL WORK. PROVIDE BY LOCAL FIRE DEPARTMENT. PROVIDE FIRE ALARM SYSTEM PROGRAMMING TO THE FIRE DEPARTMENT. PROVIDE FIRE DEPARTMENT REQUESTS. TEMPORARY SYSTEM SHALL REMAIN UNTIL NEW SYSTEM HAS BEEN APPROVED FOR OPERATION.
2. COORDINATE LOCATION OF FIRE ALARM APPLIANCES AND DEVICES IN AREAS WITH CEILING SYSTEM, DUCTWORK, FIXTURES, FURNITURE, AND OTHER EQUIPMENT PRIOR TO ALL WORK.
3. FINAL LOCATIONS AND ARRANGEMENTS OF FIRE ALARM DEVICES SHALL BE OBTAINED FROM THE ARCHITECTURAL REFLECTED CEILING PLAN AND ELEVATION VIEWS.
4. FOR EXACT LOCATIONS OF SMOKE/FIRE DAMPERS, DUCT-MOUNTED SMOKE DETECTOR LOCATIONS, EXHAUST FAN LOCATIONS, EXHAUST FAN EXITS, REFER TO FIRE PROTECTION, PLUMBING AND MECHANICAL/HVAC DRAWINGS.
5. MOUNTING HEIGHTS SHALL BE TO CENTER OF DEVICE OR EQUIPMENT, UNLESS OTHERWISE NOTED.

6. PROVIDE RACEWAY, CONDUITS AND CABLE ASSOCIATED FITTINGS AND CONNECTIONS TO THE FIRE ALARM CONTROL PANEL AND/OR DISASSOCIATED FIRE ALARM BRANCH CIRCUITS FROM THE FIRE ALARM TERMINAL CABBINETS (OR THE FIRE ALARM CONTROL PANEL OR THE COMMAND CENTER PER FIRE ALARM PRODUCT MANUFACTURER'S REQUIREMENTS).
7. PROVIDE ADDITIONAL POWER SUPPLIES, AMPLIFICATION AND BATTERY BACKUP TO SUPPORT NOTIFIED DEVICES.
8. PROVIDE TEMPORARY HAND DETECTORS AS REQUIRED BY LOCAL FIRE DEPARTMENT.
9. PROVIDE NEW ALV DEVICES WITH INTEGRAL SYNCHRONIZATION CAPABILITIES AND/OR PROVIDE SYNCHRONIZATION MODULES FOR SYNCHRONIZATION OF ALL VISUAL DEVICES.
10. THE SCOPE OF THIS PROJECT SHALL IN NO WAY IMPACT THE DAILY OPERATION OR THE EXISTING PERFORMANCE OF THE EXISTING FIRE ALARM SYSTEM.
11. PROVIDE ALL PROGRAMMING/PROGRAMMING PER REVISED SCENE DESIGNATIONS.
12. PROVIDE ALL PRETESTS AND FINAL TESTS PER TYPE OF STATION/HIRE FIRE DEPARTMENT.
13. PROVIDE FIRE ALARM INTERFACE TO BRING ALL DIMMED ILLUMINATIONS TO FULL BRIGHTNESS UPON ALARM.
14. PROVIDE FIRE ALARM INTERFACE TO SHUNT ALL ALV AND SOUND EQUIPMENT.
15. PROVIDE FIRE ALARM INTERFACE TO RELEASE ALL SECURITY DEVICES.
16. A TAMPER SWITCH SHALL BE PROVIDED AT EACH ISOLATION CONTROL VALVE SERVING THE COMBINATION STANDPIPE/SPRINKLER SYSTEM FOR MORE INFORMATION REFER TO THE DRAWING.
17. LOW AND SUPERVISORY SIGNAL SHALL BE PROVIDED FOR EACH CONTROL VALVE ASSIGNED TO THE COMBINATION STANDPIPE/SPRINKLER SYSTEM FOR MORE INFORMATION REFER TO THE FIRE PROTECTION DRAWINGS.

① PROVIDE SMOKE DETECTION TO INITIATE ELEVATOR RECALL



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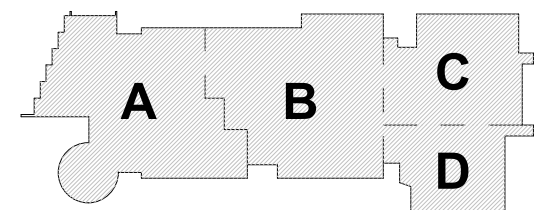
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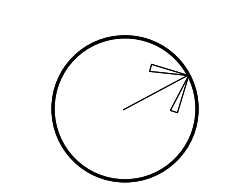
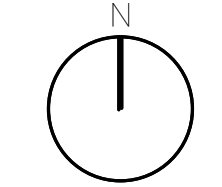
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August 4th, 2022



### KEY PLAN

PROJECT NORTH


MAGNETIC NORTH



Scale: 1/8" = 1'-0"  
Job No.: 20202  
Drawn By: DR  
Date: August 4th, 2020

FA1-1-2C



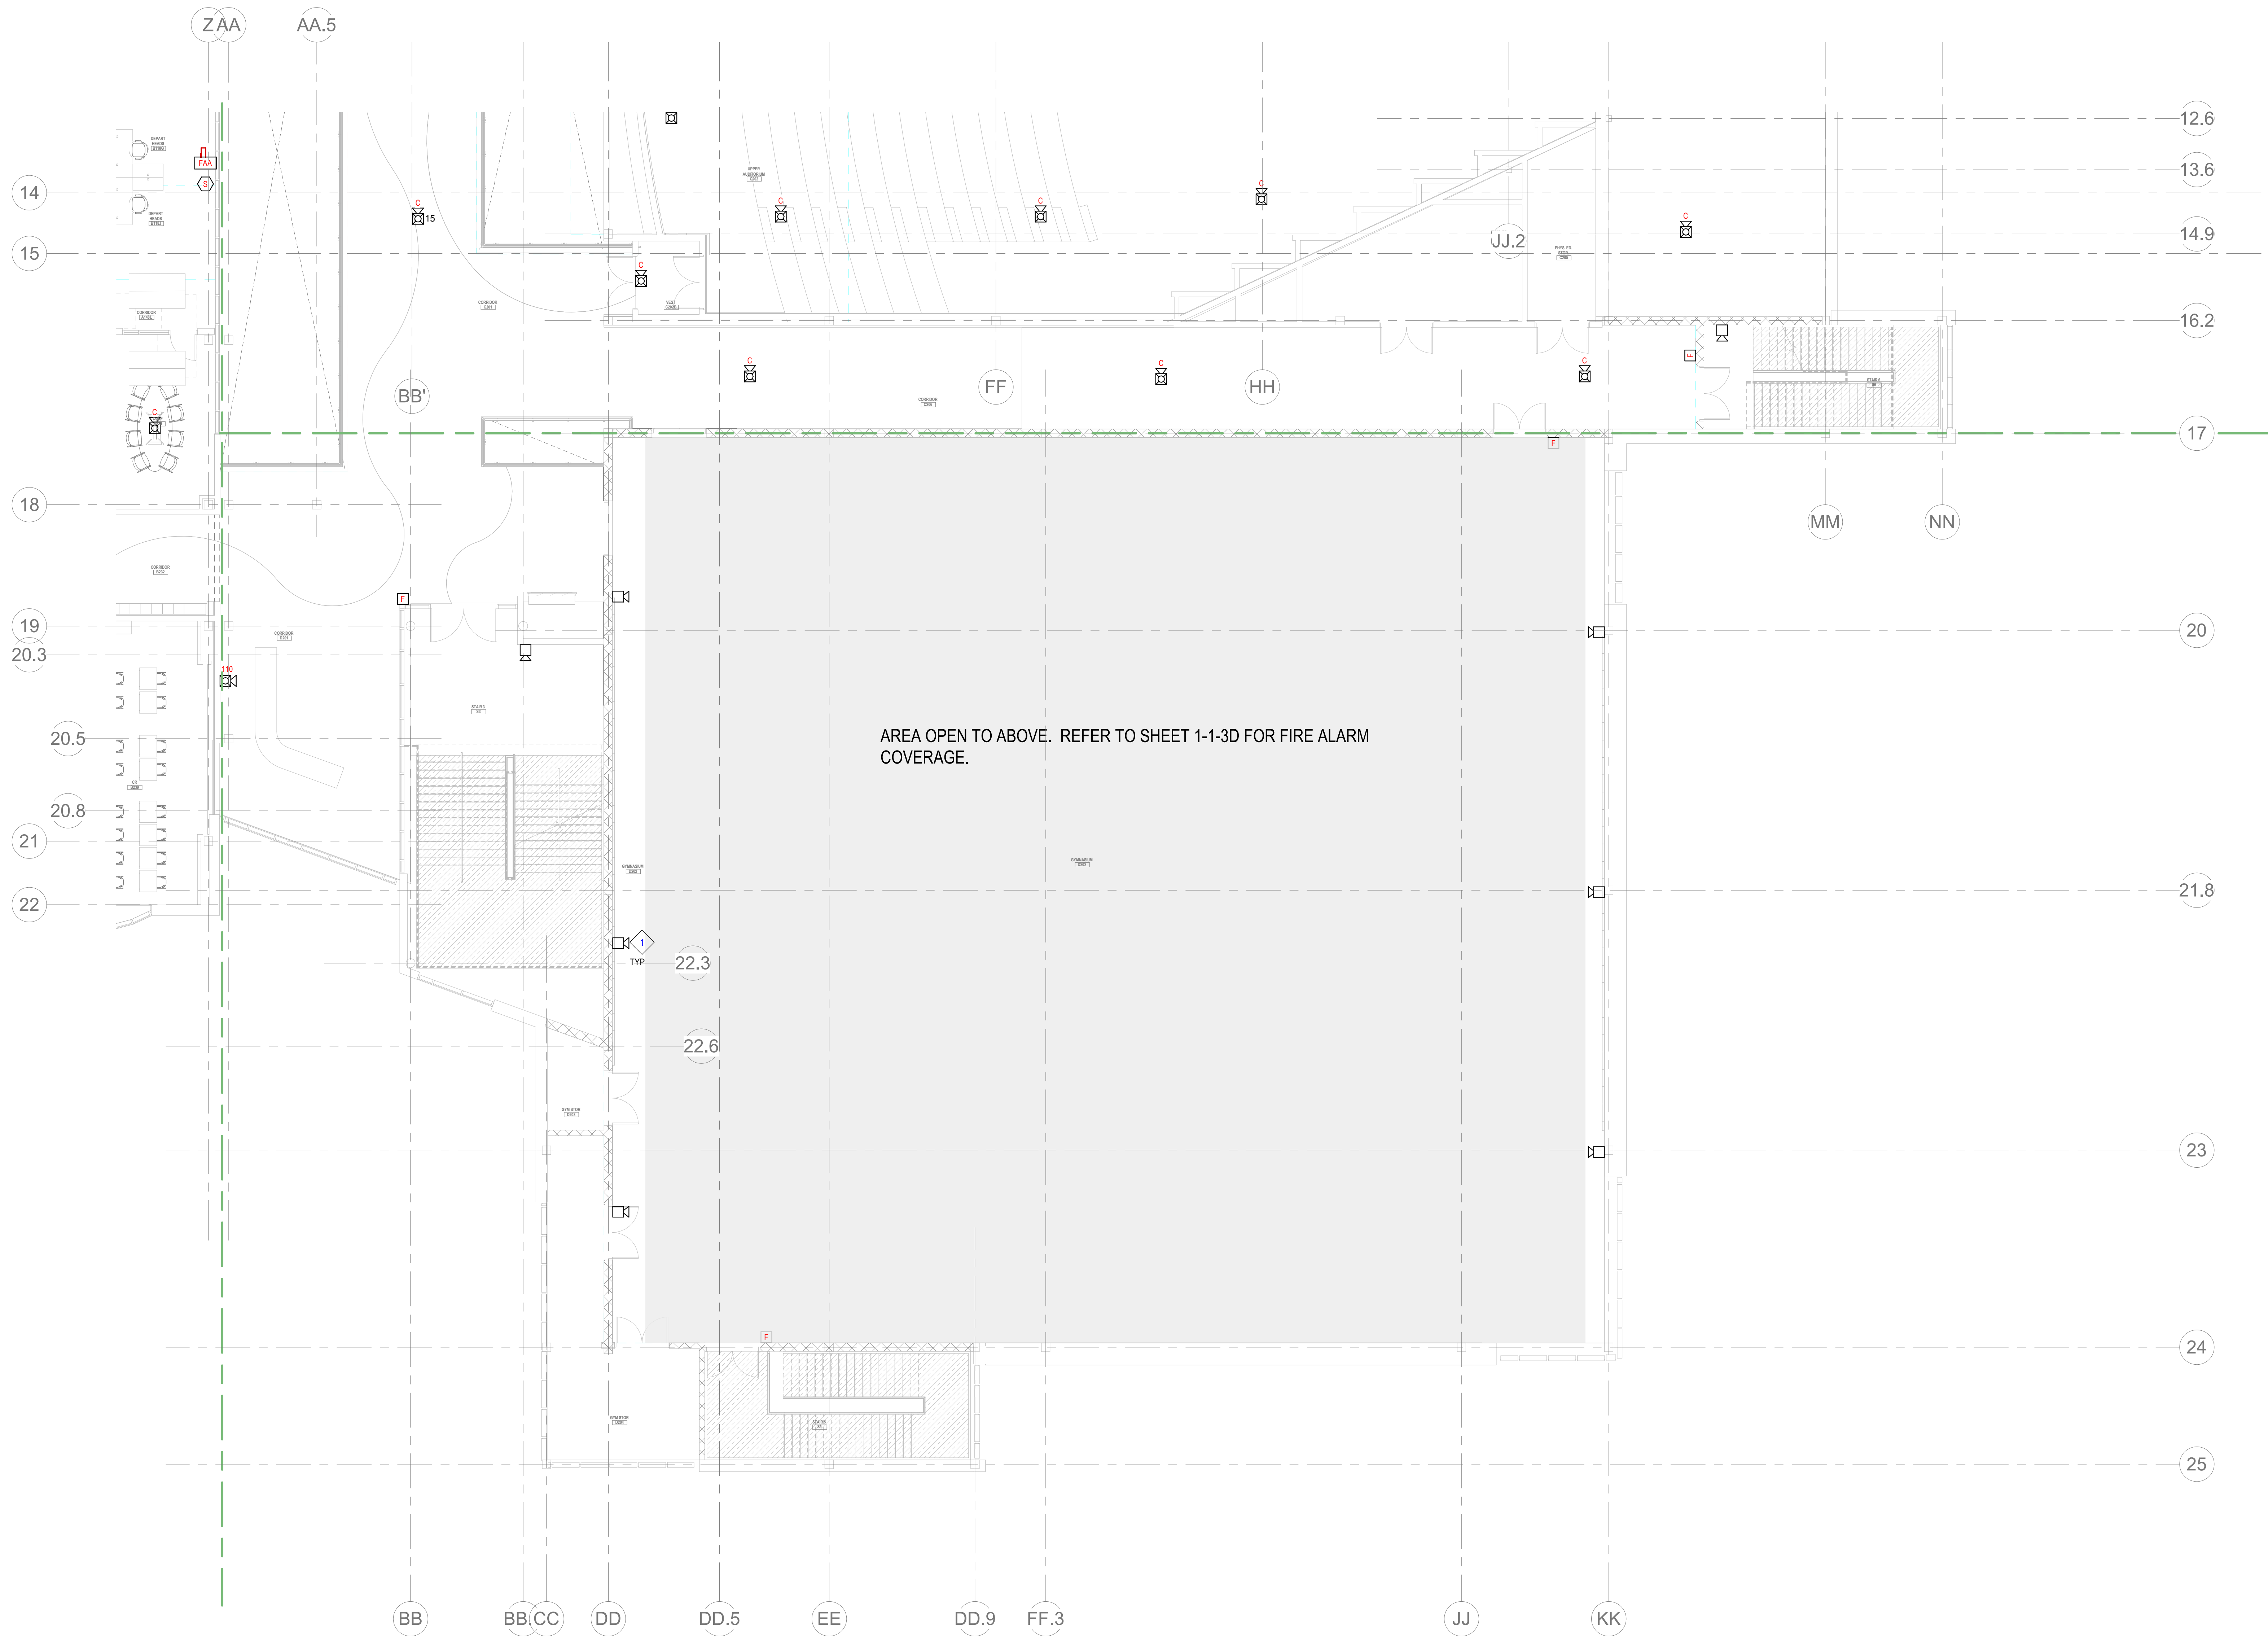

GENERAL FIRE ALARM NOTES:

1. PROVIDE A FULLY OPERATIONAL TEMPORARY FIRE ALARM SYSTEM DURING ALL WORK, APPROVED BY LOCAL FIRE DEPARTMENT. PROVIDE FIRE ALARM SYSTEM PROGRAMMING AND TESTING ACCORDING TO LOCAL FIRE DEPARTMENT REQUESTS. TEMPORARY SYSTEM SHALL REMAIN UNTIL NEW SYSTEM HAS BEEN APPROVED FOR OPERATION.
2. COORDINATE LOCATION OF FIRE ALARM APPLIANCES AND DEVICES IN AREAS WITH CEILING SYSTEM, DUCTWORK, FIXTURES, FURNITURE, AND OTHER EQUIPMENT PRIOR TO ALL WORK.
3. FINAL LOCATIONS AND ARRANGEMENTS OF FIRE ALARM DEVICES SHALL BE OBTAINED FROM THE ARCHITECTURAL REFLECTED CEILING PLAN AND ELEVATION VIEWS.
4. FOR EXACT LOCATIONS OF SMOKE/FIRE DAMPERS, DUCT-MOUNTED SMOKE DETECTORS, WATER FLOW SWITCHES AND VALVE TAMPER SWITCHES, REFER TO FIRE PROTECTION, PLUMBING AND MECHANICAL/PLUMBING DRAWINGS.
5. MOUNTING HEIGHTS SHALL BE TO CENTER OF DEVICE OR EQUIPMENT, UNLESS OTHERWISE NOTED.
6. PROVIDE RACEWAY, CONDUCTORS AND CABLE, ASSOCIATED FITTINGS AND CONNECTORS, AND COMPLETE CONNECTIONS REQUIRED FOR DESIGNATED FIRE ALARM BRANCH CIRCUITS FROM DEVICES TO FIRE ALARM TERMINAL CABINETS (OR FIRE ALARM CONTROL PANEL OR FIRE COMMAND CENTER PER FIRE ALARM PRODUCT MANUFACTURER REQUIREMENTS).
7. PROVIDE ADDITIONAL POWER SUPPLIES, AMPLIFICATION AND BATTERY BACKUP TO SUPPORT NEW/ADDED DEVICES.
8. PROVIDE TEMPORARY HEAT DETECTORS AS REQUIRED BY LOCAL FIRE DEPARTMENT.
9. PROVIDE NEW AV DEVICES WITH INTEGRAL SYNCHRONIZATION CAPABILITIES AND/OR PROVIDE SYNCHRONIZATION MODULES FOR SYNCHRONIZATION OF ALL VISUAL DEVICES.
10. THE SCOPE OF THIS PROJECT SHALL IN NO WAY IMPACT THE DAILY OPERATION OR THE SEQUENCE OF OPERATION OF THE EXISTING FIRE ALARM SYSTEM.
11. PROVIDE ALL PROGRAMMING/RE-PROGRAMMING PER REVISED SPACE DESIGNATIONS.
12. PROVIDE ALL PRETESTS AND FINAL TESTS PER TOWN OF STONEHAM FIRE DEPARTMENT.
13. PROVIDE FIRE ALARM INTERFACE TO BRING ALL DIMMED LUMINAIRES TO FULL BRIGHTNESS UPON ALARM.
14. PROVIDE FIRE ALARM INTERFACE TO SHUNT ALL AV AND/OR SOUND EQUIPMENT.
15. PROVIDE FIRE ALARM INTERFACE TO RELEASE ALL SECURITY DEVICES.
16. A TAMPER SWITCH SHALL BE PROVIDED AT EACH ISOLATION CONTROL VALVE SERVING THE COMBINATION STANDPIPE/SPRINKLER SYSTEM. FOR MORE INFORMATION REFER TO THE FIRE PROTECTION DRAWINGS.
17. A FLOW AND SUPERVISORY SWITCH SHALL BE PROVIDED FOR EACH CONTROL VALVE ASSEMBLY. FOR MORE INFORMATION REFER TO THE FIRE PROTECTION DRAWINGS.

FIRE ALARM KEYNOTES:

1. PROVIDE TCPA-10 SINGLE COIL HYPERSPIKE MEDIUM POWERED SIGNALING AND NOTIFICATION SPEAKER. COORDINATE WITH MANUFACTURER'S HYPERSPIKE. CONTRACTOR SHALL COORDINATE THE MOUNTING HEIGHTS OF THE HYPERSPIKE SPEAKER WITH THE ARCHITECT.



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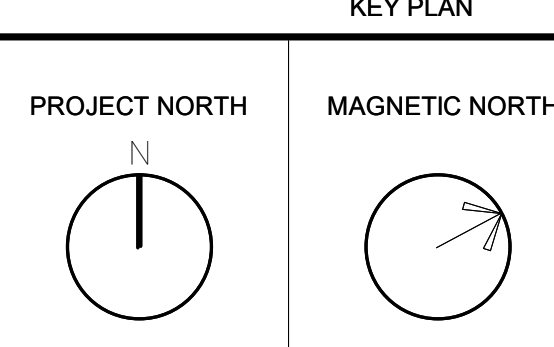
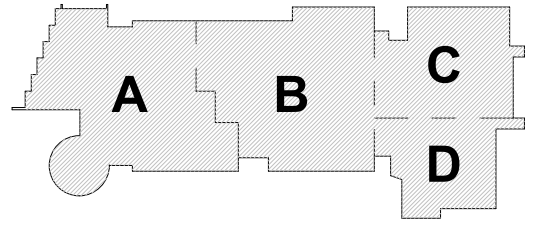
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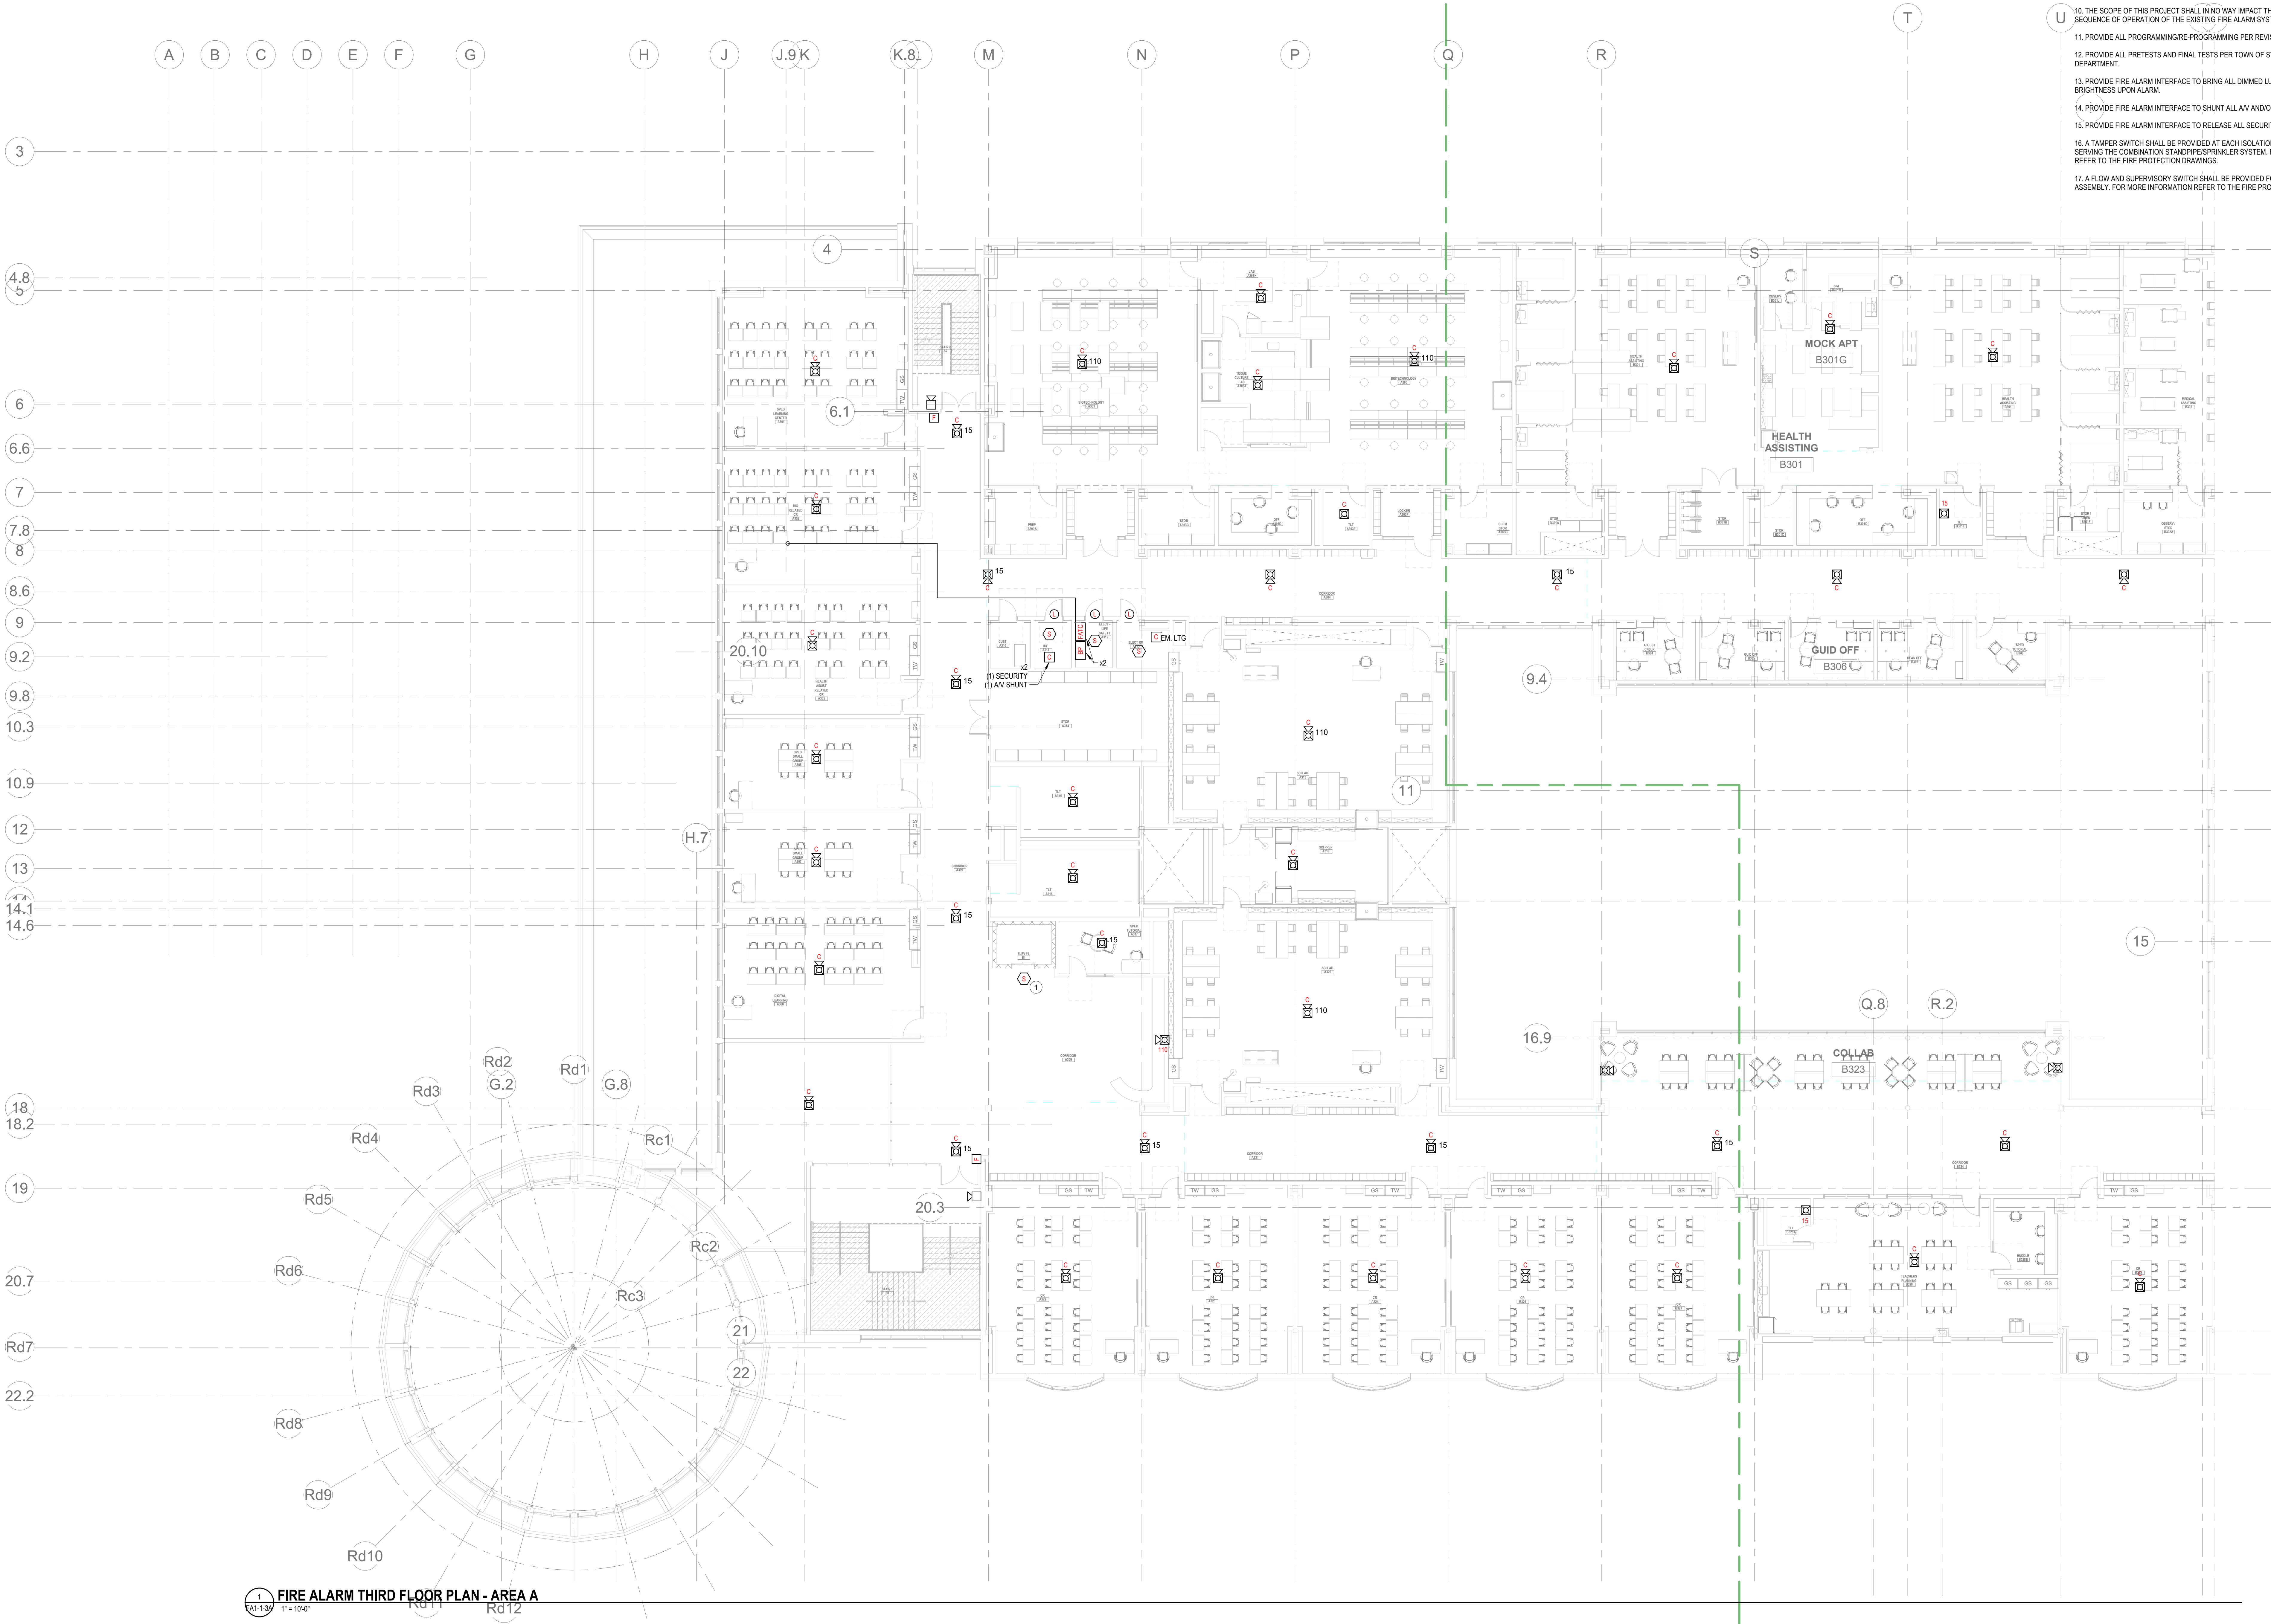


FIRE ALARM  
SECOND FLOOR  
PLAN - AREA D

Scale: 1/8" = 1'-0"  
Job No.: 20202  
Drawn By: DRA  
Date: August 4th, 2022  
FA1-1-2D

1  
FA1-1-2D  
FIRE ALARM SECOND FLOOR PLAN - AREA D  
1/8" = 1'-0"





1 FIRE ALARM THIRD FLOOR PLAN - AREA A  
A1-13A 1" = 10'-0"

FIRE ALARM KEYNOTES:

1. PROVIDE SMOKE DETECTION TO INITIATE ELEVATOR RECALL

GENERAL FIRE ALARM NOTES:

1. PROVIDE A FULLY OPERATIONAL TEMPORARY FIRE ALARM SYSTEM DURING ALL WORK, APPROVED BY LOCAL FIRE DEPARTMENT. PROVIDE FIRE ALARM SYSTEM PROGRAMMING AND TESTING ACCORDING TO LOCAL FIRE DEPARTMENT REQUESTS. TEMPORARY SYSTEM SHALL REMAIN UNTIL NEW SYSTEM HAS BEEN APPROVED FOR OPERATION.
2. COORDINATE LOCATION OF FIRE ALARM APPLIANCES AND DEVICES IN AREAS WITH CEILING SYSTEM, DUCTWORK, FIXTURES, FURNITURE, AND OTHER EQUIPMENT PRIOR TO ALL WORK.
3. FINAL LOCATIONS AND ARRANGEMENTS OF FIRE ALARM DEVICES SHALL BE OBTAINED FROM THE ARCHITECTURAL REFLECTED CEILING PLAN AND ELEVATION VIEWS.
4. FOR EXACT LOCATIONS OF SMOKE/FIRE DAMPERS, DUCT-MOUNTED SMOKE DETECTORS, WATER FLOW SWITCHES AND VALVE TAMPER SWITCHES, REFER TO FIRE PROTECTION, PLUMBING AND MECHANICAL/HVAC DRAWINGS.
5. MOUNTING HEIGHTS SHALL BE TO CENTER OF DEVICE OR EQUIPMENT, UNLESS OTHERWISE NOTED.
6. PROVIDE RACEWAY, CONDUCTORS AND CABLE, ASSOCIATED FITTINGS AND CONNECTORS, AND COMPLETE CONNECTIONS REQUIRED FOR DESIGNATED FIRE ALARM BRANCH CIRCUITS FROM DEVICES TO FIRE ALARM TERMINAL CABINETS OR FIRE ALARM CONTROL PANEL OR FIRE COMMAND CENTER PER FIRE ALARM PRODUCT MANUFACTURER REQUIREMENTS.
7. PROVIDE ADDITIONAL POWER SUPPLIES, AMPLIFICATION AND BATTERY BACKUP TO SUPPORT NEW/EXISTING DEVICES.
8. PROVIDE TEMPORARY HEAT DETECTORS AS REQUIRED BY LOCAL FIRE DEPARTMENT.
9. PROVIDE NEW AV DEVICES WITH INTEGRAL SYNCHRONIZATION CAPABILITIES AND/OR PROVIDE SYNCHRONIZATION MODULES FOR SYNCHRONIZATION OF ALL VISUAL DEVICES.
10. THE SCOPE OF THIS PROJECT SHALL IN NO WAY IMPACT THE DAILY OPERATION OR THE SEQUENCE OF OPERATION OF THE EXISTING FIRE ALARM SYSTEM.
11. PROVIDE ALL PROGRAMMING/RE-PROGRAMMING PER REVISED SPACE DESIGNATIONS.
12. PROVIDE ALL PRETESTS AND FINAL TESTS PER TOWN OF STONEHAM FIRE DEPARTMENT.
13. PROVIDE FIRE ALARM INTERFACE TO BRING ALL DIMMED LUMINAIRES TO FULL BRIGHTNESS UPON ALARM.
14. PROVIDE FIRE ALARM INTERFACE TO SHUNT ALL AV AND/OR SOUND EQUIPMENT.
15. PROVIDE FIRE ALARM INTERFACE TO RELEASE ALL SECURITY DEVICES.
16. A TAMPER SWITCH SHALL BE PROVIDED AT EACH ISOLATION CONTROL VALVE SERVING THE COMBINATION STANDPIPE/SPRINKLER SYSTEM. FOR MORE INFORMATION REFER TO THE FIRE PROTECTION DRAWINGS.
17. A FLOW AND SUPERVISORY SWITCH SHALL BE PROVIDED FOR EACH CONTROL VALVE ASSEMBLY. FOR MORE INFORMATION REFER TO THE FIRE PROTECTION DRAWINGS.

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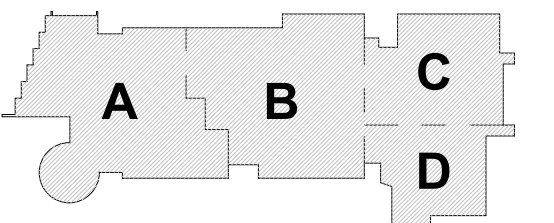
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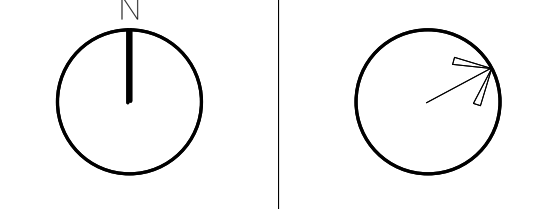
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KEY PLAN

PROJECT NORTH MAGNETIC NORTH




FIRE ALARM  
THIRD FLOOR  
PLAN - AREA A

Scale: 1" = 10'-0"  
Job No.: 20202  
Drawn By: DRA  
Date: August 4th, 2022

FA1-13A



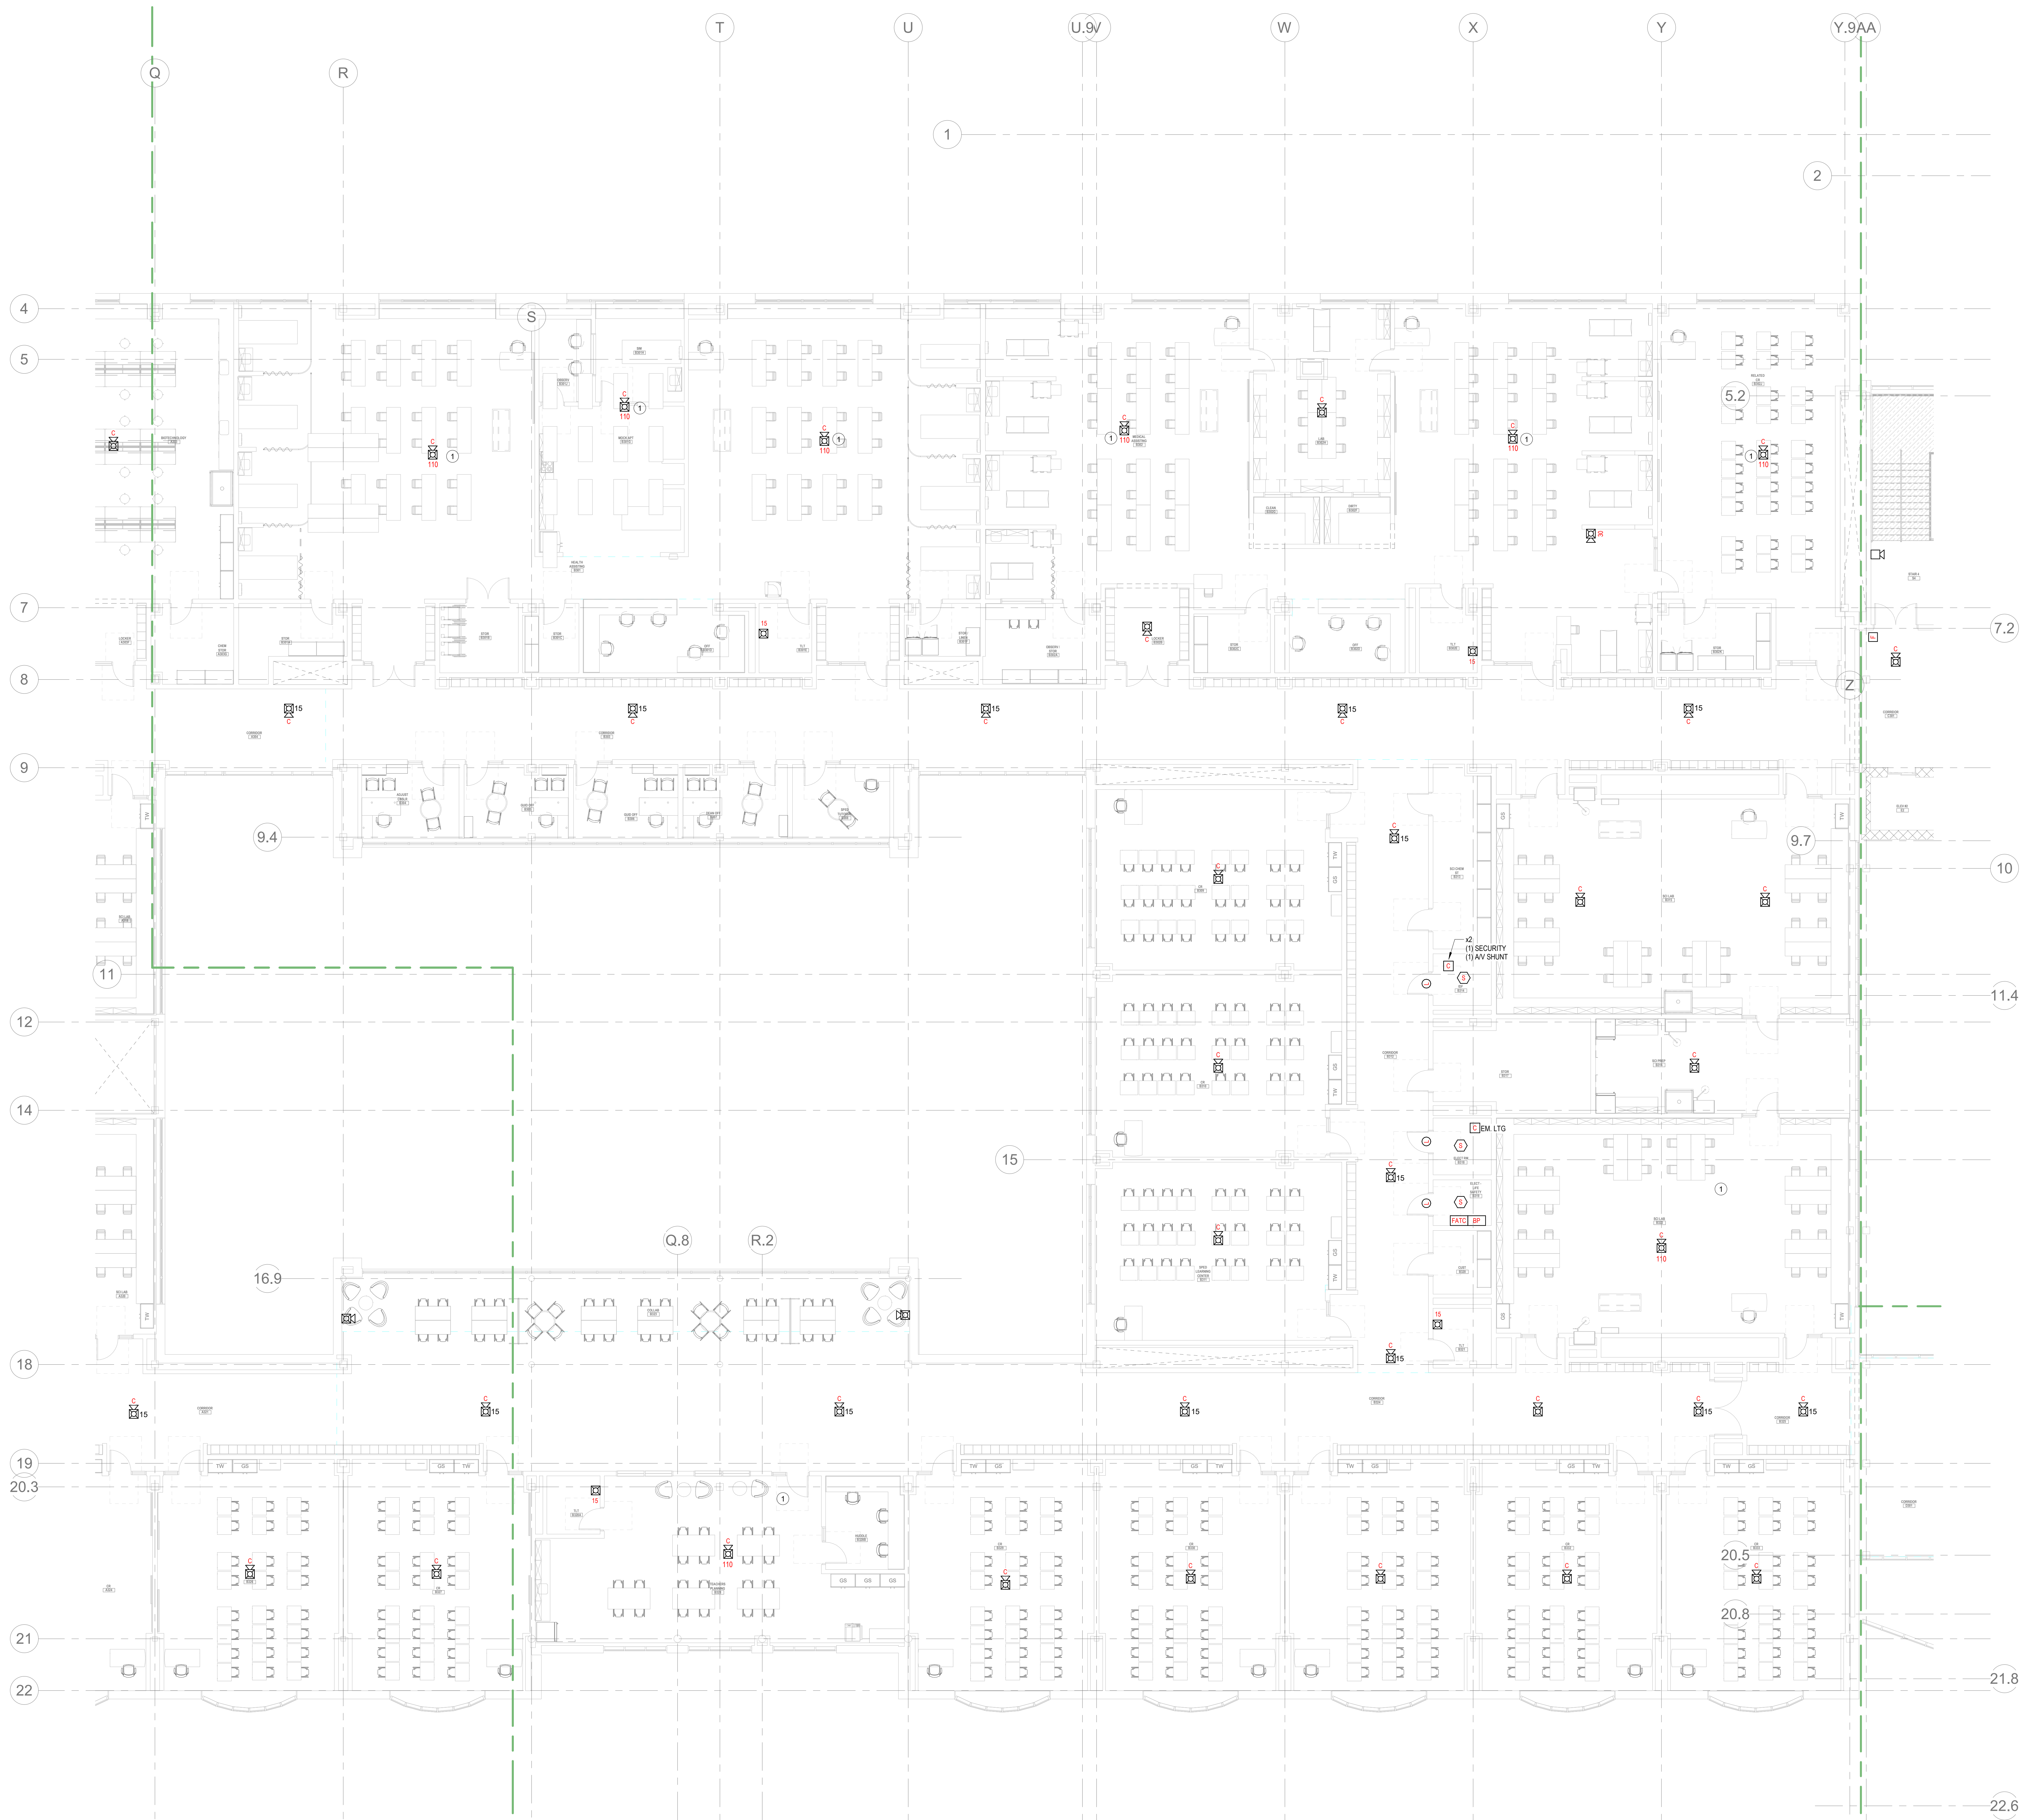

- GENERAL FIRE ALARM NOTES:**
1. PROVIDE A FULLY OPERATIONAL TEMPORARY FIRE ALARM SYSTEM DURING ALL WORK APPROVED BY LOCAL FIRE DEPARTMENT. PROVIDE FIRE ALARM SYSTEM PROGRAMMING AND TESTING ACCORDING TO LOCAL FIRE DEPARTMENT REQUESTS. TEMPORARY SYSTEM SHALL REMAIN UNTIL NEW SYSTEM HAS BEEN APPROVED FOR OPERATION.
  2. COORDINATE LOCATION OF FIRE ALARM APPLIANCES AND DEVICES IN AREAS WITH CEILING SYSTEM, DUCTWORK, FIXTURES, FURNITURE, AND OTHER EQUIPMENT PRIOR TO ALL WORK.
  3. FINAL LOCATIONS AND ARRANGEMENTS OF FIRE ALARM DEVICES SHALL BE OBTAINED FROM THE ARCHITECTURAL, REFLECTED CEILING PLAN AND ELEVATION VIEWS.
  4. FOR EXACT LOCATIONS OF SMOKE/FIRE DAMPERS, DUCT MOUNTED SMOKE DETECTORS, WATER FLOW SWITCHES AND VALVE TAMPER SWITCHES, REFER TO FIRE PROTECTION, PLUMBING AND MECHANICAL/HVAC DRAWINGS.
  5. MOUNTING HEIGHTS SHALL BE TO CENTER OF DEVICE OR EQUIPMENT, UNLESS OTHERWISE NOTED.
  6. PROVIDE RACEWAY, CONDUCTORS AND CABLE, ASSOCIATED FITTINGS AND CONNECTORS, AND COMPLETE CONNECTIONS REQUIRED FOR DESIGNATED FIRE ALARM BRANCH CIRCUITS FROM DEVICES TO FIRE ALARM TERMINAL CABINETS OR FIRE ALARM CONTROL PANEL OR FIRE COMMAND CENTER PER FIRE ALARM PRODUCT MANUFACTURER REQUIREMENTS.
  7. PROVIDE ADDITIONAL POWER SUPPLIES, AMPLIFICATION AND BATTERY BACKUP TO SUPPORT REHAUSD DEVICES.
  8. PROVIDE TEMPORARY HEAT DETECTORS AS REQUIRED BY LOCAL FIRE DEPARTMENT.
  9. PROVIDE NEW AV DEVICES WITH INTEGRAL SYNCHRONIZATION CAPABILITIES AND/OR PROVIDE SYNCHRONIZATION MODULES FOR SYNCHRONIZATION OF ALL VISUAL DEVICES.
  10. THE SCOPE OF THIS PROJECT SHALL IN NO WAY IMPACT THE DAILY OPERATION OR THE SEQUENCE OF OPERATION OF THE EXISTING FIRE ALARM SYSTEM.
  11. PROVIDE ALL PROGRAMMING/RE-PROGRAMMING PER REVISED SPACE DESIGNATIONS.
  12. PROVIDE ALL PRETESTS AND FINAL TESTS PER TOWN OF STONEHAM FIRE DEPARTMENT.
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  17. A FLOW AND SUPERVISORY SWITCH SHALL BE PROVIDED FOR EACH CONTROL VALVE ASSEMBLY. FOR MORE INFORMATION REFER TO THE FIRE PROTECTION DRAWINGS.

**FIRE ALARM KEYNOTES:**

1. CONTRACTOR SHALL PROVIDE CEILING MOUNTED NOTIFICATION APPLIANCES AT A RECESSED HEIGHT PARALLEL TO THE BOTTOM OF THE FLOATING CEILING. COORDINATE WITH ARCHITECT ABOUT THE FINAL MOUNTING HEIGHT.

1 FIRE ALARM THIRD FLOOR PLAN - AREA B  
FA1-1-3B 1/8" = 1'-0"

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August 4th, 2022

A B C D

KEY PLAN

PROJECT NORTH

MAGNETIC NORTH

FIRE ALARM  
THIRD FLOOR  
PLAN - AREA B

Scale: 1/8" = 1'-0"  
Job No.: 20202  
Drawn By: DRA  
Date: August 4th, 2022

FA1-1-3B

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GENERAL FIRE ALARM NOTES:

1. PROVIDE A FULLY OPERATIONAL TEMPORARY FIRE ALARM SYSTEM DURING ALL WORK, APPROVED BY LOCAL FIRE DEPARTMENT. PROVIDE FIRE ALARM SYSTEM PROGRAMMING AND TESTING ACCORDING TO LOCAL FIRE DEPARTMENT REQUESTS. TEMPORARY SYSTEM SHALL REMAIN UNTIL NEW SYSTEM HAS BEEN APPROVED FOR OPERATION.

2. COORDINATE LOCATION OF FIRE ALARM APPLIANCES AND DEVICES IN AREAS WITH CEILING SYSTEM, DUCTWORK, FIXTURES, FURNITURE, AND OTHER EQUIPMENT PRIOR TO ALL WORK.

3. FINAL LOCATIONS AND ARRANGEMENTS OF FIRE ALARM DEVICES SHALL BE OBTAINED FROM THE ARCHITECTURAL REFLECTED CEILING PLAN AND ELEVATION VIEWS.

4. FOR EXACT LOCATIONS OF SMOKE/FIRE DAMPERS, DUCT-MOUNTED SMOKE DETECTORS, WATER FLOW SWITCHES AND VALVE TAMPER SWITCHES, REFER TO FIRE PROTECTION, PLUMBING AND MECHANICAL/HVAC DRAWINGS.

5. MOUNTING HEIGHTS SHALL BE TO CENTER OF DEVICE OR EQUIPMENT, UNLESS

6. PROVIDE RACEWAY, CONDUCTORS AND CABLE, ASSOCIATED FITTINGS AND CONNECTORS, AND COMPLETE CONNECTIONS REQUIRED FOR DESIGNATED FIRE ALARM BRANCH CIRCUITS FROM DEVICE(S) TO FIRE ALARM TERMINAL CABINET(S) OR FIRE ALARM CONTROL PANEL OR FIRE COMMAND CENTER PER FIRE ALARM PRODUCT MANUFACTURER REQUIREMENTS.

7. PROVIDE ADDITIONAL POWER SUPPLIES, AMPLIFICATION AND BATTERY BACKUP TO SUPPORT NEW/ADDED DEVICES.

8. PROVIDE TEMPORARY HEAT DETECTORS AS REQUIRED BY LOCAL FIRE DEPARTMENT.

9. PROVIDE NEW A/V DEVICES WITH INTEGRAL SYNCHRONIZATION CAPABILITIES AND/OR PROVIDE SYNCHRONIZATION MODULES FOR SYNCHRONIZATION OF ALL VISUAL DEVICES.

10. THE SCOPE OF THIS PROJECT SHALL IN NO WAY IMPACT THE DAILY OPERATION OR THE SEQUENCE OF OPERATION OF THE EXISTING FIRE ALARM SYSTEM.

11. PROVIDE ALL PROGRAMMING/RE-PROGRAMMING PER REVISED SPACE DESIGNATIONS.

12. PROVIDE ALL PRETESTS AND FINAL TESTS PER TOWN OF STONEHAM FIRE DEPARTMENT.

13. PROVIDE FIRE ALARM INTERFACE TO BRING ALL DIMMED LUMINAIRES TO FULL BRIGHTNESS UPON ALARM.

14. PROVIDE FIRE ALARM INTERFACE TO SHUNT ALL A/V AND/OR SOUND EQUIPMENT.

15. PROVIDE FIRE ALARM INTERFACE TO RELEASE ALL SECURITY DEVICES.

16. A TAMPER SWITCH SHALL BE PROVIDED AT EACH ISOLATION CONTROL VALVE SERVING THE COMBINATION STANDPIPE/SPRINKLER SYSTEM. FOR MORE INFORMATION REFER TO THE FIRE PROTECTION DRAWINGS.

17. A FLOW AND SUPERVISORY SWITCH SHALL BE PROVIDED FOR EACH CONTROL VALVE ASSEMBLY. FOR MORE INFORMATION REFER TO THE FIRE PROTECTION DRAWINGS.

**FIRE ALARM KEYNOTES:**

► PROVIDE SMOKE DETECTION TO INITIATE ELEVATOR RECALL

**FIRE ALARM THIRD FLOOR PLAN - AREA C**


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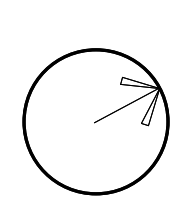
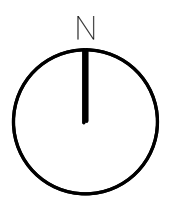
August 4th, 2022



### KEY PLAN

PROJECT NORTH

MAGNETIC NORTH

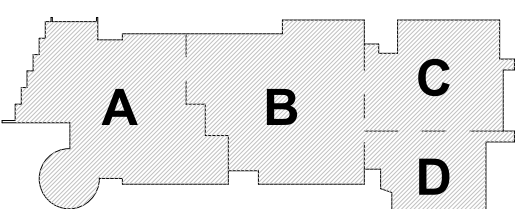

**FIRE ALARM  
THIRD FLOOR  
PLAN - AREA C**

Scale: 1/8" = 1'-0"


Job No. : 20202

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Printed by: DRA  
Date: 1 August 1999

**FA1-1-3C**



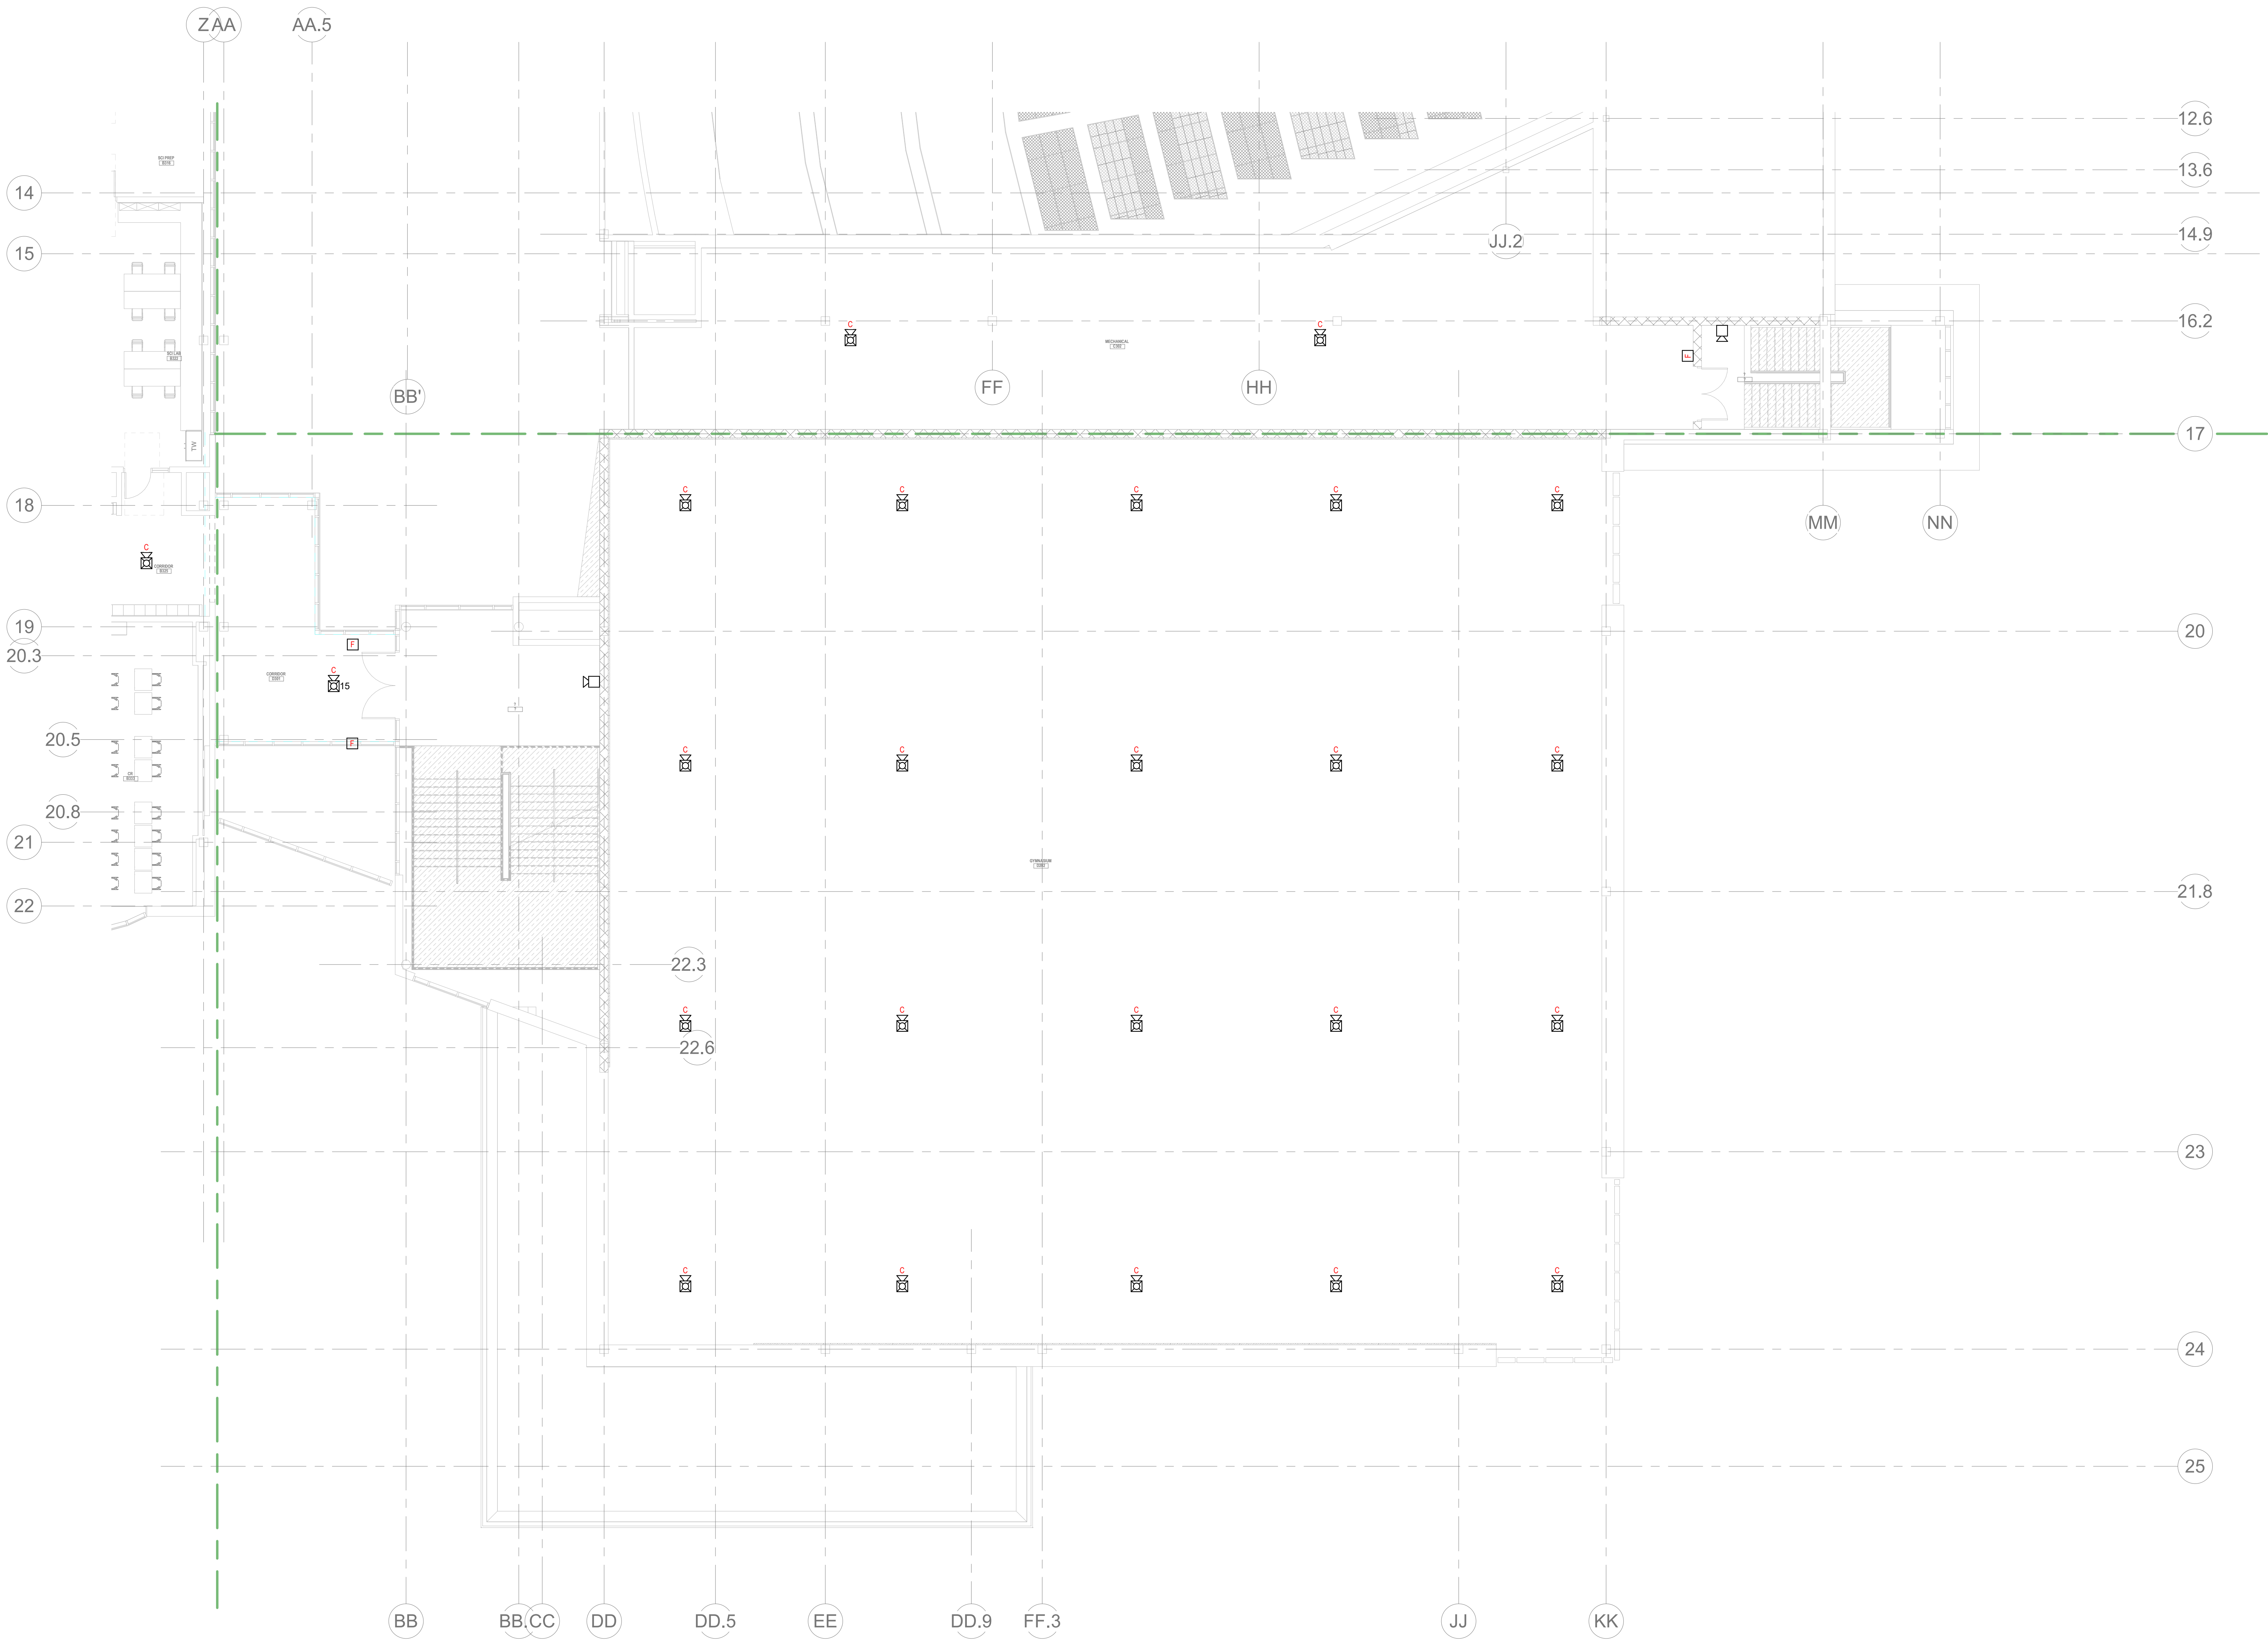

GENERAL FIRE ALARM NOTES:

1. PROVIDE A FULLY OPERATIONAL, TEMPORARY FIRE ALARM SYSTEM DURING ALL WORK, APPROVED BY LOCAL FIRE DEPARTMENT. PROVIDE FIRE ALARM SYSTEM PROGRAMMING AND TESTING ACCORDING TO LOCAL FIRE DEPARTMENT REQUESTS. TEMPORARY SYSTEM SHALL REMAIN UNTIL NEW SYSTEM HAS BEEN APPROVED FOR OPERATION.
2. COORDINATE LOCATION OF FIRE ALARM APPLIANCES AND DEVICES IN AREAS WITH CEILING SYSTEM, DUCTWORK, FIXTURES, FURNITURE, AND OTHER EQUIPMENT PRIOR TO ALL WORK.
3. FINAL LOCATIONS AND ARRANGEMENTS OF FIRE ALARM DEVICES SHALL BE OBTAINED FROM THE ARCHITECTURAL REFLECTED CEILING PLAN AND ELEVATION VIEWS.
4. FOR EXACT LOCATIONS OF SMOKE/FIRE DAMPERS, DUCT MOUNTED SMOKE DETECTORS, WATER FLOW SWITCHES AND VALVE TAMPER SWITCHES, REFER TO FIRE PROTECTION, PLUMBING AND MECHANICAL/HVAC DRAWINGS.
5. MOUNTING HEIGHTS SHALL BE TO CENTER OF DEVICE OR EQUIPMENT, UNLESS OTHERWISE NOTED.
6. PROVIDE RACEWAY, CONDUCTORS AND CABLE, ASSOCIATED FITTINGS AND CONNECTORS, AND COMPLETE CONNECTIONS REQUIRED FOR DESIGNATED FIRE ALARM BRANCH CIRCUITS FROM DEVICES TO FIRE ALARM TERMINAL CABINETS OR FIRE ALARM CONTROL PANEL OR FIRE COMMAND CENTER PER FIRE ALARM PRODUCT MANUFACTURER REQUIREMENTS.
7. PROVIDE ADDITIONAL POWER SUPPLIES, AMPLIFICATION AND BATTERY BACKUP TO SUPPORT NEW/ADDED DEVICES.
8. PROVIDE TEMPORARY HEAT DETECTORS AS REQUIRED BY LOCAL FIRE DEPARTMENT.
9. PROVIDE NEW AV DEVICES WITH INTEGRAL SYNCHRONIZATION CAPABILITIES AND/OR PROVIDE SYNCHRONIZATION MODULES FOR SYNCHRONIZATION OF ALL VISUAL DEVICES.
10. THE SCOPE OF THIS PROJECT SHALL IN NO WAY IMPACT THE DAILY OPERATION OR THE SEQUENCE OF OPERATION OF THE EXISTING FIRE ALARM SYSTEM.
11. PROVIDE ALL PROGRAMMING/RE-PROGRAMMING PER REVISED SPACE DESIGNATIONS.
12. PROVIDE ALL PRETESTS AND FINAL TESTS PER TOWN OF STONEHAM FIRE DEPARTMENT.
13. PROVIDE FIRE ALARM INTERFACE TO BRING ALL DIMMED LUMINAIRES TO FULL BRIGHTNESS UPON ALARM.
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15. PROVIDE FIRE ALARM INTERFACE TO RELEASE ALL SECURITY DEVICES.
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17. A FLOW AND SUPERVISORY SWITCH SHALL BE PROVIDED FOR EACH CONTROL VALVE ASSEMBLY. FOR MORE INFORMATION REFER TO THE FIRE PROTECTION DRAWINGS.

1 FIRE ALARM THIRD FLOOR PLAN - AREA D  
1/8" = 1'-0"

DRA


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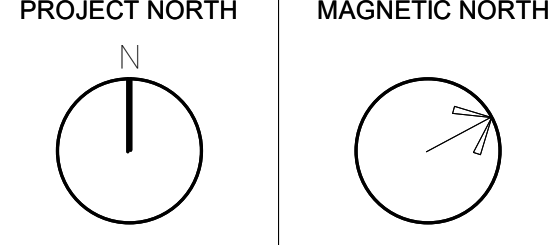
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SUBMISSION  
August 4th, 2022




KEY PLAN



FIRE ALARM  
THIRD FLOOR  
PLAN - AREA D

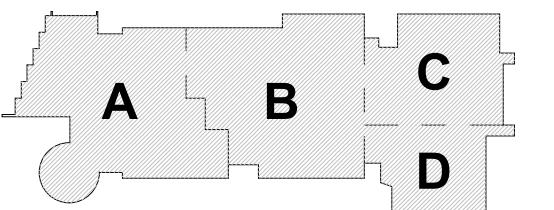Scale: 1/8" = 1'-0"  
Job No.: 20202  
Drawn By: DRA  
Date: August 4th, 2022  
FA1-1-3D



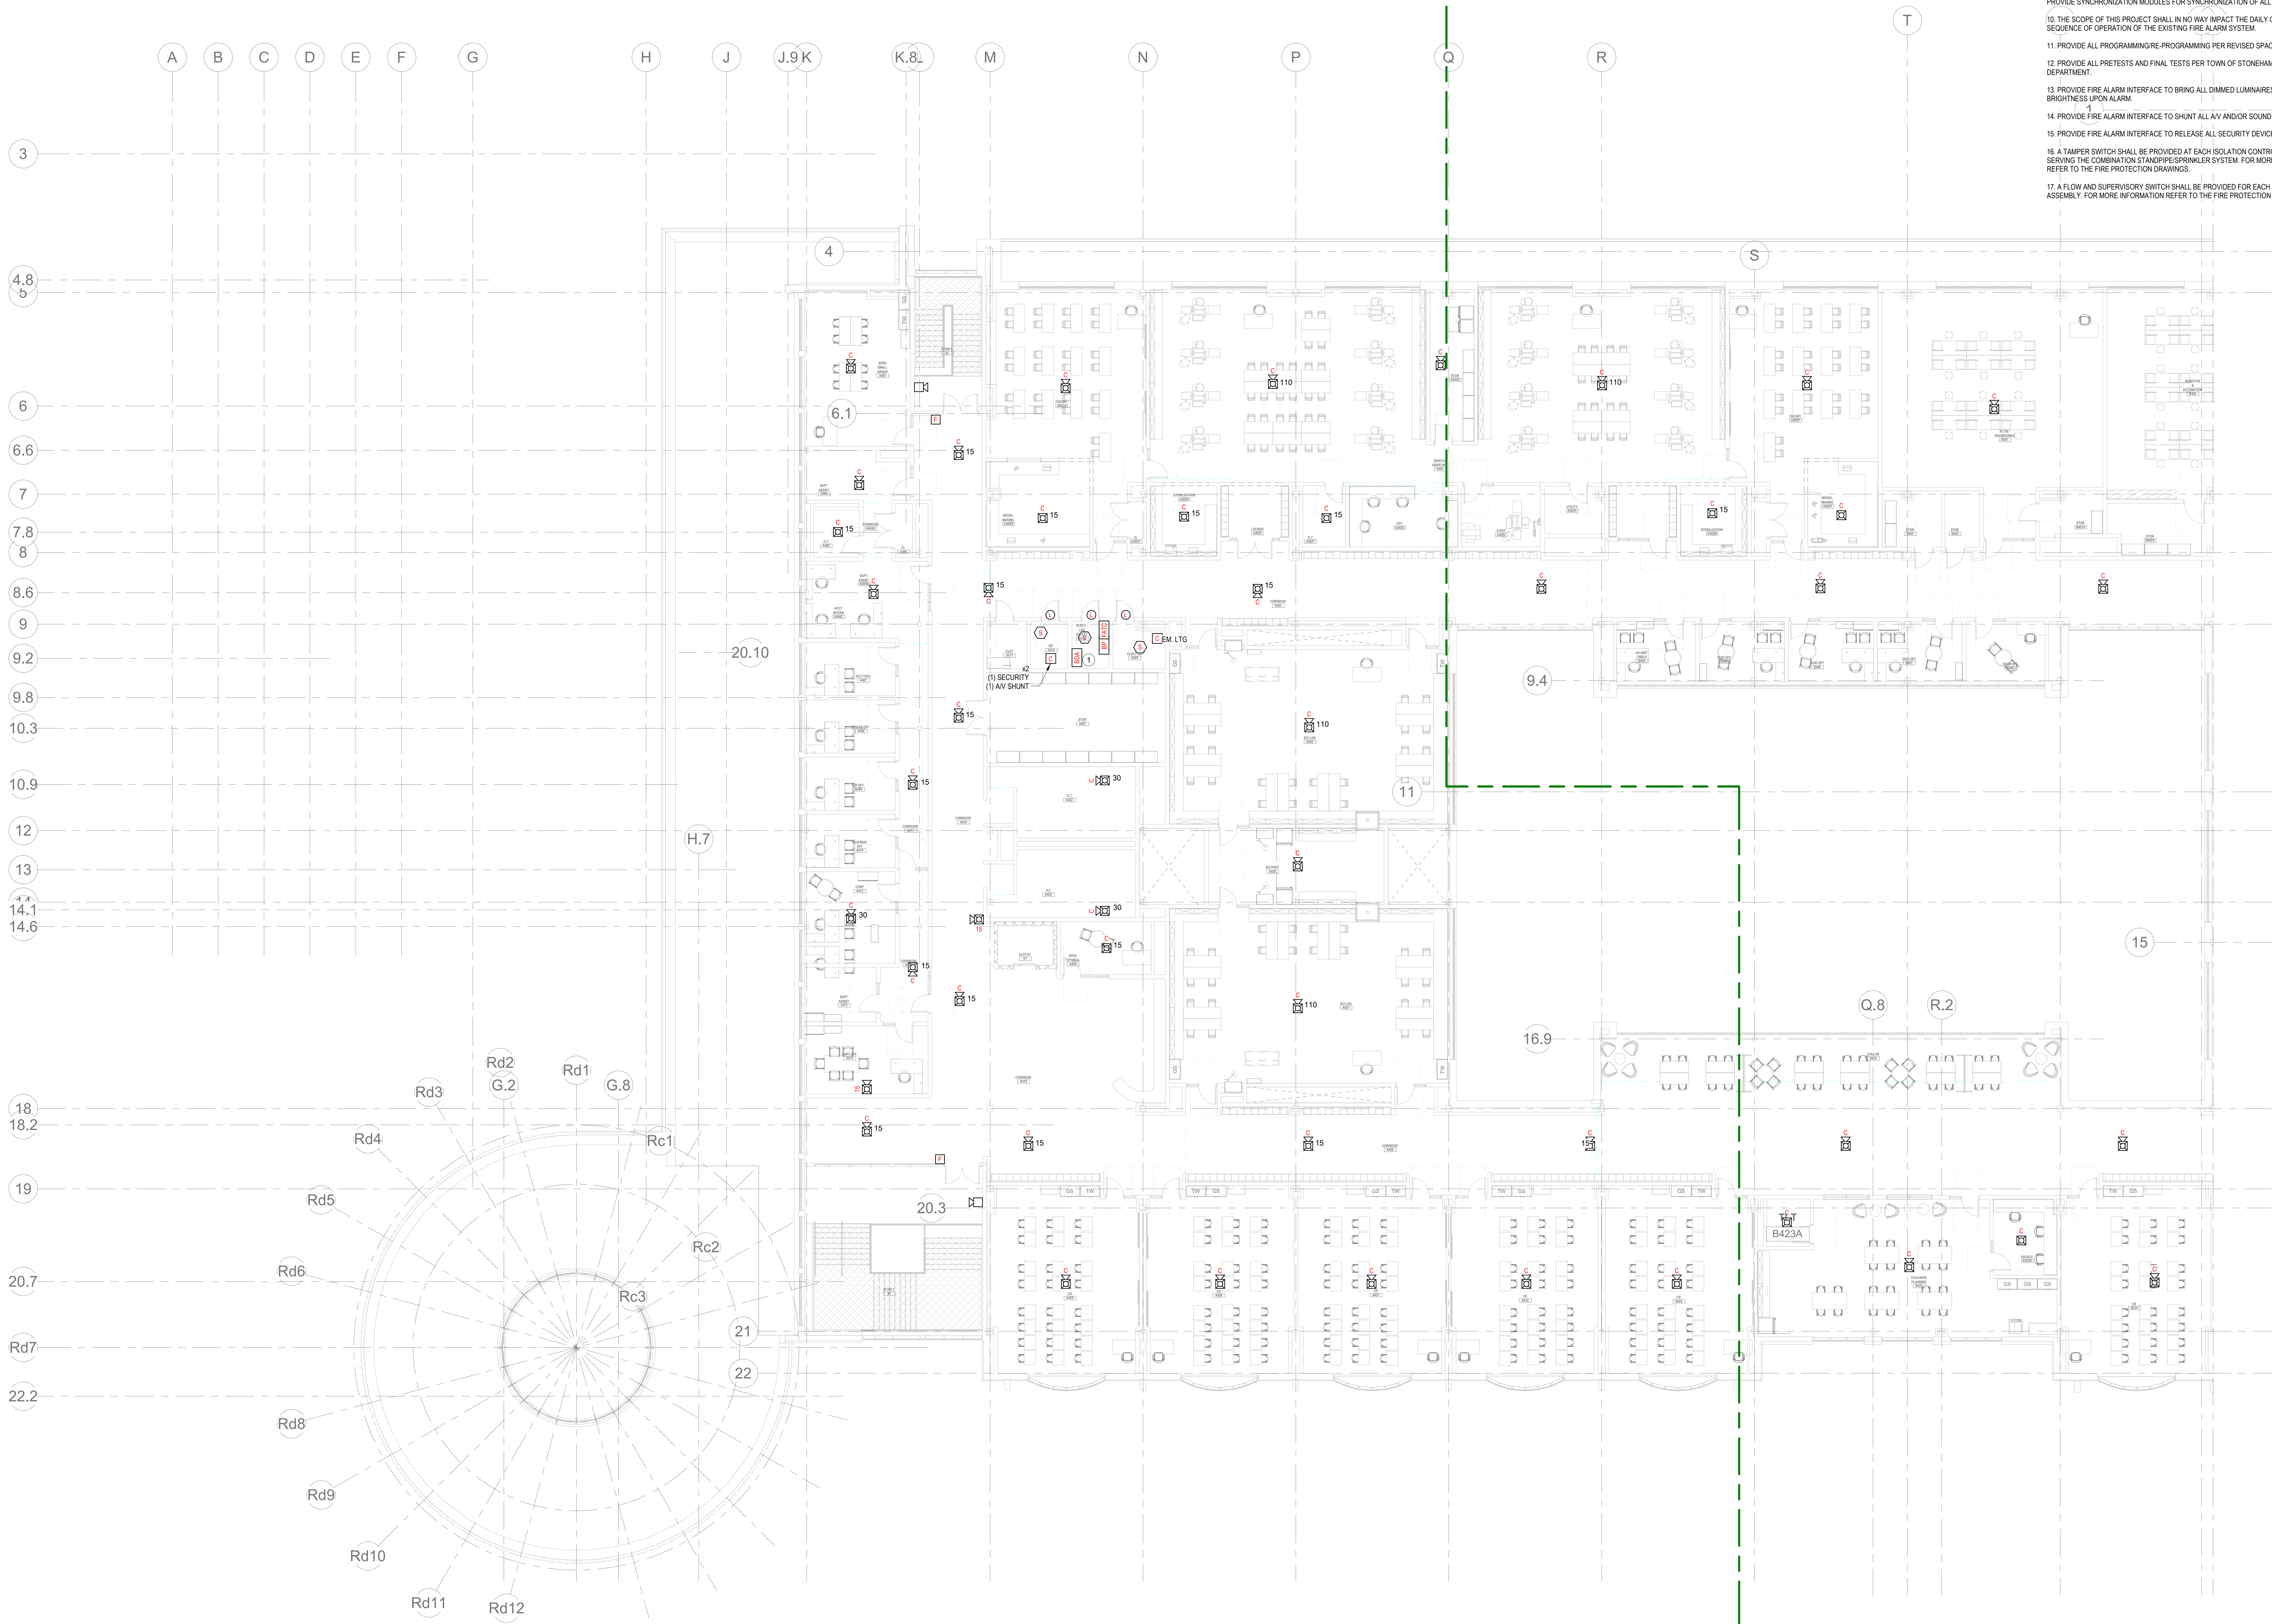

1 FIRE ALARM FOURTH FLOOR PLAN - AREA A  
1" = 10'-0"

FIRE ALARM KEYNOTES:  
1. PROVIDE A BI-DIRECTIONAL AMPLIFIER PANEL FOR POLICE AND FIRE DEPARTMENT RADIO COMMUNICATION.

GENERAL FIRE ALARM NOTES:  
1. PROVIDE A FULLY OPERATIONAL TEMPORARY FIRE ALARM SYSTEM DURING ALL WORK APPROVED BY LOCAL FIRE DEPARTMENT. PROVIDE FIRE ALARM SYSTEM PROGRAMMING AND TESTING ACCORDING TO LOCAL FIRE DEPARTMENT REQUESTS. TEMPORARY SYSTEM SHALL REMAIN UNTIL NEW SYSTEM HAS BEEN APPROVED FOR OPERATION.  
2. COORDINATE LOCATION OF FIRE ALARM APPLIANCES AND DEVICES IN AREAS WITH CEILING SYSTEM, DUCTWORK, FIXTURES, FURNITURE, AND OTHER EQUIPMENT PRIOR TO ALL WORK.  
3. FINAL LOCATIONS AND ARRANGEMENTS OF FIRE ALARM DEVICES SHALL BE OBTAINED FROM THE ARCHITECTURAL REFLECTED CEILING PLAN AND ELEVATION VIEWS.  
4. FOR EXACT LOCATIONS OF SMOKE/FIRE DAMPERS, DUCT-MOUNTED SMOKE DETECTORS, WATER FLOW SWITCHES AND VALVE TAMPER SWITCHES, REFER TO FIRE PROTECTION, PLUMBING AND MECHANICAL/HVAC DRAWINGS.  
5. MOUNTING HEIGHTS SHALL BE TO CENTER OF DEVICE OR EQUIPMENT, UNLESS OTHERWISE NOTED.  
6. PROVIDE RACEWAY, CONDUCTORS AND CABLE, ASSOCIATED FITTINGS AND CONNECTORS, AND COMPLETE CONNECTIONS REQUIRED FOR DESIGNATED FIRE ALARM BRANCH CIRCUITS FROM DEVICES TO FIRE ALARM TERMINAL CABINET(S) OR FIRE ALARM CONTROL PANEL OR FIRE COMMAND CENTER PER FIRE ALARM PRODUCT MANUFACTURER REQUIREMENTS.  
7. PROVIDE ADDITIONAL POWER SUPPLIES, AMPLIFICATION AND BATTERY BACKUP TO SUPPORT NEW/EXISTING DEVICES.  
8. PROVIDE TEMPORARY HEAT DETECTORS AS REQUIRED BY LOCAL FIRE DEPARTMENT.  
9. PROVIDE NEW A/V DEVICES WITH INTEGRAL SYNCHRONIZATION CAPABILITIES AND/OR PROVIDE SYNCHRONIZATION MODULES FOR SYNCHRONIZATION OF ALL VISUAL DEVICES.  
10. THE SCOPE OF THIS PROJECT SHALL IN NO WAY IMPACT THE DAILY OPERATION OR THE SEQUENCE OF OPERATION OF THE EXISTING FIRE ALARM SYSTEM.  
11. PROVIDE ALL PROGRAMMING/RE-PROGRAMMING PER REVISED SPACE DESIGNATIONS.  
12. PROVIDE ALL PRETESTS AND FINAL TESTS PER TOWN OF STONEHAM FIRE DEPARTMENT.  
13. PROVIDE FIRE ALARM INTERFACE TO BRING ALL DIMMED LUMINAIRES TO FULL BRIGHTNESS UPON ALARM.  
14. PROVIDE FIRE ALARM INTERFACE TO SHUNT ALL A/V AND/OR SOUND EQUIPMENT.  
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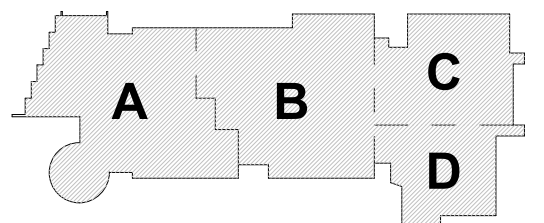
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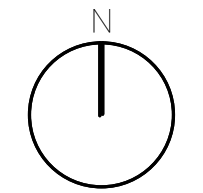
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August 4th, 2022




KEY PLAN

PROJECT NORTH



MAGNETIC NORTH

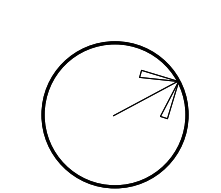


FIRE ALARM  
FOURTH FLOOR  
PLAN - AREA A

Scale: 1" = 10'-0"  
Job No.: 20202  
Drawn By: DRA  
Date: August 4th, 2022

FA1-1-4A



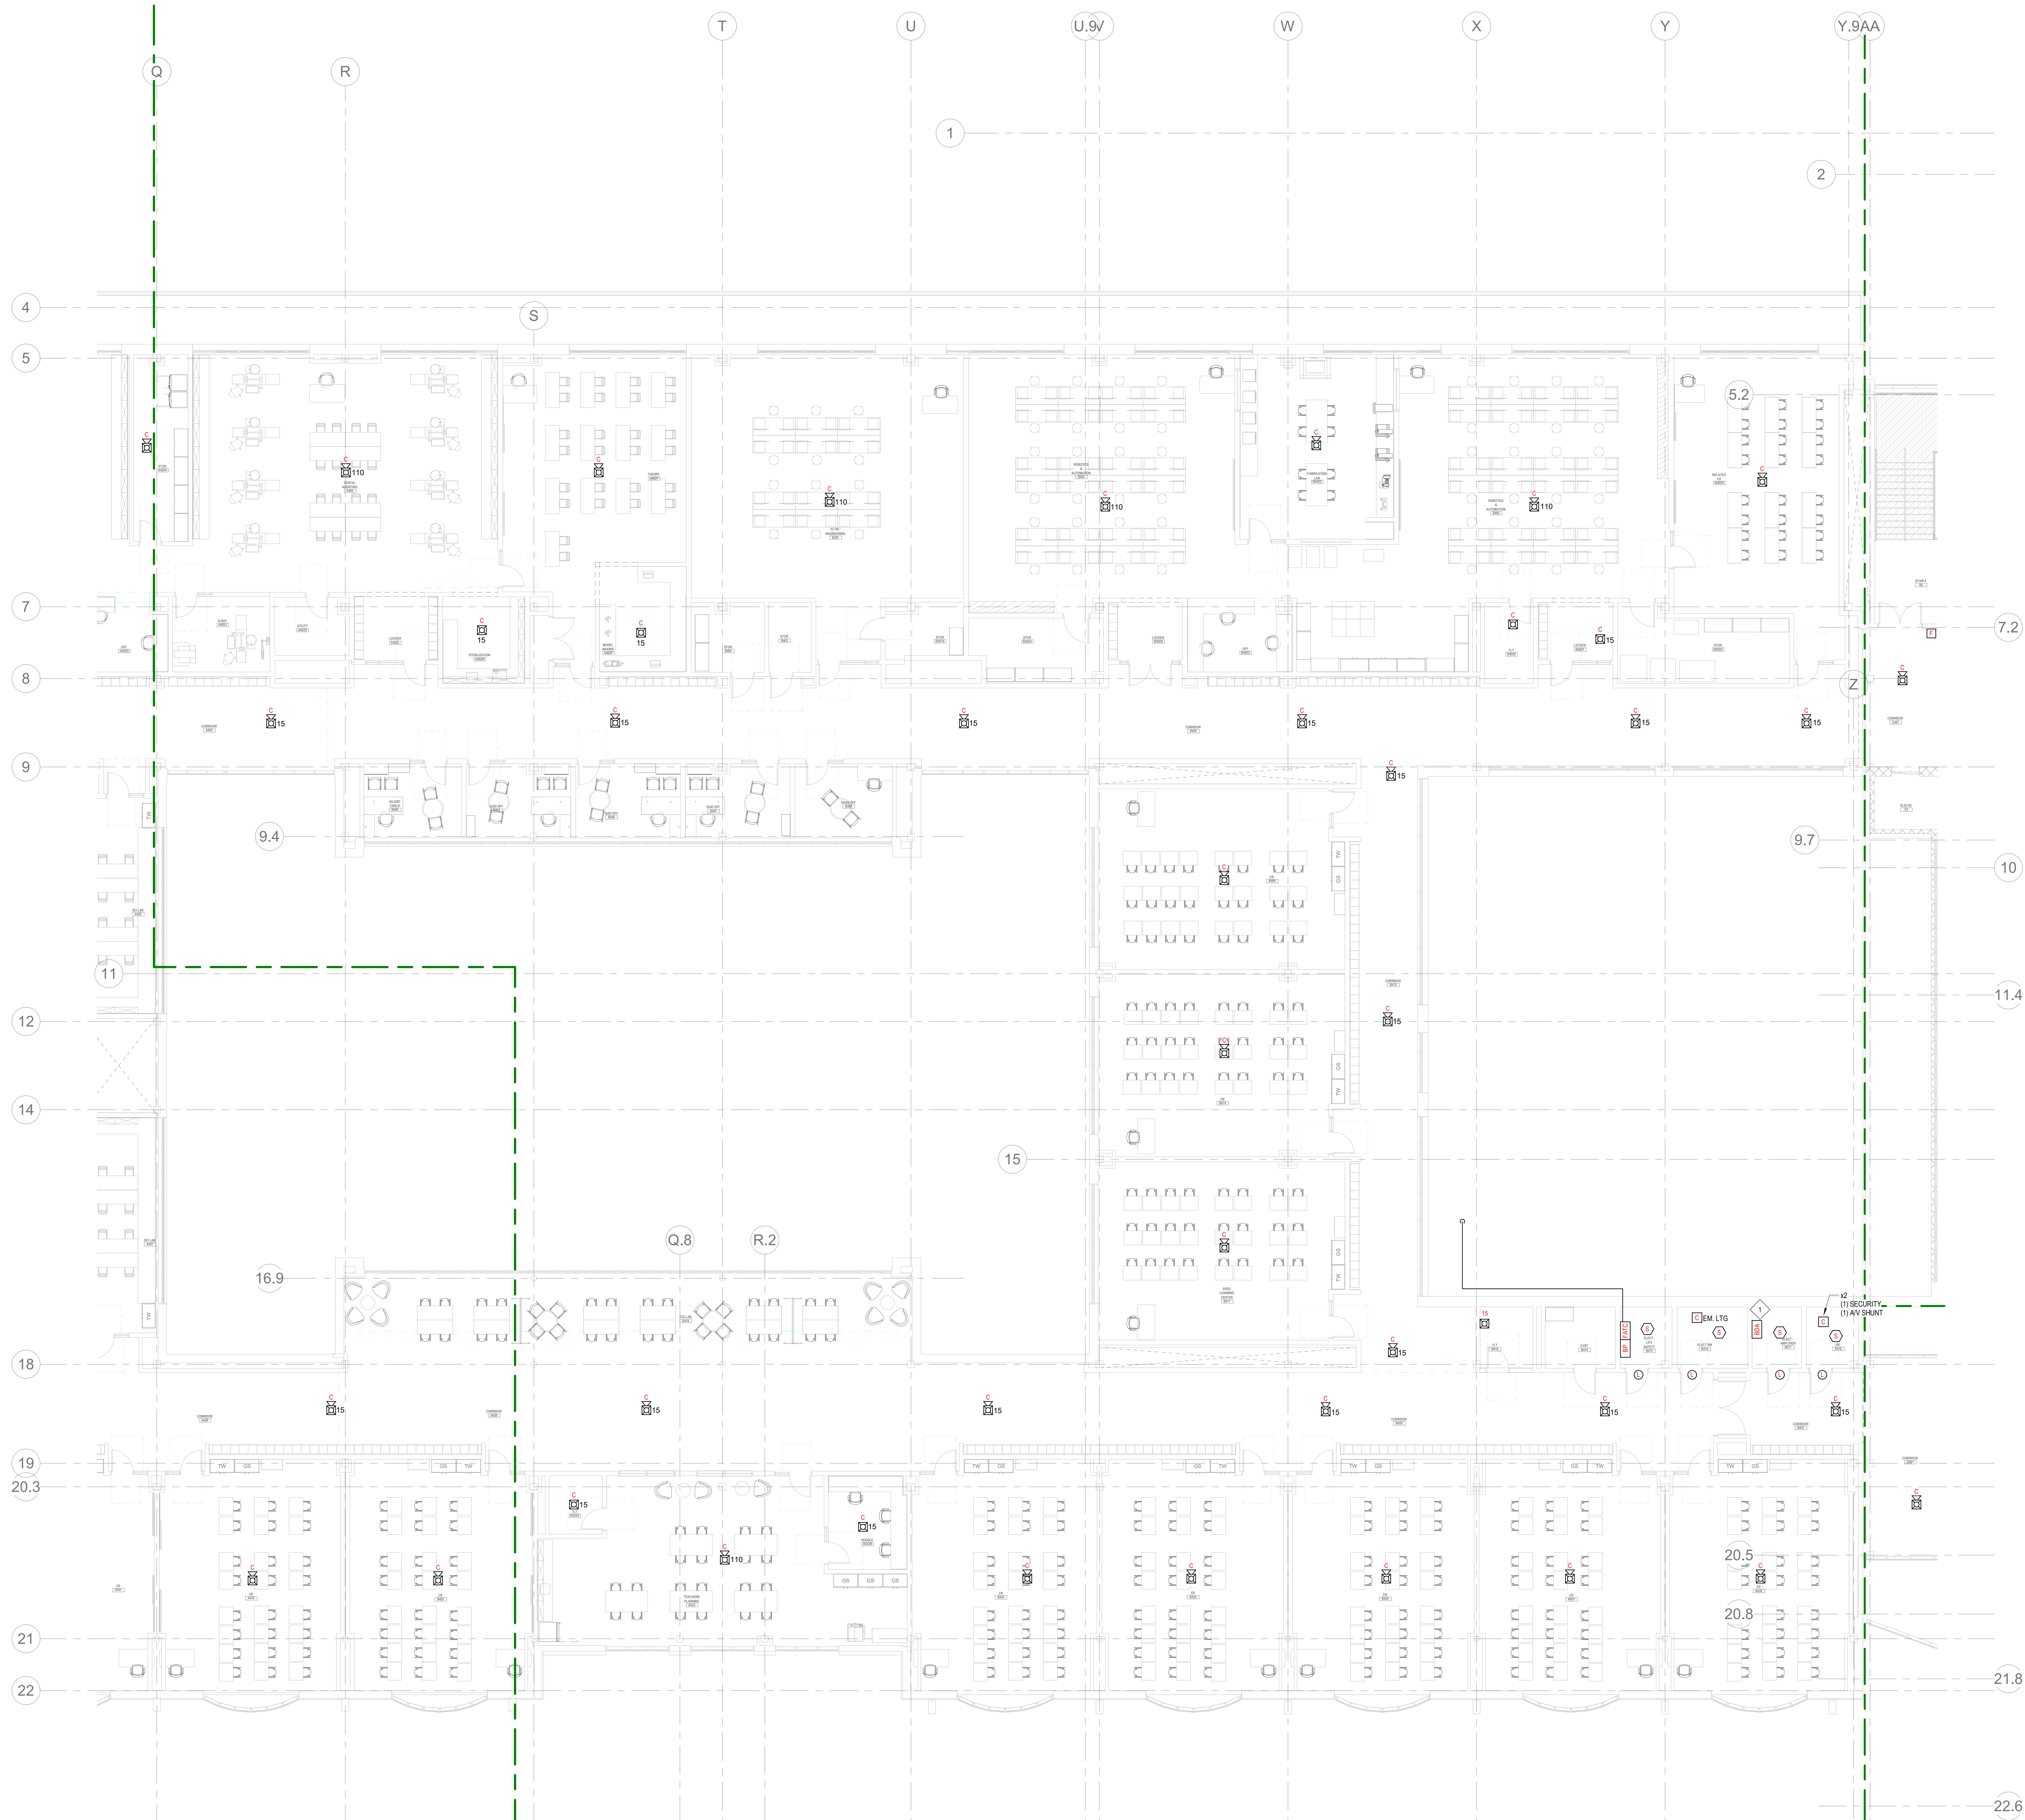

**GENERAL FIRE ALARM NOTES:**

1. PROVIDE A FULLY OPERATIONAL TEMPORARY FIRE ALARM SYSTEM DURING ALL WORK, APPROVED BY LOCAL FIRE DEPARTMENT. PROVIDE FIRE ALARM SYSTEM PROGRAMMING AND TESTING ACCORDING TO LOCAL FIRE DEPARTMENT REQUESTS. TEMPORARY SYSTEM SHALL REMAIN UNTIL NEW SYSTEM HAS BEEN APPROVED FOR OPERATION.
2. COORDINATE LOCATION OF FIRE ALARM APPLIANCES AND DEVICES IN AREAS WITH CEILING SYSTEM, DUCTWORK, FIXTURES, FURNITURE, AND OTHER EQUIPMENT PRIOR TO ALL WORK.
3. FINAL LOCATIONS AND ARRANGEMENTS OF FIRE ALARM DEVICES SHALL BE OBTAINED FROM THE ARCHITECTURAL REFLECTED CEILING PLAN AND ELEVATION VIEWS.
4. FOR EXACT LOCATIONS OF SMOKE/FIRE DAMPERS, DUCT MOUNTED SMOKE DETECTORS, WATER FLOW SWITCHES AND VALVE TAMPER SWITCHES, REFER TO FIRE PROTECTION, PLUMBING AND MECHANICAL/VAC DRAWINGS.
5. MOUNTING HEIGHTS SHALL BE TO CENTER OF DEVICE OR EQUIPMENT, UNLESS OTHERWISE NOTED.
6. PROVIDE RACEWAY, CONDUCTORS AND CABLE, ASSOCIATED FITTINGS AND CONNECTORS, AND COMPLETE CONNECTIONS REQUIRED FOR DESIGNATED FIRE ALARM BRANCH CIRCUITS FROM DEVICES TO FIRE ALARM TERMINAL CABINETS OR FIRE ALARM CONTROL PANEL OR FIRE COMMAND CENTER PER FIRE ALARM PRODUCT MANUFACTURER REQUIREMENTS.
7. PROVIDE ADDITIONAL POWER SUPPLIES, AMPLIFICATION AND BATTERY BACKUP TO SUPPORT NEWWORK DEVICES.
8. PROVIDE TEMPORARY HEAT DETECTORS AS REQUIRED BY LOCAL FIRE DEPARTMENT.
9. PROVIDE NEW ANY DEVICES WITH INTEGRAL SYNCHRONIZATION CAPABILITIES AND/OR PROVIDE SYNCHRONIZATION MODULES FOR SYNCHRONIZATION OF ALL VISUAL DEVICES.
10. THE SCOPE OF THIS PROJECT SHALL IN NO WAY IMPACT THE DAILY OPERATION OR THE SEQUENCE OF OPERATION OF THE EXISTING FIRE ALARM SYSTEM.
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13. PROVIDE FIRE ALARM INTERFACE TO BRING ALL DIMMED LUMINAIRES TO FULL BRIGHTNESS UPON ALARM.
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17. A FLOW AND SUPERVISORY SWITCH SHALL BE PROVIDED FOR EACH CONTROL VALVE ASSEMBLY. FOR MORE INFORMATION REFER TO THE FIRE PROTECTION DRAWINGS.

**FIRE ALARM KEYNOTES:**

1. PROVIDE A BIDIRECTIONAL AMPLIFIER PANEL FOR POLICE AND FIRE DEPARTMENT RADIO COMMUNICATION

**FIRE ALARM FOURTH FLOOR PLAN - AREA B**

DRA

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August 4th, 2022

A B C D

KEY PLAN

PROJECT NORTH

MAGNETIC NORTH

FIRE ALARM  
FOURTH FLOOR  
PLAN - AREA B

Scale: 1/8" = 1'-0"  
Job No.: 20202  
Drawn By: DRA  
Date: August 4th, 2022

FA1-1-4B



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School**

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GENERAL FIRE ALARM NOTES:

1. PROVIDE A FULLY OPERATIONAL TEMPORARY FIRE ALARM SYSTEM DURING ALL WORK, APPROVED BY LOCAL FIRE DEPARTMENT. PROVIDE FIRE ALARM SYSTEM PROGRAMMING AND TESTING ACCORDING TO LOCAL FIRE DEPARTMENT REQUESTS. TEMPORARY SYSTEM SHALL REMAIN UNTIL NEW SYSTEM HAS BEEN APPROVED FOR OPERATION.

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6. PROVIDE RACEWAY, CONDUCTORS AND CABLE, ASSOCIATED FITTINGS AND CONNECTORS, AND COMPLETE CONNECTIONS REQUIRED FOR DESIGNATED FIRE ALARM BRANCH CIRCUITS FROM DEVICE(S) TO FIRE ALARM TERMINAL CABINET(S) OR FIRE ALARM CONTROL PANEL OR FIRE COMMAND CENTER PER FIRE ALARM PRODUCT MANUFACTURER REQUIREMENTS.

7. PROVIDE ADDITIONAL POWER  
SUPPORT NEW/ADDED DEVICES

8. PROVIDE TEMPORARY HEAT DETECTORS AS REQUIRED BY LOCAL FIRE DEPARTMENT

9. PROVIDE NEW A/V DEVICES WITH INTEGRAL SYNCHRONIZATION CAPABILITIES AND/OR PROVIDE SYNCHRONIZATION MODULES FOR SYNCHRONIZATION OF ALL VISUAL DEVICES

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FIRE ALARM KEYNOTES:

 PROVIDE SMOKE DETECTION TO INITIATE ELEVATOR RECALL.

**FIRE ALARM FOURTH FLOOR PLAN - AREA C**

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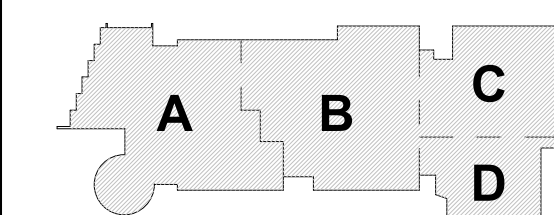
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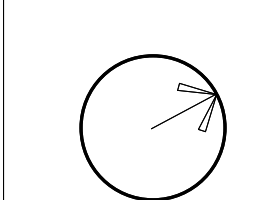
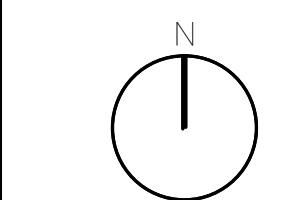
August 4th, 2022



KEY PLAN

PROJECT NORTH

MAGNETIC NORTH



**FIRE ALARM  
FOURTH FLOOR  
PLAN - AREA C**

Scale: 1/8" = 1'-0"


Job No.: 70203

JUD NO.: 20202

Drawn By: DR.

FA1-1-4C



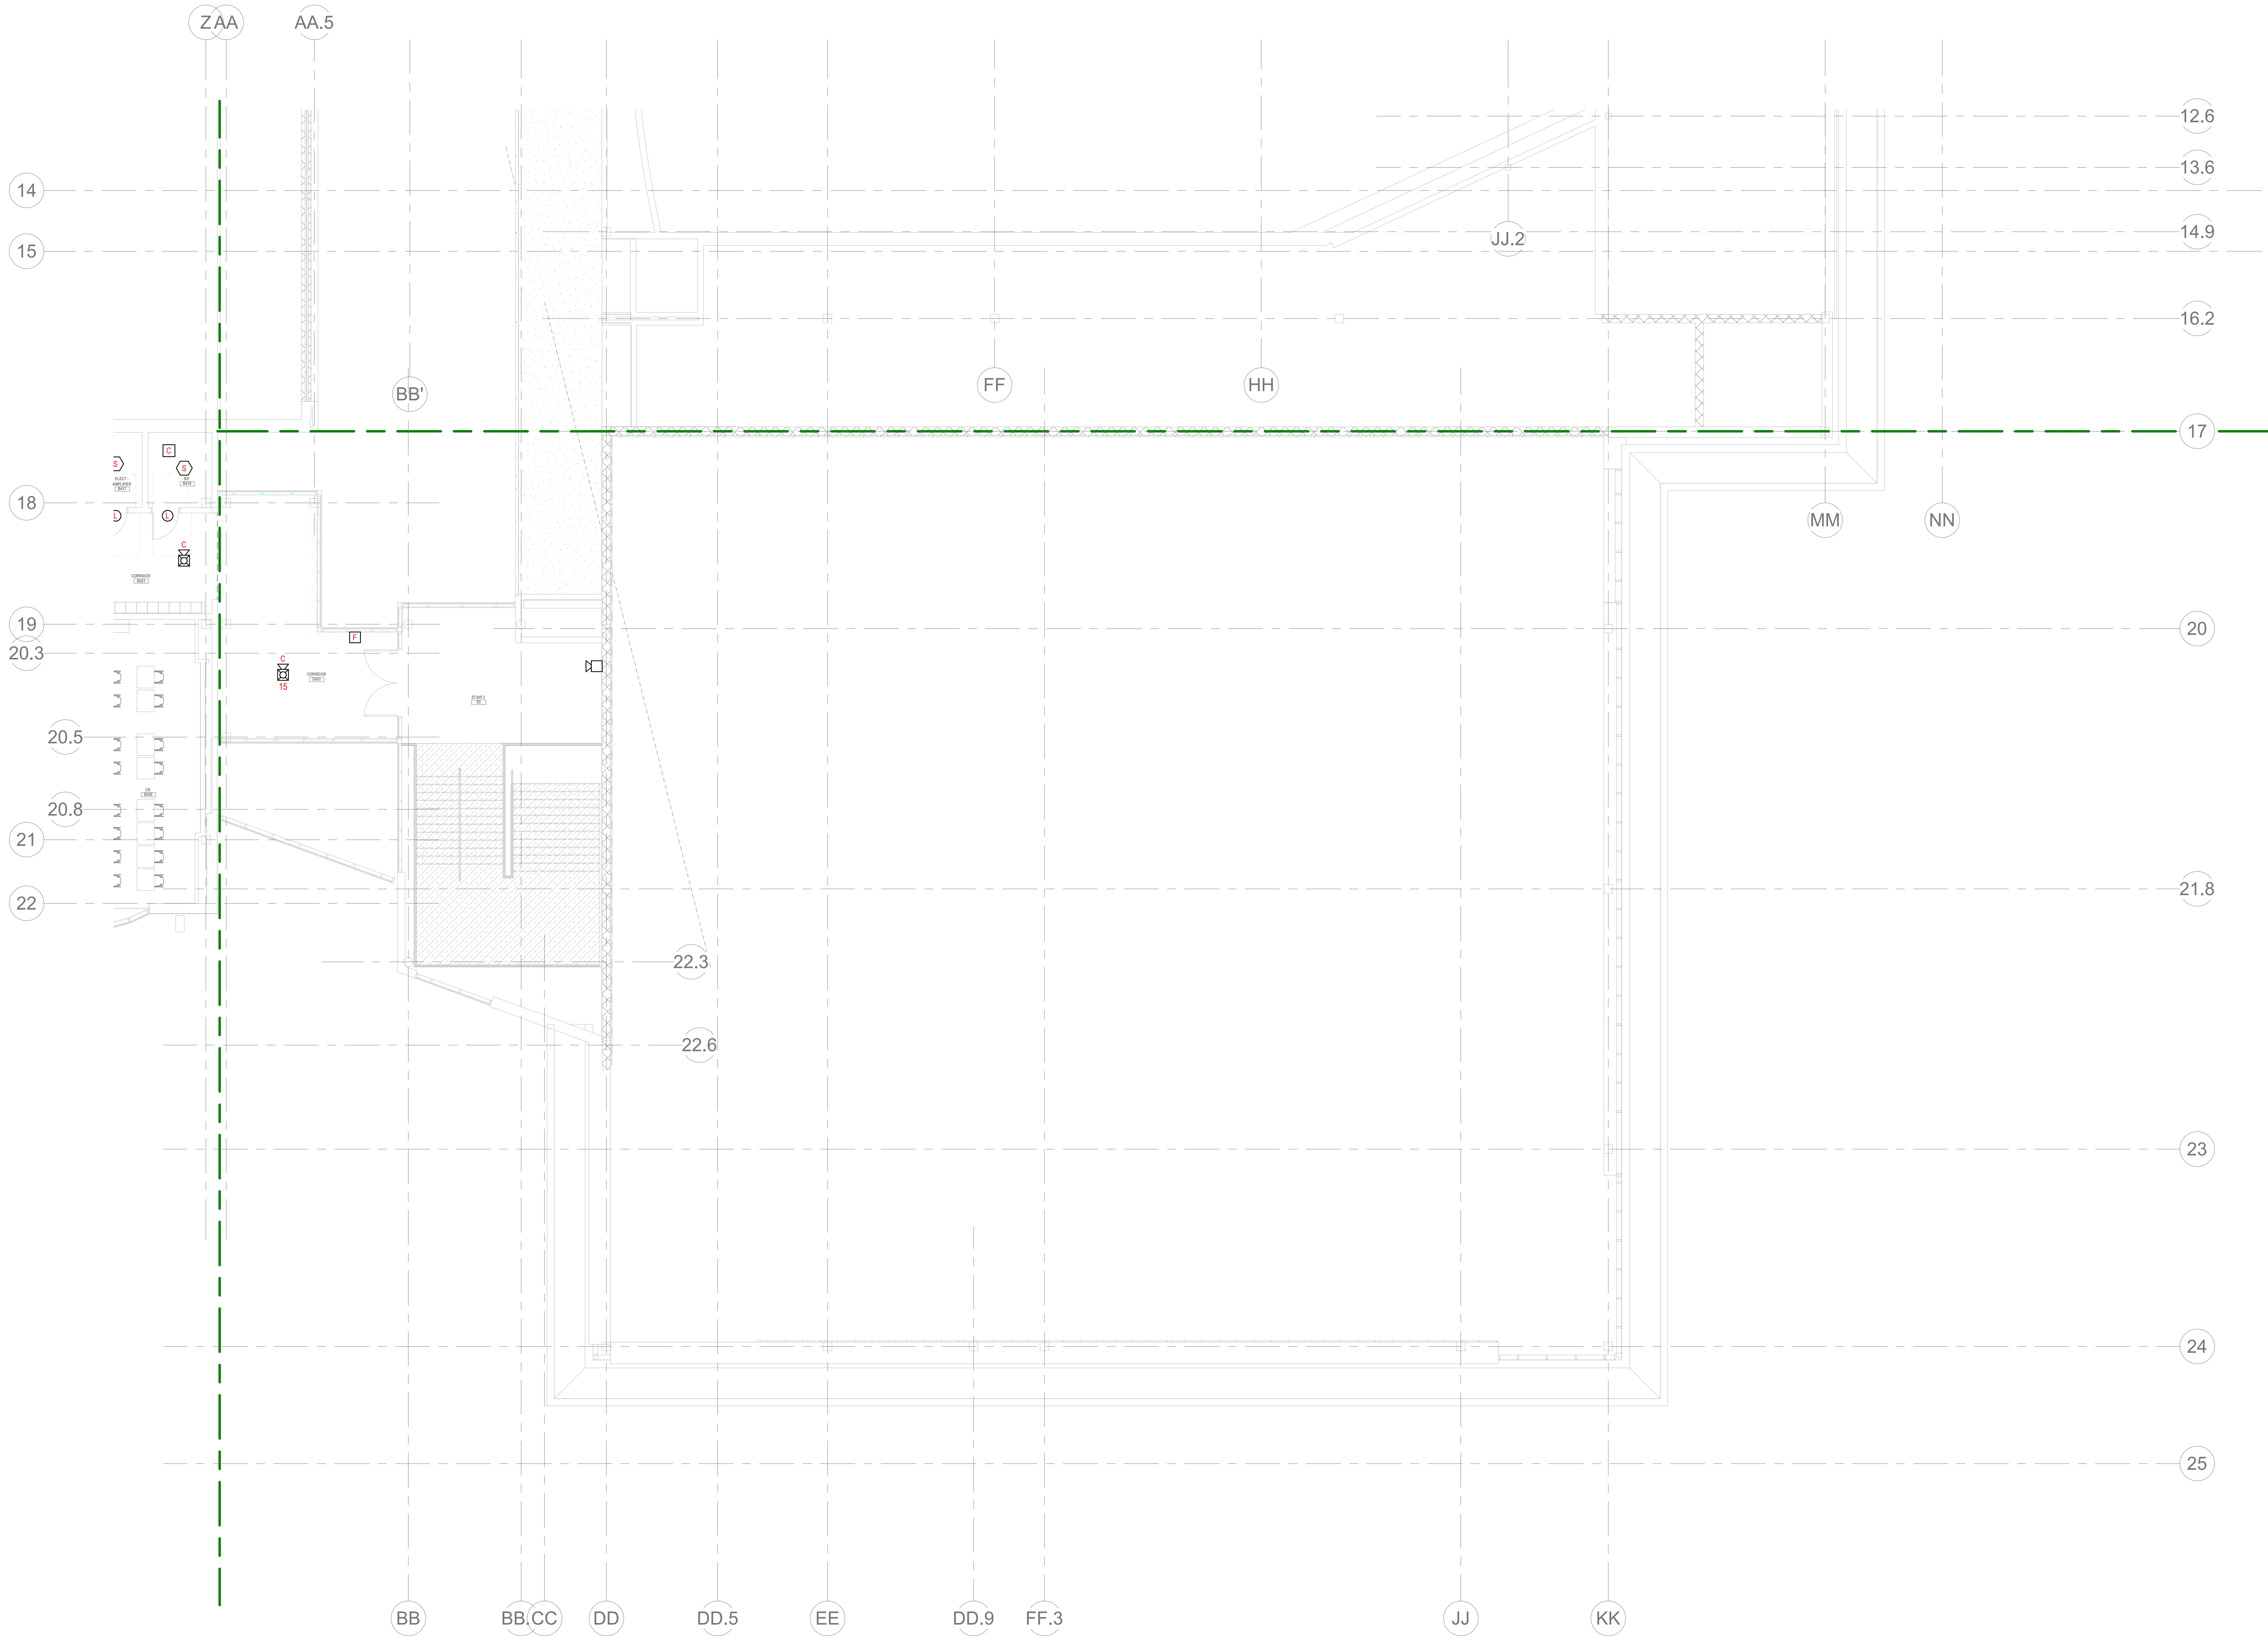

GENERAL FIRE ALARM NOTES:

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7. PROVIDE ADDITIONAL POWER SUPPLIES, AMPLIFICATION AND BATTERY BACKUP TO SUPPORT NEW/ADDED DEVICES.
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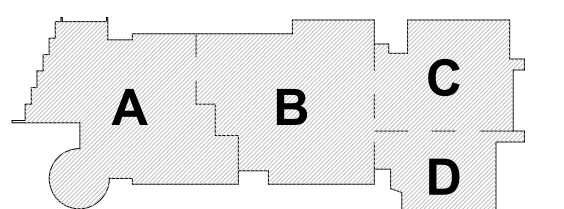
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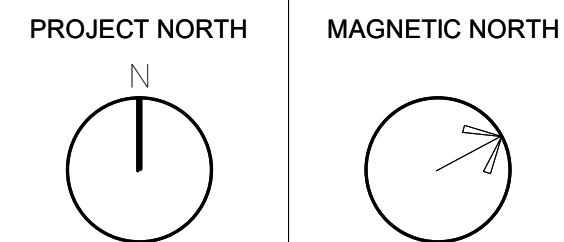
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DEVELOPMENT  
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August 4th, 2022



KEY PLAN



FIRE ALARM  
FOURTH FLOOR  
PLAN - AREA D

Scale: 1/8" = 1'-0"  
Job No.: 20202  
Drawn By: DRA  
Date: August 4th, 2022  
FA1-1-4D

1 FIRE ALARM FOURTH FLOOR PLAN - AREA D  
FA1-1-4D  
1/8" = 1'-0"




KEYNOTE


1. PROVIDE A SMOKE DETECTOR TO INITIATE ELEVATOR RECALL.
2. PROVIDE A NEW ANALOG ADDRESSABLE FIRE ALARM CONTROL PANEL UNIT. A DIGITAL ALARM COMMUNICATION TRANSMITTER SHALL BE PROVIDED TO TRANSMIT SIGNALS OFF-SITE.
3. PROVIDE HEAT DETECTORS RATED AT A FIXED TEMPERATURE OF 155 F.

GENERAL FIRE ALARM NOTES:

1. PROVIDE A FULLY OPERATIONAL TEMPORARY FIRE ALARM SYSTEM DURING ALL WORK APPROVED BY LOCAL FIRE DEPARTMENT. PROVIDE FIRE ALARM SYSTEM PROGRAMMING AND TESTING ACCORDING TO LOCAL FIRE DEPARTMENT REQUESTS. TEMPORARY SYSTEM SHALL REMAIN UNTIL NEW SYSTEM HAS BEEN APPROVED FOR OPERATION.
2. COORDINATE LOCATION OF FIRE ALARM APPLIANCES AND DEVICES IN AREAS WITH CEILING SYSTEM, DUCTWORK, FIXTURES, FURNITURE, AND OTHER EQUIPMENT PRIOR TO ALL WORK.
3. FINAL LOCATIONS AND ARRANGEMENTS OF FIRE ALARM DEVICES SHALL BE OBTAINED FROM THE ARCHITECTURAL REFLECTED CEILING PLAN AND ELEVATION VIEWS.
4. FOR EXACT LOCATIONS OF SMOKE/FIRE DAMPERS, DUCT MOUNTED SMOKE DETECTORS, WATER FLOW SWITCHES AND VALVE TAMPER SWITCHES, REFER TO FIRE PROTECTION, PLUMBING AND MECHANICAL/HVAC DRAWINGS.
5. MOUNTING HEIGHTS SHALL BE TO CENTER OF DEVICE OR EQUIPMENT, UNLESS OTHERWISE NOTED.
6. PROVIDE RACEWAY, CONDUCTORS AND CABLE, ASSOCIATED FITTINGS AND CONNECTORS, AND COMPLETE CONNECTIONS REQUIRED FOR DESIGNATED FIRE ALARM BRANCH CIRCUITS FROM DEVICES TO FIRE ALARM TERMINAL CABINETS OR FIRE ALARM CONTROL PANEL OR FIRE COMMAND CENTER PER FIRE ALARM PRODUCT MANUFACTURER REQUIREMENTS.
7. PROVIDE ADDITIONAL POWER SUPPLIES, AMPLIFICATION AND BATTERY BACKUP TO SUPPORT NOTWAGED DEVICES.
8. PROVIDE TEMPORARY HEAT DETECTORS AS REQUIRED BY LOCAL FIRE DEPARTMENT.
9. PROVIDE NEW AV DEVICES WITH INTEGRAL SYNCHRONIZATION CAPABILITIES AND/OR PROVIDE SYNCHRONIZATION MODULES FOR SYNCHRONIZATION OF ALL VISUAL DEVICES.
10. THE SCOPE OF THIS PROJECT SHALL IN NO WAY IMPACT THE DAILY OPERATION OR THE SEQUENCE OF OPERATION OF THE EXISTING FIRE ALARM SYSTEM.
11. PROVIDE ALL PROGRAMMING/FIRE PROGRAMMING PER REVISED SPACE DESIGNATIONS.
12. PROVIDE ALL PRETESTS AND FINAL TESTS PER TOWN OF STONEHAM FIRE DEPARTMENT.
13. PROVIDE FIRE ALARM INTERFACE TO BRING ALL DIMMED LUMINAIRES TO FULL BRIGHTNESS UPON ALARM.
14. PROVIDE FIRE ALARM INTERFACE TO SHUNT ALL AV AND/OR SOUND EQUIPMENT.
15. PROVIDE FIRE ALARM INTERFACE TO RELEASE ALL SECURITY DEVICES.
16. A TAMPER SWITCH SHALL BE PROVIDED AT EACH ISOLATION CONTROL VALVE SERVING THE COMBINATION STANDPIPE/SPRINKLER SYSTEM. FOR MORE INFORMATION REFER TO THE FIRE PROTECTION DRAWINGS.
17. A FLOW AND SUPERVISORY SWITCH SHALL BE PROVIDED FOR EACH CONTROL VALVE ASSEMBLY. FOR MORE INFORMATION REFER TO THE FIRE PROTECTION DRAWINGS.

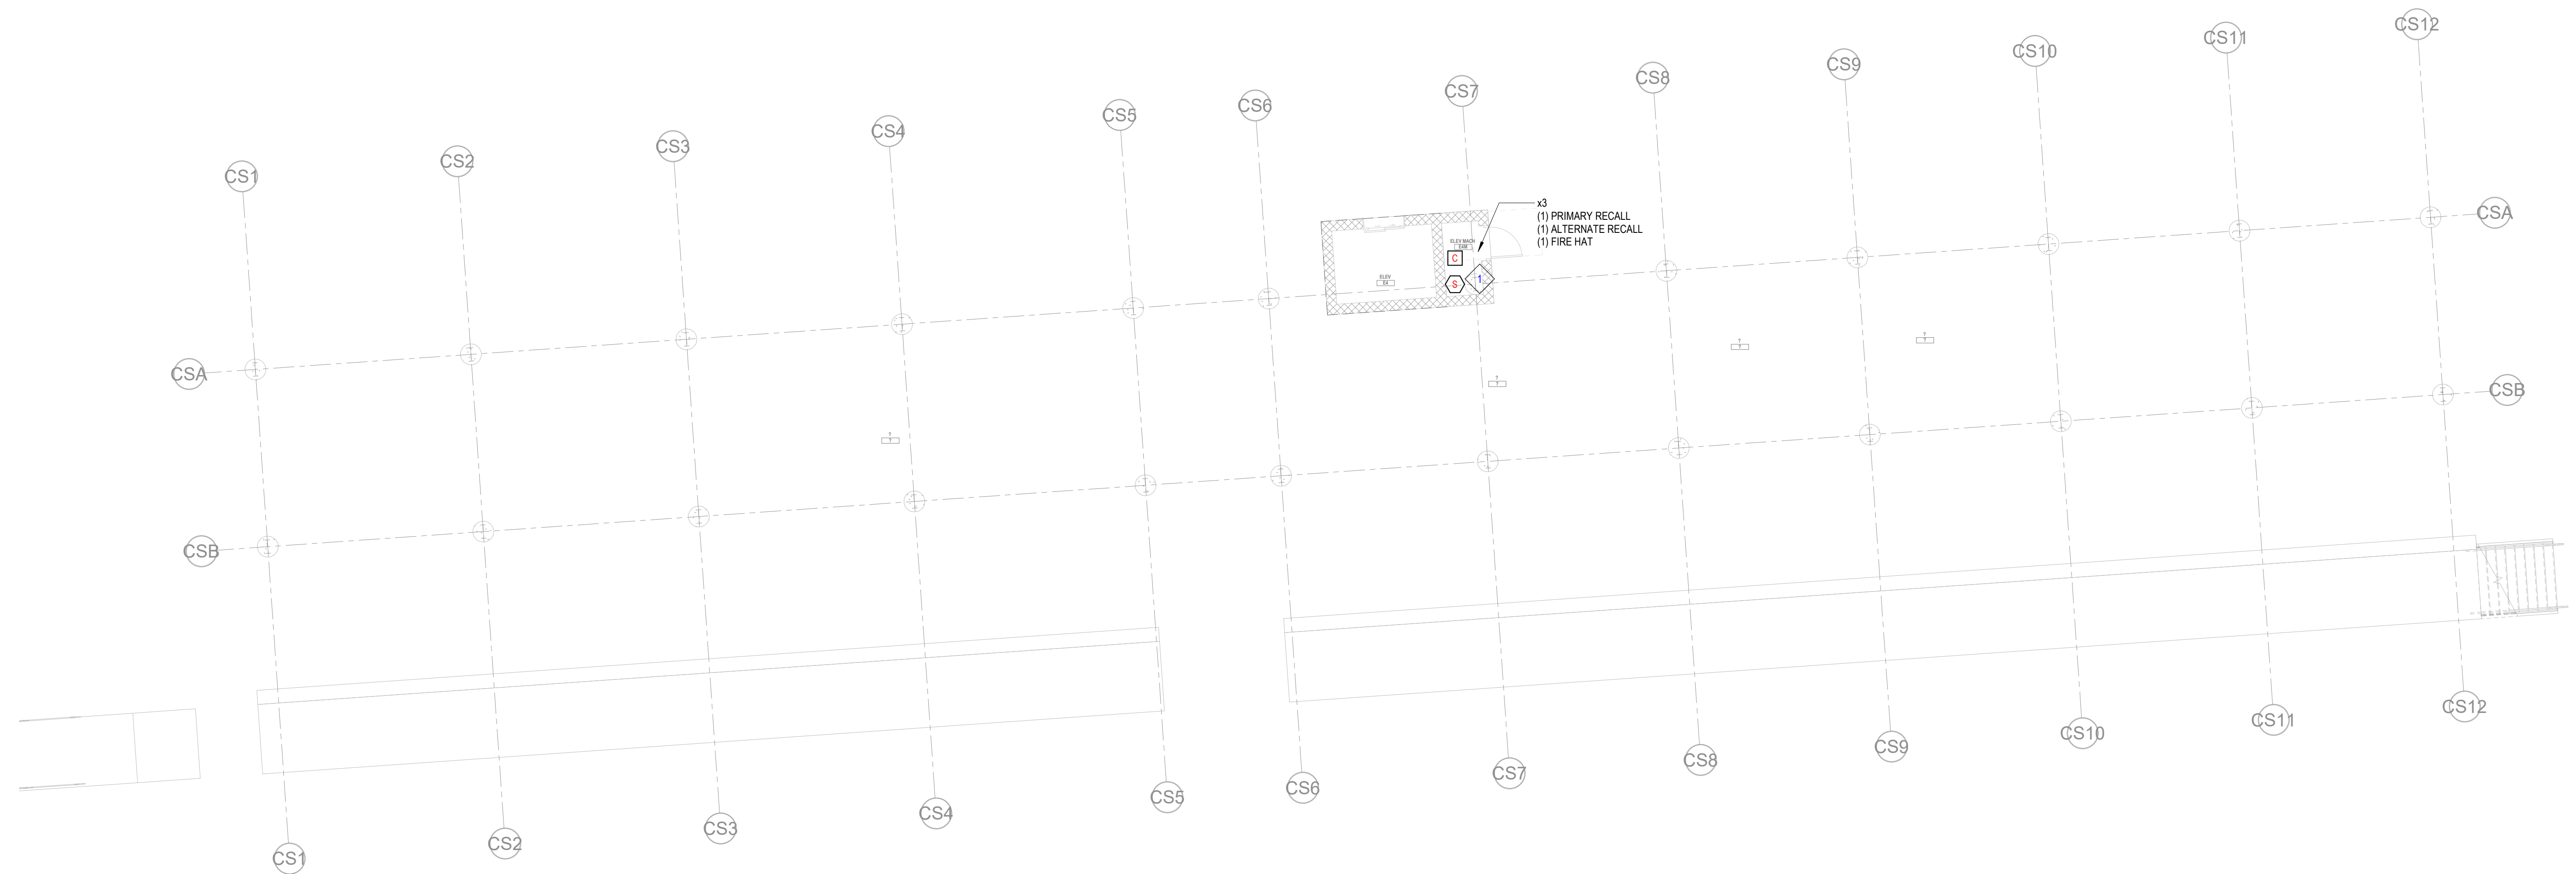

2 FIRE ALARM CONCESSION BUILDING PLAN  
FA1-1-CB 1/8" = 1'-0"

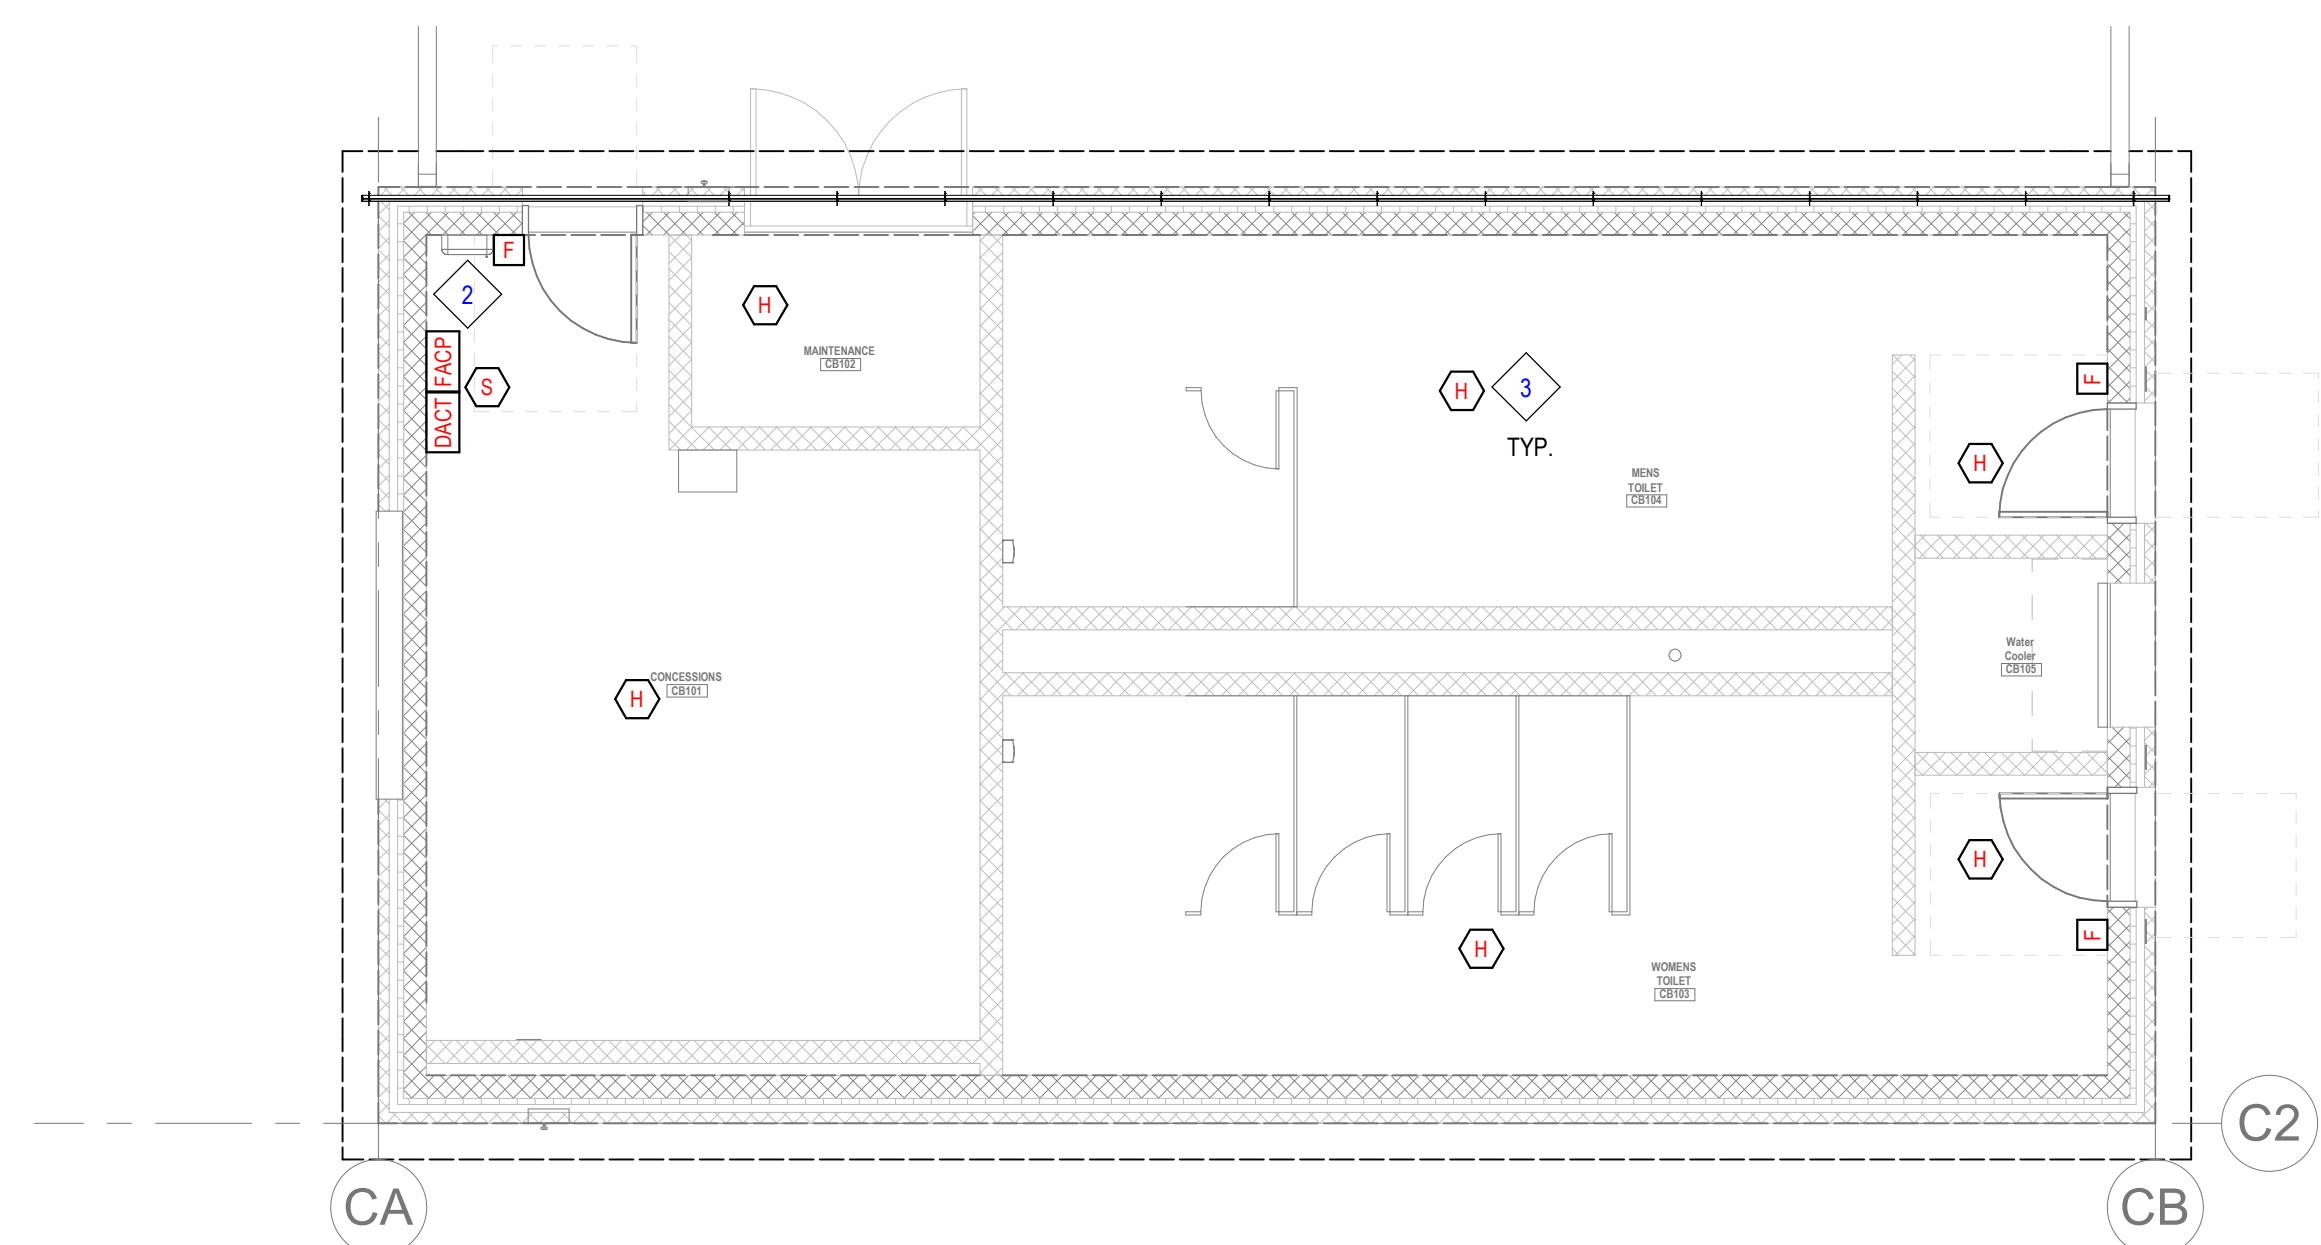

1 FIRE ALARM - CONCESSIONS FLOOR LEVEL PLAN  
3/16" = 1'-0"

DRA

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South Windsor, CT  
06074

280 Charles Street  
Studio 300  
Waltham, MA  
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WWW.BALA-ENGINEERS.COM

MSBA DESIGN  
DEVELOPMENT  
SUBMISSION  
August 4th, 2022

A B C  
D

KEY PLAN

PROJECT NORTH  
MAGNETIC NORTH

FIRE ALARM  
CONCESSION  
BUILDING PLAN

Scale: As indicated  
Job No.: 20202  
Drawn By: DRA  
Date: August 4th, 2022

FA1-1-CB





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225 Oakland Road  
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Regional  
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School

Wakefield, MA 01880

GENERAL FIRE ALARM NOTES:

1. PROVIDE A FULLY OPERATIONAL, TEMPORARY FIRE ALARM SYSTEM DURING ALL WORK, APPROVED BY LOCAL FIRE DEPARTMENT. PROVIDE FIRE ALARM SYSTEM PROGRAMMING AND TESTING ACCORDING TO LOCAL FIRE DEPARTMENT REQUESTS. TEMPORARY SYSTEM SHALL REMAIN UNTIL NEW SYSTEM HAS BEEN APPROVED FOR OPERATION.
2. COORDINATE LOCATION OF FIRE ALARM APPLIANCES AND DEVICES IN AREAS WITH CEILING SYSTEM, DUCTWORK, FIXTURES, FURNITURE, AND OTHER EQUIPMENT PRIOR TO ALL WORK.
3. FINAL LOCATIONS AND ARRANGEMENTS OF FIRE ALARM DEVICES SHALL BE OBTAINED FROM THE ARCHITECTURAL REFLECTED CEILING PLAN AND ELEVATION VIEWS.
4. FOR EXACT LOCATIONS OF SMOKE/FIRE DAMPERS, DUCT-MOUNTED SMOKE DETECTORS, WATER FLOW SWITCHES AND VALVE TAMPER SWITCHES, REFER TO FIRE PROTECTION, PLUMBING AND MECHANICAL/HVAC DRAWINGS.
5. MOUNTING HEIGHTS SHALL BE TO CENTER OF DEVICE OR EQUIPMENT, UNLESS OTHERWISE NOTED.
6. PROVIDE RACEWAY, CONDUCTORS AND CABLE ASSOCIATED FITTINGS AND CONNECTORS, AND COMPLETE CONNECTIONS REQUIRED FOR DESIGNATED FIRE ALARM BRANCH CIRCUITS FROM DEVICES TO FIRE ALARM TERMINAL CABINET(S) OR FIRE ALARM CONTROL PANEL OR FIRE COMMAND CENTER PER FIRE ALARM PRODUCT MANUFACTURER REQUIREMENTS.
7. PROVIDE ADDITIONAL POWER SUPPLIES, AMPLIFICATION AND BATTERY BACKUP TO SUPPORT NEW/ADDED DEVICES.
8. PROVIDE TEMPORARY HEAT DETECTORS AS REQUIRED BY LOCAL FIRE DEPARTMENT.
9. PROVIDE NEW AV DEVICES WITH INTEGRAL SYNCHRONIZATION CAPABILITIES AND/OR PROVIDE SYNCHRONIZATION MODULES FOR SYNCHRONIZATION OF ALL VISUAL DEVICES.
10. THE SCOPE OF THIS PROJECT SHALL IN NO WAY IMPACT THE DAILY OPERATION OR THE SEQUENCE OF OPERATION OF THE EXISTING FIRE ALARM SYSTEM.
11. PROVIDE ALL PROGRAMMING/RE-PROGRAMMING PER REVISED SPACE DESIGNATIONS.
12. PROVIDE ALL PRETESTS AND FINAL TESTS PER TOWN OF STONEHAM FIRE DEPARTMENT.
13. PROVIDE FIRE ALARM INTERFACE TO BRING ALL DIMMED LUMINAIRES TO FULL BRIGHTNESS UPON ALARM.
14. PROVIDE FIRE ALARM INTERFACE TO SHUNT ALL AV AND/OR SOUND EQUIPMENT.
15. PROVIDE FIRE ALARM INTERFACE TO RELEASE ALL SECURITY DEVICES.
16. A TAMPER SWITCH SHALL BE PROVIDED AT EACH ISOLATION CONTROL VALVE SERVING THE COMBINATION STANDPIPE/SPRINKLER SYSTEM. FOR MORE INFORMATION REFER TO THE FIRE PROTECTION DRAWINGS.
17. A FLOW AND SUPERVISORY SWITCH SHALL BE PROVIDED FOR EACH CONTROL VALVE ASSEMBLY. FOR MORE INFORMATION REFER TO THE FIRE PROTECTION DRAWINGS.

KEYNOTES:

1. PROVIDE SMOKE DETECTOR TO INITIATE ELEVATOR RECALL.
2. PROVIDE WEATHER PROOF DEVICE NOTE.

KEYNOTE

1. PROVIDE A SMOKE DETECTOR TO INITIATE ELEVATOR RECALL.
2. PROVIDE WEATHERPROOF SPEAKERSTROBE.
3. PROVIDE A NEW ANALOG ADDRESSABLE FIRE ALARM CONTROL PANEL UNIT. A DIGITAL ALARM COMMUNICATION TRANSMITTER SHALL BE PROVIDED TO TRANSMIT SIGNALS OFF-SITE.




1  
FA1-1-LB  
1/8" = 1'-0"




2  
FA1-1-LB  
1/8" = 1'-0"



MSBA DESIGN  
DEVELOPMENT  
SUBMISSION  
August 4th, 2022

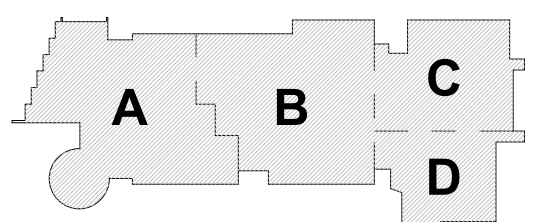

KEY PLAN

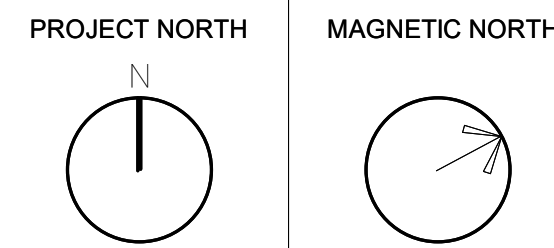

FIRE ALARM  
LOCKER  
BUILDING PLAN

Scale: 1/8" = 1'-0"  
Job No.: 20202  
Drawn By: DRA  
Date: August 4th, 2022

FA1-1-LB





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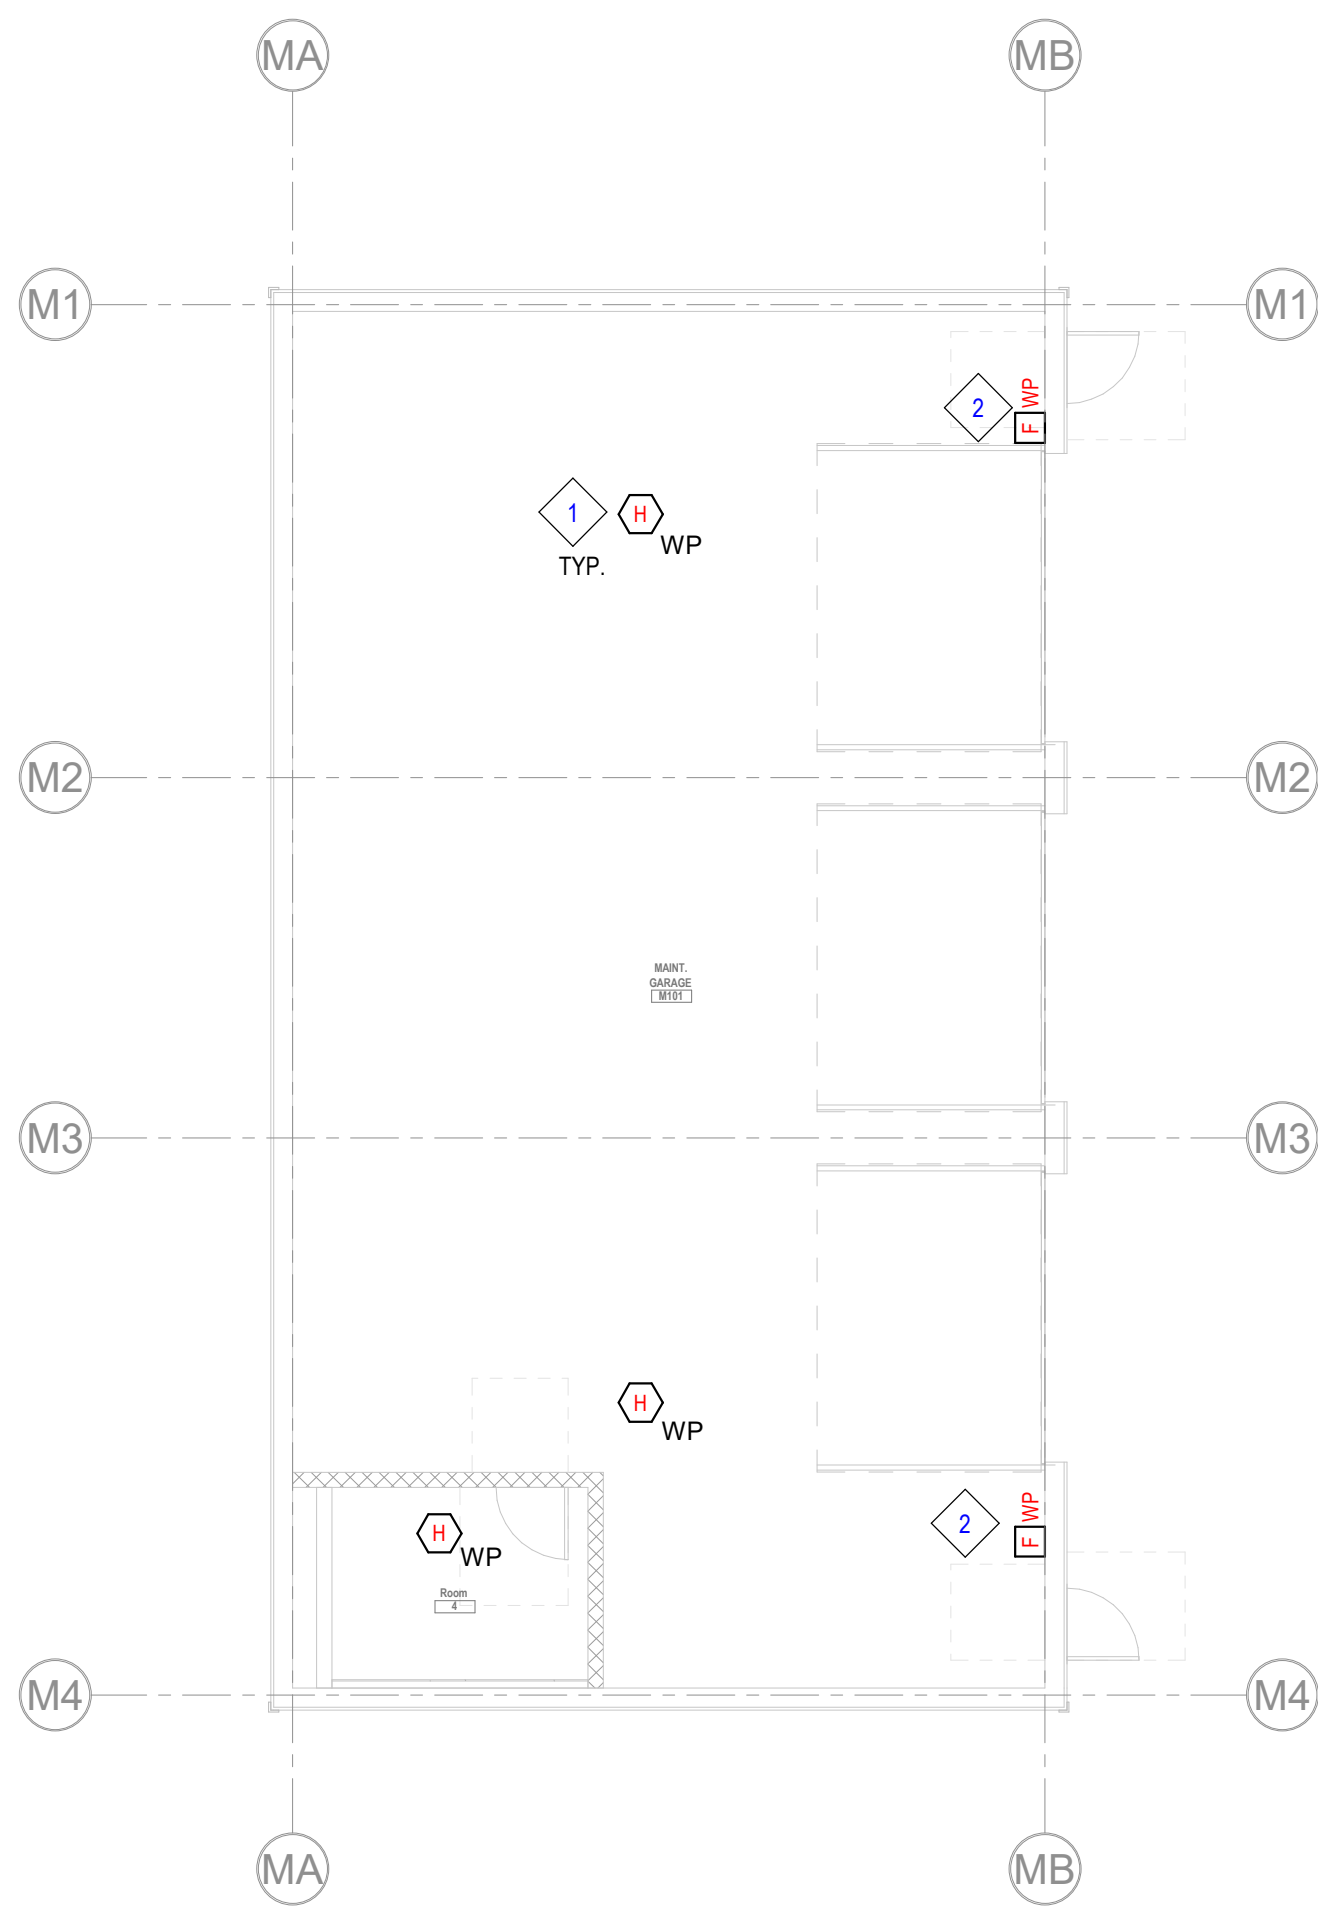
Wakefield, MA 01880

GENERAL FIRE ALARM NOTES:

1. PROVIDE A FULLY OPERATIONAL, TEMPORARY FIRE ALARM SYSTEM DURING ALL WORK, APPROVED BY LOCAL FIRE DEPARTMENT. PROVIDE FIRE ALARM SYSTEM PROGRAMMING AND TESTING ACCORDING TO LOCAL FIRE DEPARTMENT REQUESTS. TEMPORARY SYSTEM SHALL REMAIN UNTIL NEW SYSTEM HAS BEEN APPROVED FOR OPERATION.
2. COORDINATE LOCATION OF FIRE ALARM APPLIANCES AND DEVICES IN AREAS WITH CEILING SYSTEM, DUCTWORK, FIXTURES, FURNITURE, AND OTHER EQUIPMENT PRIOR TO ALL WORK.
3. FINAL LOCATIONS AND ARRANGEMENTS OF FIRE ALARM DEVICES SHALL BE OBTAINED FROM THE ARCHITECTURAL REFLECTED CEILING PLAN AND ELEVATION VIEWS.
4. FOR EXACT LOCATIONS OF SMOKE/FIRE DAMPERS, DUCT-MOUNTED SMOKE DETECTORS, WATER FLOW SWITCHES AND VALVE TAMPER SWITCHES, REFER TO FIRE PROTECTION, PLUMBING AND MECHANICAL/HVAC DRAWINGS.
5. MOUNTING HEIGHTS SHALL BE TO CENTER OF DEVICE OR EQUIPMENT, UNLESS OTHERWISE NOTED.
6. PROVIDE RACEWAY, CONDUCTORS AND CABLE, ASSOCIATED FITTINGS AND CONNECTORS, AND COMPLETE CONNECTIONS REQUIRED FOR DESIGNATED FIRE ALARM BRANCH CIRCUITS FROM DEVICES(S) TO FIRE ALARM TERMINAL CABINET(S) OR FIRE ALARM CONTROL PANEL OR FIRE COMMAND CENTER PER FIRE ALARM PRODUCT MANUFACTURER REQUIREMENTS.
7. PROVIDE ADDITIONAL POWER SUPPLIES, AMPLIFICATION AND BATTERY BACKUP TO SUPPORT NEW/ADDED DEVICES.
8. PROVIDE TEMPORARY HEAT DETECTORS AS REQUIRED BY LOCAL FIRE DEPARTMENT.
9. PROVIDE NEW AV DEVICES WITH INTEGRAL SYNCHRONIZATION CAPABILITIES AND/OR PROVIDE SYNCHRONIZATION MODULES FOR SYNCHRONIZATION OF ALL VISUAL DEVICES.
10. THE SCOPE OF THIS PROJECT SHALL IN NO WAY IMPACT THE DAILY OPERATION OR THE SEQUENCE OF OPERATION OF THE EXISTING FIRE ALARM SYSTEM.
11. PROVIDE ALL PROGRAMMING/RE-PROGRAMMING PER REVISED SPACE DESIGNATIONS.
12. PROVIDE ALL PRETESTS AND FINAL TESTS PER TOWN OF STONEHAM FIRE DEPARTMENT.
13. PROVIDE FIRE ALARM INTERFACE TO BRING ALL DIMMED LUMINAIRES TO FULL BRIGHTNESS UPON ALARM.
14. PROVIDE FIRE ALARM INTERFACE TO SHUNT ALL AV AND/OR SOUND EQUIPMENT.
15. PROVIDE FIRE ALARM INTERFACE TO RELEASE ALL SECURITY DEVICES.
16. A TAMPER SWITCH SHALL BE PROVIDED AT EACH ISOLATION CONTROL VALVE SERVING THE COMBINATION STANDPIPE/SPRINKLER SYSTEM. FOR MORE INFORMATION REFER TO THE FIRE PROTECTION DRAWINGS.
17. A FLOW AND SUPERVISORY SWITCH SHALL BE PROVIDED FOR EACH CONTROL VALVE ASSEMBLY. FOR MORE INFORMATION REFER TO THE FIRE PROTECTION DRAWINGS.

KEY NOTES

1. PROVIDE A WEATHERPROOF HEAT DETECTORS RATED AT A FIXED TEMPERATURE OF 155 F.
2. PROVIDE A WEATHERPROOF PULL STATION




2 FIRE ALARM MAINTENANANCE BUILDING PLAN  
FA1-1-MB 1/8" = 1'-0"


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August 4th, 2022




KEY PLAN

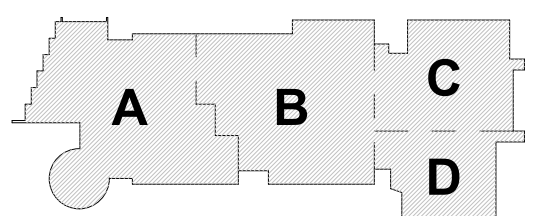

FIRE ALARM  
MAINTENANANCE  
BUILDING PLAN

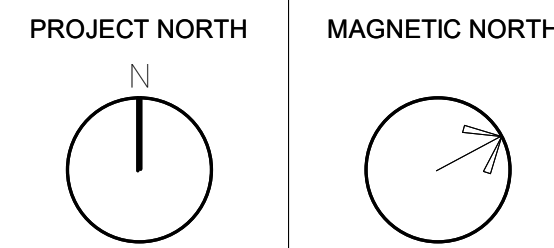Scale: 1/8" = 1'-0"  
Job No.: 20202  
Drawn By: DRA  
Date: August 4th, 2022  
FA1-1-MB



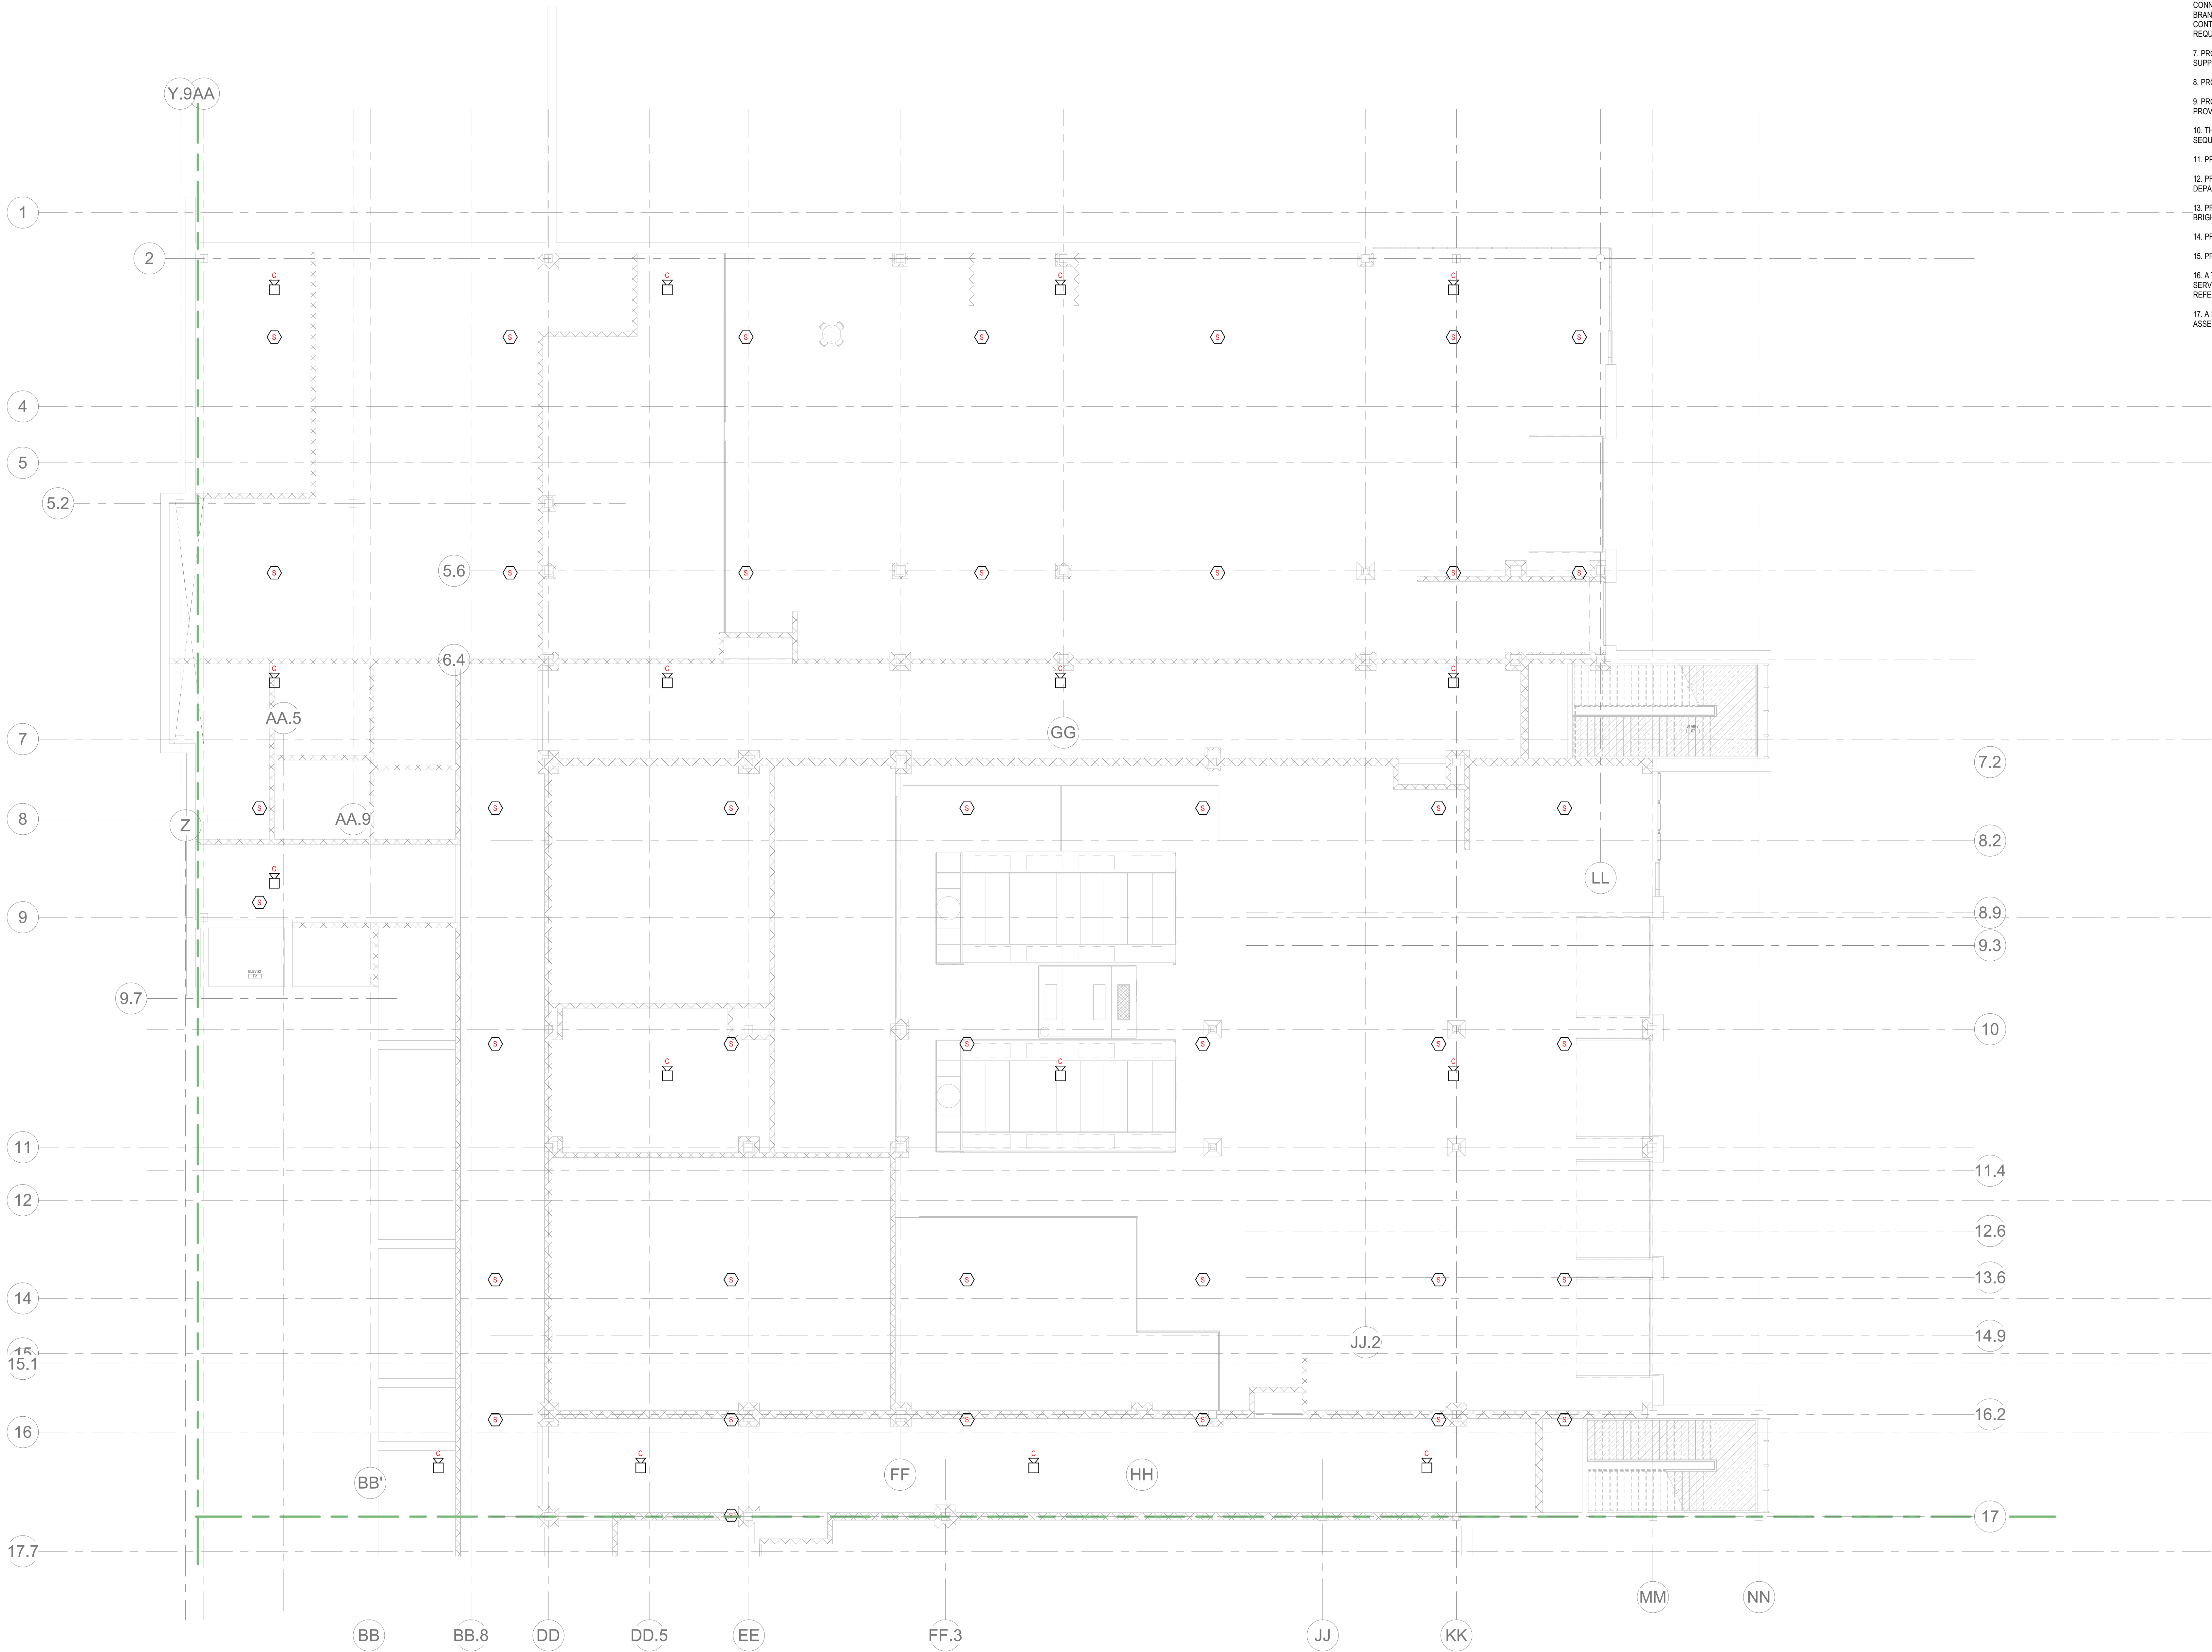

2 FIRE ALARM LOWER LEVEL MEZZANINE PLAN - AREA C  
KAT-1-MC 1/8" = 1'-0"

GENERAL FIRE ALARM NOTES:

1. PROVIDE A FULLY OPERATIONAL TEMPORARY FIRE ALARM SYSTEM DURING ALL WORK, APPROVED BY LOCAL FIRE DEPARTMENT. PROVIDE FIRE ALARM SYSTEM PROGRAMMING AND TESTING ACCORDING TO LOCAL FIRE DEPARTMENT REQUESTS. TEMPORARY SYSTEM SHALL REMAIN UNTIL NEW SYSTEM HAS BEEN APPROVED FOR OPERATION.
2. COORDINATE LOCATION OF FIRE ALARM APPLIANCES AND DEVICES IN AREAS WITH CEILING SYSTEM, DUCTWORK, FIXTURES, FURNITURE, AND OTHER EQUIPMENT PRIOR TO ALL WORK.
3. FINAL LOCATIONS AND ARRANGEMENTS OF FIRE ALARM DEVICES SHALL BE OBTAINED FROM THE ARCHITECTURAL REFLECTED CEILING PLAN AND ELEVATION VIEWS.
4. FOR EXACT LOCATIONS OF SMOKE/FIRE DAMPERS, DUCT-MOUNTED SMOKE DETECTORS, WATER FLOW SWITCHES AND VALVE TAMPER SWITCHES, REFER TO FIRE PROTECTION, PLUMBING AND MECHANICAL/MEV DRAWINGS.
5. MOUNTING HEIGHTS SHALL BE TO CENTER OF DEVICE OR EQUIPMENT, UNLESS OTHERWISE NOTED.
6. PROVIDE RACEWAY, CONDUCTORS AND CABLE, ASSOCIATED FITTINGS AND CONNECTORS, AND COMPLETE CONNECTIONS REQUIRED FOR DESIGNATED FIRE ALARM BRANCH CIRCUITS FROM DEVICES TO FIRE ALARM TERMINAL CABINETS (OR FIRE ALARM CONTROL PANEL OR FIRE COMMAND CENTER PER FIRE ALARM PRODUCT MANUFACTURER REQUIREMENTS).
7. PROVIDE ADDITIONAL POWER SUPPLIES, AMPLIFICATION AND BATTERY BACKUP TO SUPPORT NEW/ADDED DEVICES.
8. PROVIDE TEMPORARY HEAT DETECTORS AS REQUIRED BY LOCAL FIRE DEPARTMENT.
9. PROVIDE NEW AN DEVICES WITH INTEGRAL SYNCHRONIZATION CAPABILITIES AND/OR PROVIDE SYNCHRONIZATION MODULES FOR SYNCHRONIZATION OF ALL VISUAL DEVICES.
10. THE SCOPE OF THIS PROJECT SHALL IN NO WAY IMPACT THE DAILY OPERATION OR THE SEQUENCE OF OPERATION OF THE EXISTING FIRE ALARM SYSTEM.
11. PROVIDE ALL PROGRAMMING/RE-PROGRAMMING PER REVISED SPACE DESIGNATIONS.
12. PROVIDE ALL PRETESTS AND FINAL TESTS PER TOWN OF STONEHAM FIRE DEPARTMENT.
13. PROVIDE FIRE ALARM INTERFACE TO BRING ALL DIMMED LUMINAIRES TO FULL BRIGHTNESS UPON ALARM.
14. PROVIDE FIRE ALARM INTERFACE TO SHUNT ALL AN AND/OR SOUND EQUIPMENT.
15. PROVIDE FIRE ALARM INTERFACE TO RELEASE ALL SECURITY DEVICES.
16. A TAMPER SWITCH SHALL BE PROVIDED AT EACH ISOLATION CONTROL VALVE SERVING THE COMBINATION STANDPIPE/SPRINKLER SYSTEM. FOR MORE INFORMATION REFER TO THE FIRE PROTECTION DRAWINGS.
17. A FLOW AND SUPERVISORY SWITCH SHALL BE PROVIDED FOR EACH CONTROL VALVE ASSEMBLY. FOR MORE INFORMATION REFER TO THE FIRE PROTECTION DRAWINGS.



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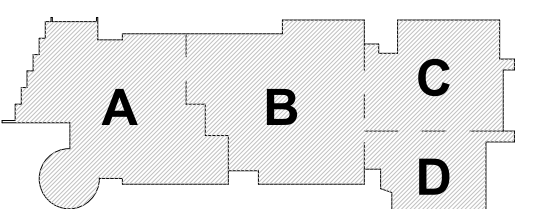
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Regional  
Vocational High  
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Wakefield, MA 01880


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August 4th, 2022




KEY PLAN



FIRE ALARM  
LOWER LEVEL  
MEZZANINE  
PLAN - AREA C

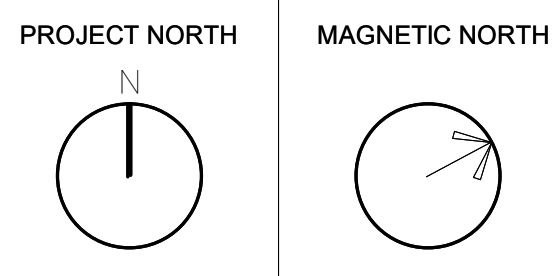Scale: 1/8" = 1'-0"  
Job No.: 20202  
Drawn By: DRA  
Date: August 4th, 2022  
FA1-1-MC



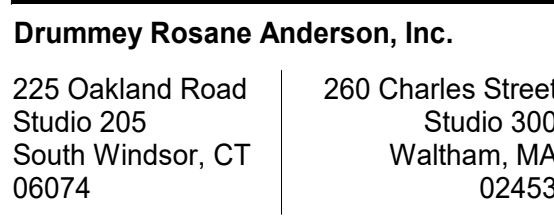

**Northeast  
Metropolitan  
Regional  
Vocational High  
School**


Wakefield, MA 01880

17. A FLOW AND SUPERVISORY SWITCH SHALL BE PROVIDED FOR EACH CONTROL VALVE ASSEMBLY. FOR MORE INFORMATION REFER TO THE FIRE PROTECTION DRAWINGS.




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ENGINEERS

MSBA DESIGN  
DEVELOPMENT  
SUBMISSION  
August 4th, 2022

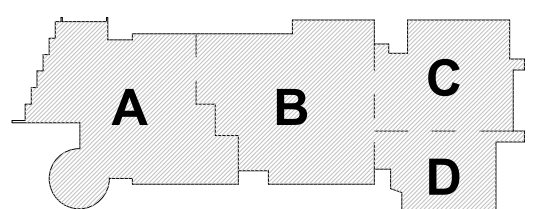

### KEY PLAN

PROJECT NORTH	MAGNETIC NORTH
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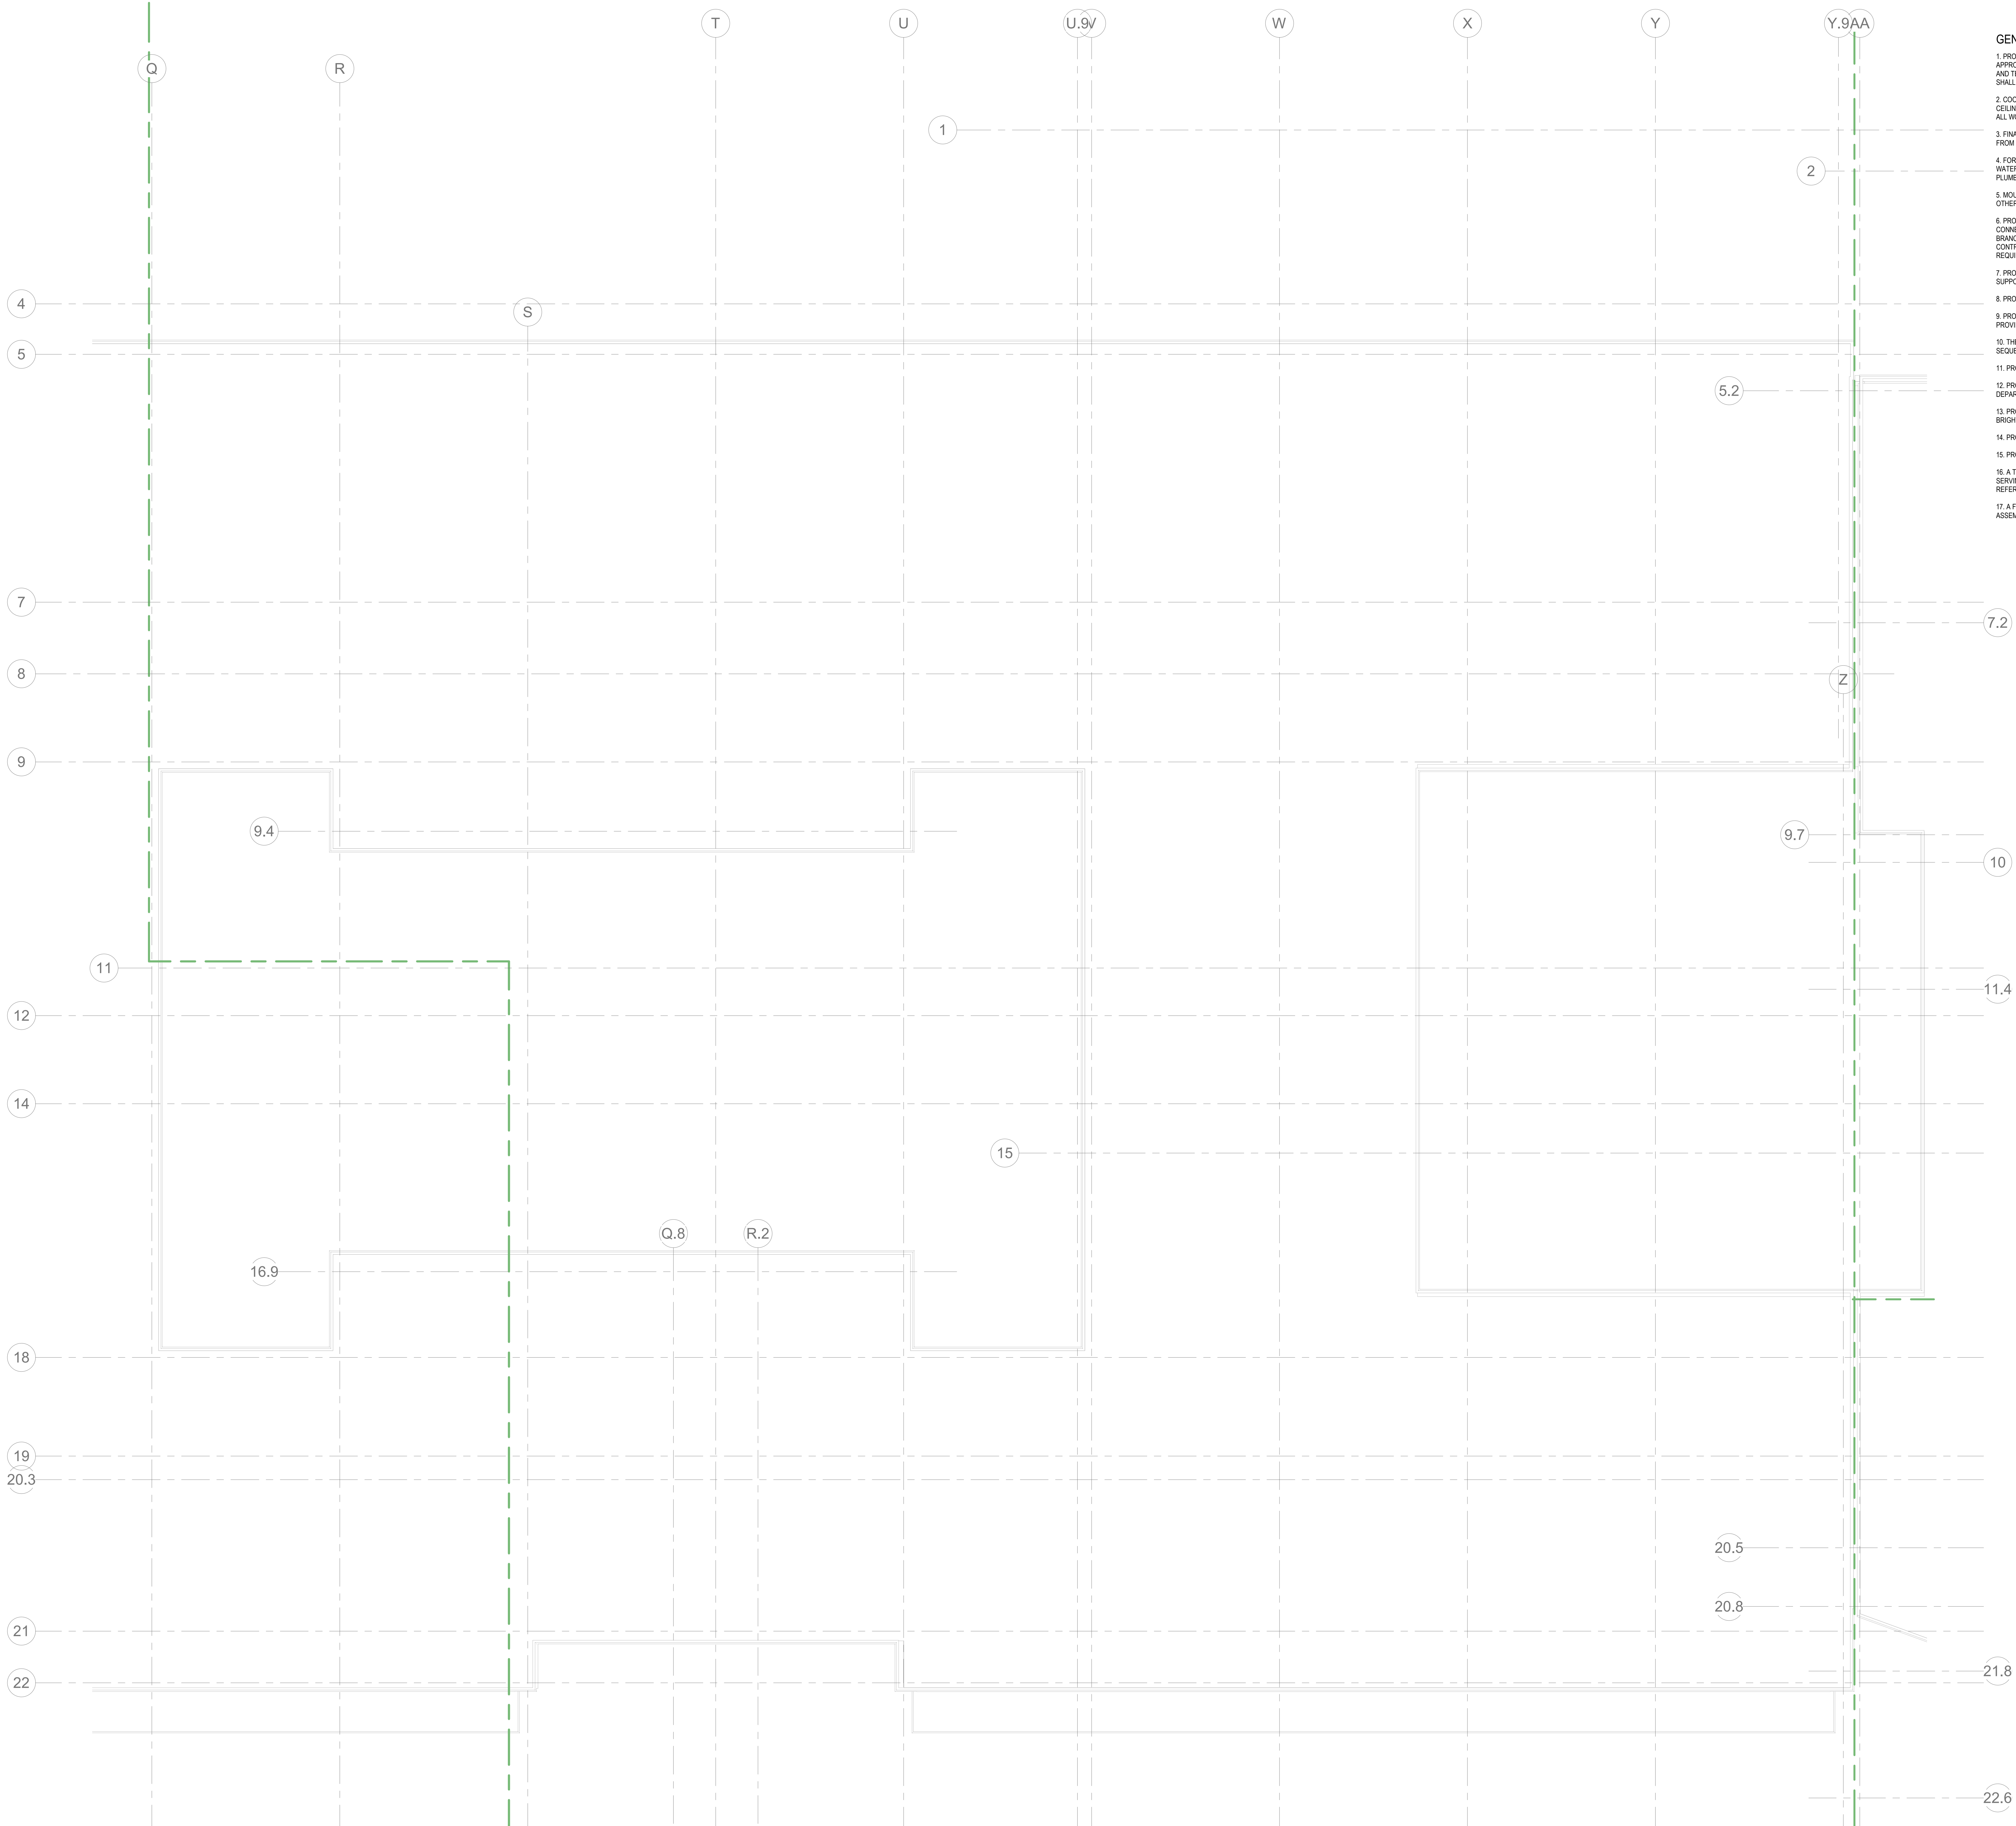
**FIRE ALARM  
ROOF PLAN -  
AREA A**

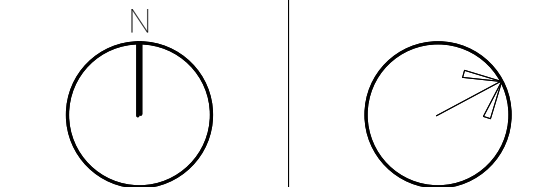Scale: 1" = 10'-0"  
 Job No.: 20202  
 Drawn By: DRA  
 Date: August 4th, 2022



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FA1-2-1A






- GENERAL FIRE ALARM NOTES:**
1. PROVIDE A FULLY OPERATIONAL TEMPORARY FIRE ALARM SYSTEM DURING ALL WORK, APPROVED BY LOCAL FIRE DEPARTMENT. PROVIDE FIRE ALARM SYSTEM PROGRAMMING AND TESTING ACCORDING TO LOCAL FIRE DEPARTMENT REQUESTS. TEMPORARY SYSTEM SHALL REMAIN UNTIL NEW SYSTEM HAS BEEN APPROVED FOR OPERATION.
  2. COORDINATE LOCATION OF FIRE ALARM APPLIANCES AND DEVICES IN AREAS WITH CEILING SYSTEM, DUCTWORK, FIXTURES, FURNITURE, AND OTHER EQUIPMENT PRIOR TO ALL WORK.
  3. FINAL LOCATIONS AND ARRANGEMENTS OF FIRE ALARM DEVICES SHALL BE OBTAINED FROM THE ARCHITECTURAL REFLECTED CEILING PLAN AND ELEVATION VIEWS.
  4. FOR EXACT LOCATIONS OF SMOKE/FIRE DAMPERS, DUCT-MOUNTED SMOKE DETECTORS, WATER FLOW SWITCHES AND VALVE TAMPER SWITCHES, REFER TO FIRE PROTECTION, PLUMBING AND MECHANICAL/PAVING DRAWINGS.
  5. MOUNTING HEIGHTS SHALL BE TO CENTER OF DEVICE OR EQUIPMENT, UNLESS OTHERWISE NOTED.
  6. PROVIDE RACEWAY, CONDUCTORS AND CABLE, ASSOCIATED FITTINGS AND CONNECTORS, AND COMPLETE CONNECTIONS REQUIRED FOR DESIGNATED FIRE ALARM BRANCH CIRCUITS FROM DEVICES TO FIRE ALARM TERMINAL CABINETS (OR FIRE ALARM CONTROL PANEL OR FIRE COMMAND CENTER PER FIRE ALARM PRODUCT MANUFACTURER REQUIREMENTS).
  7. PROVIDE ADDITIONAL POWER SUPPLIES, AMPLIFICATION AND BATTERY BACKUP TO SUPPORT NEW/ADDED DEVICES.
  8. PROVIDE TEMPORARY HEAT DETECTORS AS REQUIRED BY LOCAL FIRE DEPARTMENT.
  9. PROVIDE NEW AV DEVICES WITH INTEGRAL SYNCHRONIZATION CAPABILITIES AND/OR PROVIDE SYNCHRONIZATION MODULES FOR SYNCHRONIZATION OF ALL VISUAL DEVICES.
  10. THE SCOPE OF THIS PROJECT SHALL IN NO WAY IMPACT THE DAILY OPERATION OR THE SEQUENCE OF OPERATION OF THE EXISTING FIRE ALARM SYSTEM.
  11. PROVIDE ALL PROGRAMMING/RE-PROGRAMMING PER REVISED SPACE DESIGNATIONS.
  12. PROVIDE ALL PRETESTS AND FINAL TESTS PER TOWN OF STONEHAM FIRE DEPARTMENT.
  13. PROVIDE FIRE ALARM INTERFACE TO BRING ALL DIMMED LUMINAIRES TO FULL BRIGHTNESS UPON ALARM.
  14. PROVIDE FIRE ALARM INTERFACE TO SHUNT ALL AV AND/OR SOUND EQUIPMENT.
  15. PROVIDE FIRE ALARM INTERFACE TO RELEASE ALL SECURITY DEVICES.
  16. A TAMPER SWITCH SHALL BE PROVIDED AT EACH ISOLATION CONTROL VALVE SERVING THE COMBINATION STANDPIPE/SPRINKLER SYSTEM. FOR MORE INFORMATION REFER TO THE FIRE PROTECTION DRAWINGS.
  17. A FLOW AND SUPERVISORY SWITCH SHALL BE PROVIDED FOR EACH CONTROL VALVE ASSEMBLY. FOR MORE INFORMATION REFER TO THE FIRE PROTECTION DRAWINGS.

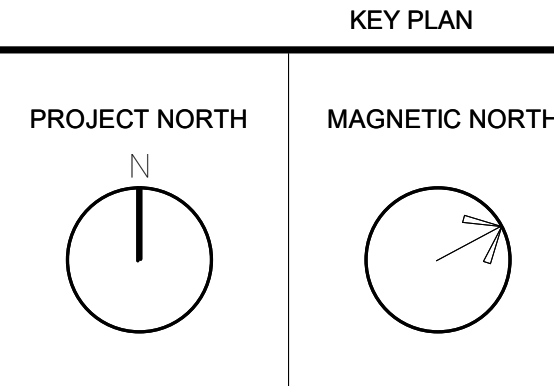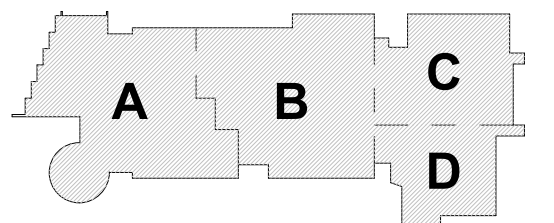

**FIRE ALARM  
ROOF PLAN -  
AREA B**



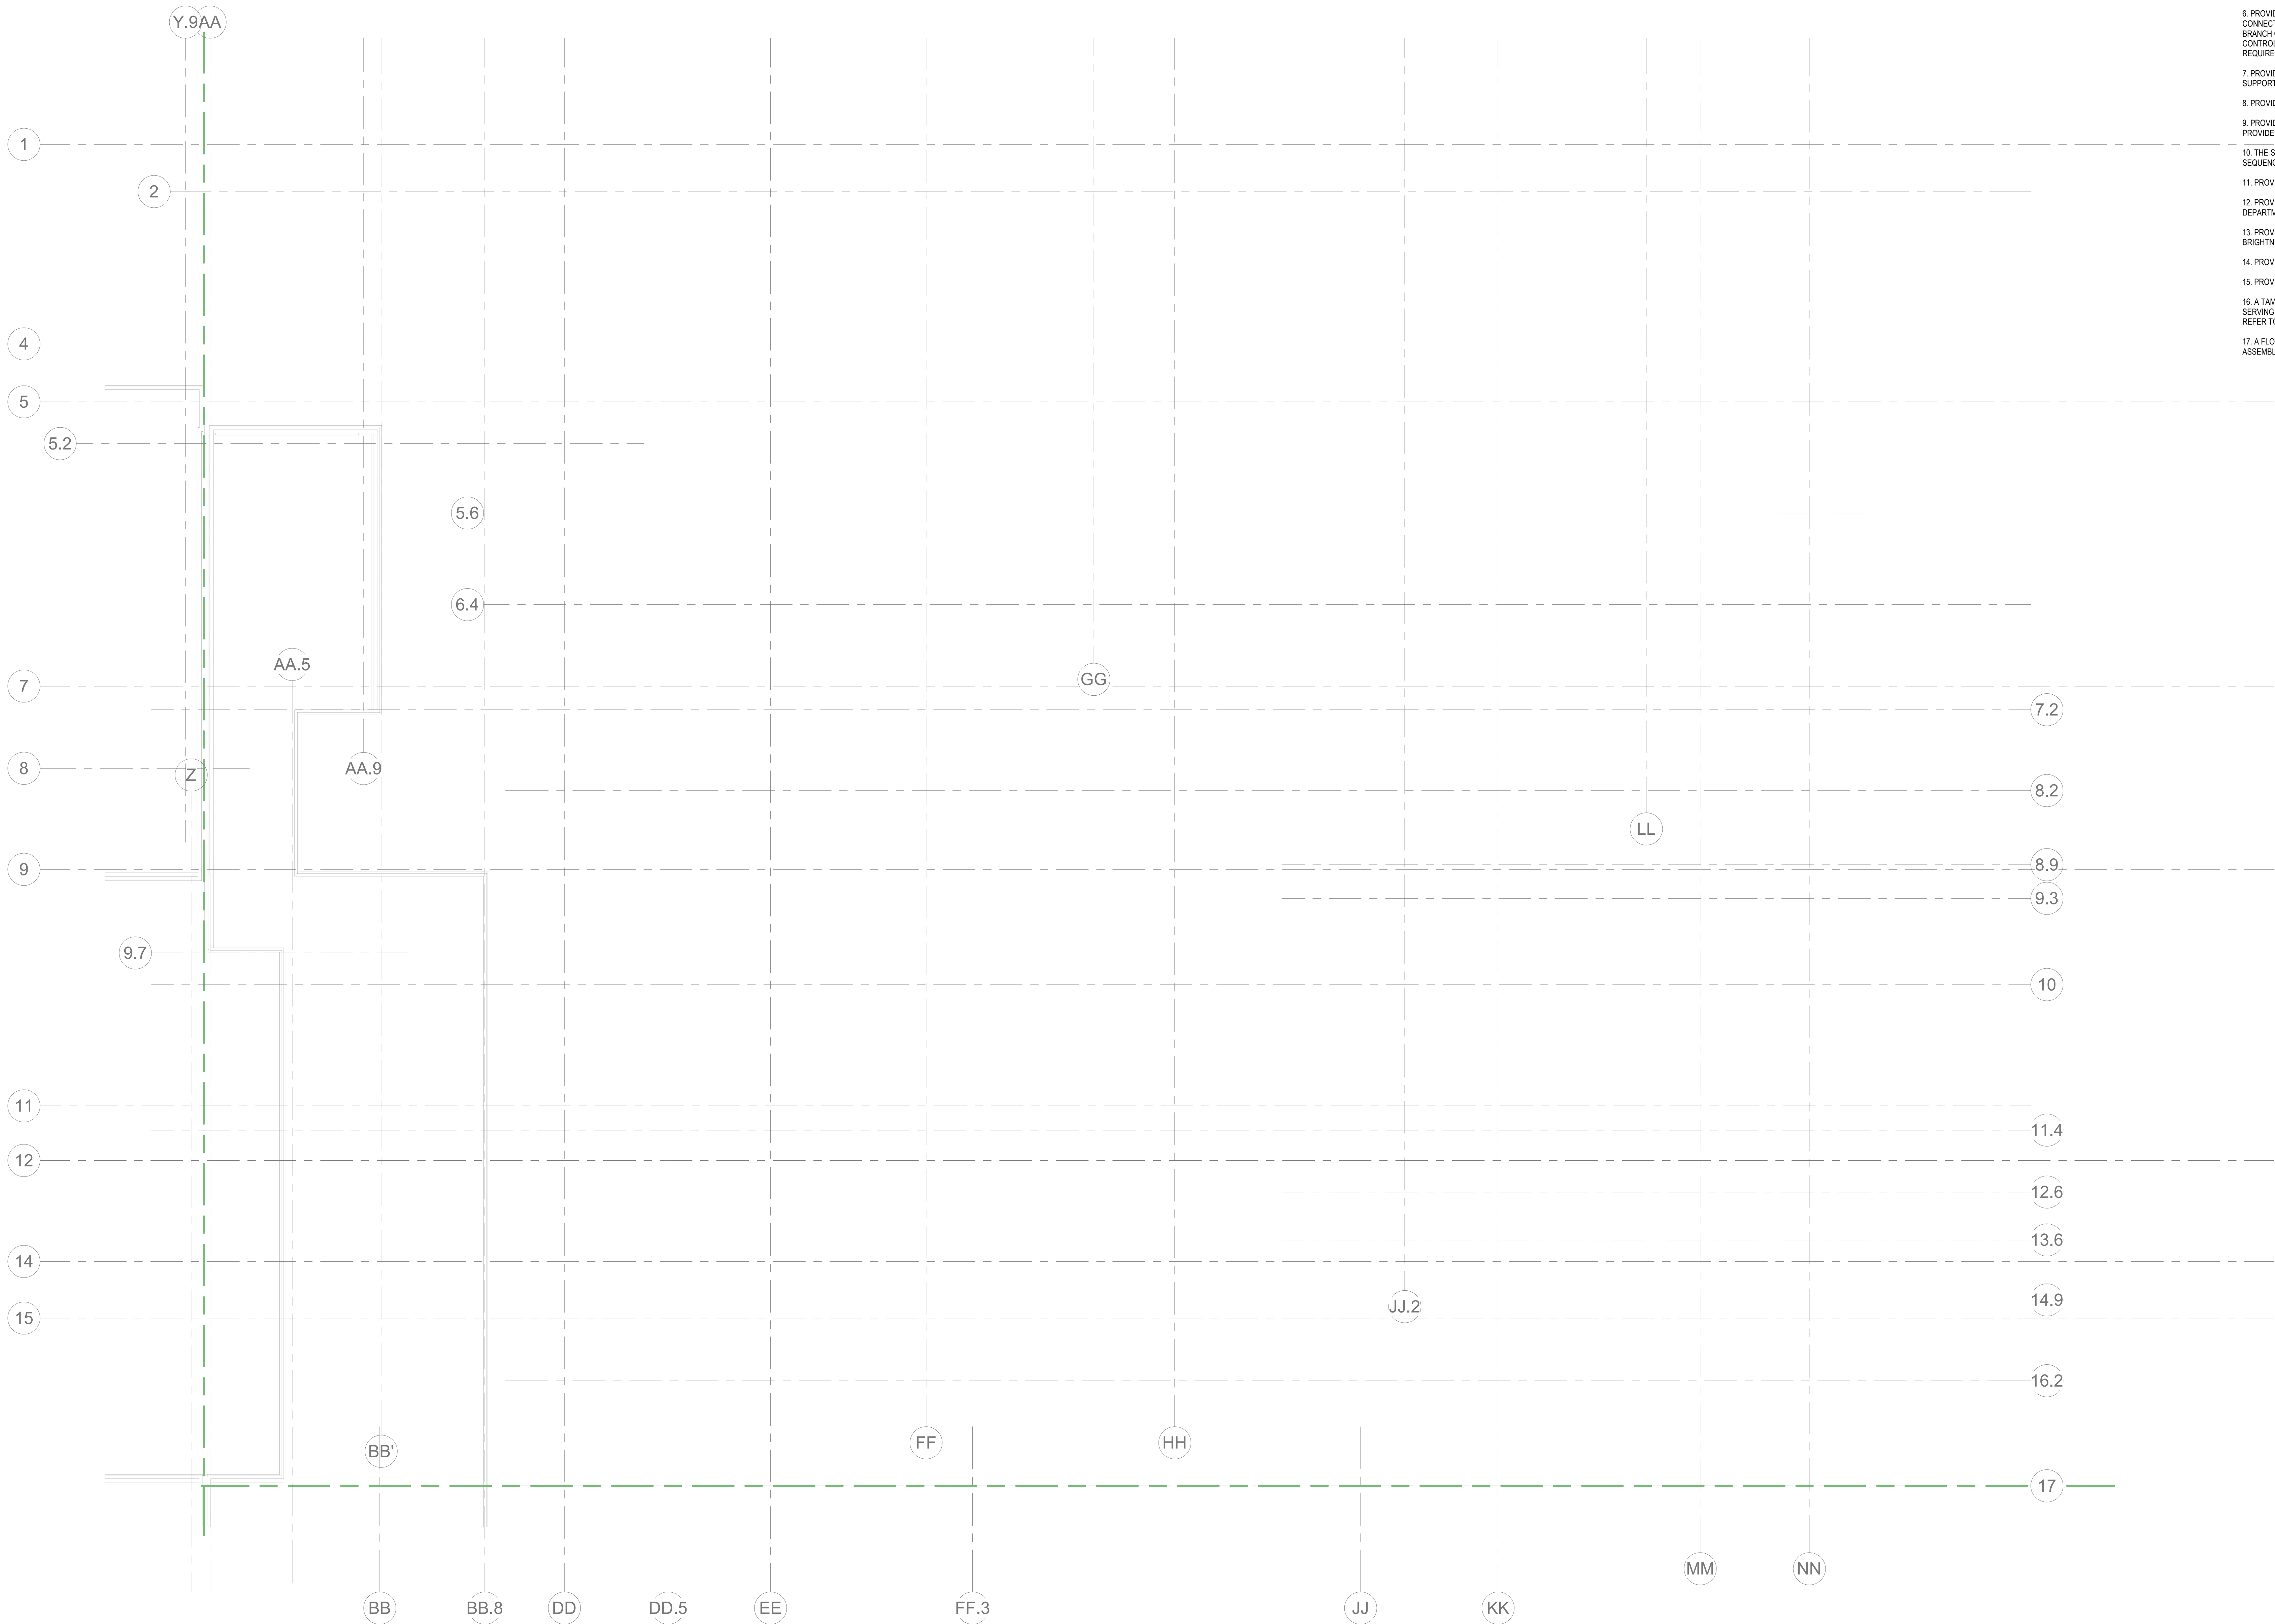

1 FIRE ALARM ROOF PLAN - AREA C  
1/8" = 1'-0"

- GENERAL FIRE ALARM NOTES:
1. PROVIDE A FULLY OPERATIONAL TEMPORARY FIRE ALARM SYSTEM DURING ALL WORK, APPROVED BY LOCAL FIRE DEPARTMENT. PROVIDE FIRE ALARM SYSTEM PROGRAMMING AND TESTING ACCORDING TO LOCAL FIRE DEPARTMENT REQUESTS. TEMPORARY SYSTEM SHALL REMAIN UNTIL NEW SYSTEM HAS BEEN APPROVED FOR OPERATION.
  2. COORDINATE LOCATION OF FIRE ALARM APPLIANCES AND DEVICES IN AREAS WITH CEILING SYSTEM, DUCTWORK, FIXTURES, FURNITURE, AND OTHER EQUIPMENT PRIOR TO ALL WORK.
  3. FINAL LOCATIONS AND ARRANGEMENTS OF FIRE ALARM DEVICES SHALL BE OBTAINED FROM THE ARCHITECTURAL REFLECTED CEILING PLAN AND ELEVATION VIEWS.
  4. FOR EXACT LOCATIONS OF SMOKE/FIRE DAMPERS, DUCT-MOUNTED SMOKE DETECTORS, WATER FLOW SWITCHES AND VALVE TAMPER SWITCHES, REFER TO FIRE PROTECTION, PLUMBING AND MECHANICAL/VAC. DRAWINGS.
  5. MOUNTING HEIGHTS SHALL BE TO CENTER OF DEVICE OR EQUIPMENT, UNLESS OTHERWISE NOTED.
  6. PROVIDE RACEWAY, CONDUCTORS AND CABLE, ASSOCIATED FITTINGS AND CONNECTORS, AND COMPLETE CONNECTIONS REQUIRED FOR DESIGNATED FIRE ALARM BRANCH CIRCUITS FROM DEVICES TO FIRE ALARM TERMINAL CABINETS (S) OR FIRE ALARM CONTROL PANEL OR FIRE COMMAND CENTER PER FIRE ALARM PRODUCT MANUFACTURER REQUIREMENTS.
  7. PROVIDE ADDITIONAL POWER SUPPLIES, AMPLIFICATION AND BATTERY BACKUP TO SUPPORT NEW/ADDED DEVICES.
  8. PROVIDE TEMPORARY HEAT DETECTORS AS REQUIRED BY LOCAL FIRE DEPARTMENT.
  9. PROVIDE NEW AND DEVICES WITH INTEGRAL SYNCHRONIZATION CAPABILITIES AND/OR PROVIDE SYNCHRONIZATION MODULES FOR SYNCHRONIZATION OF ALL VISUAL DEVICES.
  10. THE SCOPE OF THIS PROJECT SHALL IN NO WAY IMPACT THE DAILY OPERATION OR THE SEQUENCE OF OPERATION OF THE EXISTING FIRE ALARM SYSTEM.
  11. PROVIDE ALL PROGRAMMING/RE-PROGRAMMING PER REVISED SPACE DESIGNATIONS.
  12. PROVIDE ALL PRETESTS AND FINAL TESTS PER TOWN OF STONEHAM FIRE DEPARTMENT.
  13. PROVIDE FIRE ALARM INTERFACE TO BRING ALL DIMMED LUMINAIRES TO FULL BRIGHTNESS UPON ALARM.
  14. PROVIDE FIRE ALARM INTERFACE TO SHUNT ALL AV AND/OR SOUND EQUIPMENT.
  15. PROVIDE FIRE ALARM INTERFACE TO RELEASE ALL SECURITY DEVICES.
  16. A TAMPER SWITCH SHALL BE PROVIDED AT EACH ISOLATION CONTROL VALVE SERVING THE COMBINATION STANDPIPE/SPRINKLER SYSTEM. FOR MORE INFORMATION REFER TO THE FIRE PROTECTION DRAWINGS.
  17. A FLOW AND SUPERVISORY SWITCH SHALL BE PROVIDED FOR EACH CONTROL VALVE ASSEMBLY. FOR MORE INFORMATION REFER TO THE FIRE PROTECTION DRAWINGS.



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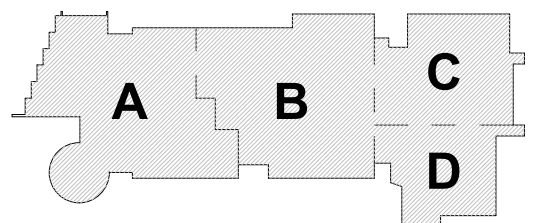
## Northeast Metropolitan Regional Vocational High School

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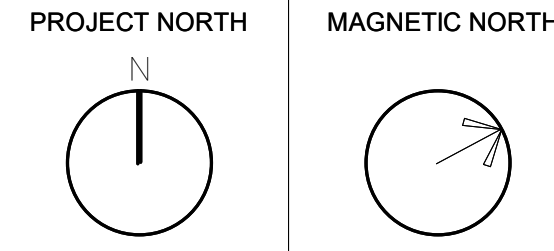
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KEY PLAN




## FIRE ALARM ROOF PLAN - AREA C

Scale: 1/8" = 1'-0"  
Job No.: 20202  
Drawn By: DRA  
Date: August 4th, 2022

FA1-2-1C



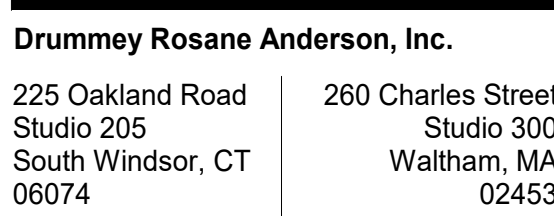

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1. PROVIDE A FULLY OPERATIONAL TEMPORARY FIRE ALARM SYSTEM DURING ALL WORK, APPROVED BY LOCAL FIRE DEPARTMENT. PROVIDE FIRE ALARM SYSTEM PROGRAMMING AND TESTING ACCORDING TO LOCAL FIRE DEPARTMENT REQUESTS. TEMPORARY SYSTEM SHALL REMAIN UNTIL NEW SYSTEM HAS BEEN APPROVED FOR OPERATION.

2. COORDINATE LOCATION OF FIRE ALARM APPLIANCES AND DEVICES IN AREAS WITH CEILING SYSTEM, DUCTWORK, FIXTURES, FURNITURE, AND OTHER EQUIPMENT PRIOR TO ALL WORK.

3. FINAL LOCATIONS AND ARRANGEMENTS OF FIRE ALARM DEVICES SHALL BE OBTAINED FROM THE ARCHITECTURAL REFLECTED CEILING PLAN AND ELEVATION VIEWS.

4. FOR EXACT LOCATIONS OF SMOKE/FIRE DAMPERS, DUCT-MOUNTED SMOKE DETECTORS, WATER FLOW SWITCHES AND VALVE TAMPER SWITCHES, REFER TO FIRE PROTECTION, PLUMBING AND MECHANICAL/HVAC DRAWINGS.

5. MOUNTING HEIGHTS SHALL BE TO CENTER OF DEVICE OR EQUIPMENT, UNLESS OTHERWISE NOTED.

6. PROVIDE RACEWAY, CONDUCTORS AND CABLE, ASSOCIATED FITTINGS AND CONNECTORS, AND COMPLETE CONNECTIONS REQUIRED FOR DESIGNATED FIRE ALARM BRANCH CIRCUITS FROM DEVICE(S) TO FIRE ALARM TERMINAL CABINET(S) OR FIRE ALARM CONTROL PANEL OR FIRE COMMAND CENTER PER FIRE ALARM PRODUCT MANUFACTURER

7. PROVIDE ADDITIONAL POWER SUPPLIES, AMPLIFICATION AND BATTERY BACKUP TO

8. PROVIDE TEMPORARY HEAT DETECTORS AS REQUIRED BY LOCAL FIRE DEPARTMENT.

9. PROVIDE NEW A/V DEVICES WITH INTEGRAL SYNCHRONIZATION CAPABILITIES AND/OR PROVIDE SYNCHRONIZATION MODULES FOR SYNCHRONIZATION OF ALL VISUAL DEVICES

10. THE SCOPE OF THIS PROJECT SHALL IN NO WAY IMPACT THE DAILY OPERATION OR THE SEQUENCE OF OPERATION OF THE EXISTING FIRE ALARM SYSTEM.

11. PROVIDE ALL PROGRAMMING/RE-PROGRAMMING PER REVISED SPACE DESIGNATIONS.

12. PROVIDE ALL PRETESTS AND FINAL TESTS PER TOWN OF STONEHAM FIRE DEPARTMENT.

13. PROVIDE FIRE ALARM INTERFACE TO BRING ALL DIMMED LUMINAIRES TO FULL BRIGHTNESS UPON ALARM.

14. PROVIDE FIRE ALARM INTERFACE TO SHUNT ALL A/V AND/OR SOUND EQUIPMENT.

15. PROVIDE FIRE ALARM INTERFACE TO RELEASE ALL SECURITY DEVICES.

10. A TAIL END SWITCH SHALL BE PROVIDED AT EACH IRRADIATION CONTROL VALVE SERVING THE COMBINATION STANDPIPE/SPRINKLER SYSTEM. FOR MORE INFORMATION REFER TO THE FIRE PROTECTION DRAWINGS.


17. A FLOW AND SUPERVISORY SWITCH SHALL BE PROVIDED FOR EACH CONTROL VALVE ASSEMBLY. FOR MORE INFORMATION REFER TO THE FIRE PROTECTION DRAWINGS.

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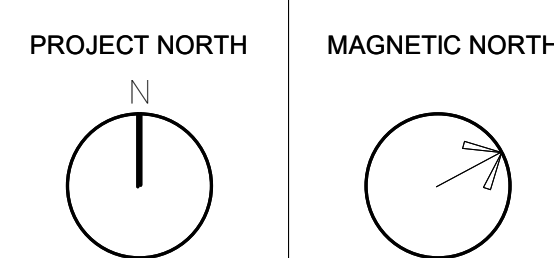
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August 4th, 2022



### KEY PLAN

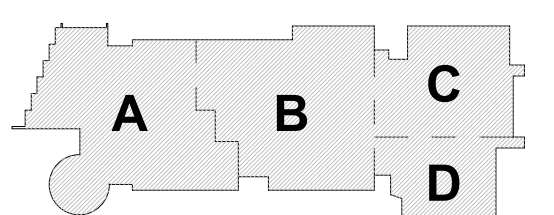

**FIRE ALARM  
ROOF PLAN -  
AREA D**

Scale: 1/8" = 1'-0"  
 Job No.: 20202  
 Drawn By: DRA  
 Date: August 4th, 2022

**FA1-2-11**

**FA1-2-1D**




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1. ALL DEVICES AND WIRING SHALL BE COMPATIBLE WITH FACP AND SHALL BE U.L. AND FM CERTIFIED AS A COMPLETE AND OPERABLE SYSTEM. THE FIRE ALARM SYSTEM SHALL BE INSTALLED AND OPERATIONAL IN ACCORDANCE WITH NEC ARTICLES 725, ARTICLE 760, NFPA 72 AND AIA. WIRING SHALL BE CLASS "A" TYPE.
2. WIRING BETWEEN THE FIRE ALARM CONTROL PANEL AND THE FIRE ALARM TERMINAL CABINETS AND THE WIRING BETWEEN TWO FIRE ALARM TERMINAL CABINETS SHALL HAVE A LEVEL 2 SURVIVABILITY.
3. THIS DIAGRAM DOES NOT DUPLICATE INFORMATION ABOUT PHYSICAL LOCATION OF EQUIPMENT WHICH IS ALREADY SHOWN ON THE PLANS. THIS DIAGRAM SHOWS SOME PIECES OF EQUIPMENT NECESSARY FOR THE OPERATION OF THE FIRE ALARM SYSTEM WHICH ARE TYPICALLY QUOTED FROM THE PLANS FOR THE SAKE OF CLARITY.
4. TYPICALLY IONIZATION TYPE SMOKE DETECTORS SHALL BE PROVIDED AND WIRED FOR AHS AND RETURN BACK TO FACP PER NFPA 98A. COORDINATE WITH MECHANICAL CONTRACTOR ON DETECTOR INSTALLATION AND SHUTDOWN WIRING. USE PHOTOELECTRIC TYPE DETECTORS FOR MECHANICAL ROOM, ELECTRICAL ROOM, IDF ROOM, MDR, ROOM, TELAROMA ROOM.
5. PROVIDE CONTROL MODULES FOR HVAC CONTROL (AHU) AND RTU SHUTDOWN. RELAYS WIRED TO SIL PER NFPA 98A. COORDINATE WITH MECHANICAL CONTRACTOR ON LOCATIONS OF DUCT DETECTORS, ETC. DUCT DETECTORS SHALL BE SYSTEM TYPE COMPATIBLE WITH FACP AND FURNISHED AND WIRED BY EC.
6. FIRE ALARM SYSTEM SHALL COMMUNICATE VIA COMMON GENERIC PROTOCOL, WITH THE MECHANICAL BAS SYSTEM, AND DATA CENTER GIS SYSTEM AS REQUIRED FOR SUPERVISORY, TROUBLE AND ALARM CONDITIONS. FIRE ALARM SYSTEM AND GAS SYSTEM SHALL BE MONITORED AT THE BUILDING ENGINEERS' OFFICE. PROVIDE REQUIRED HARDWARE, SOFTWARE AND WIRING.
7. PROVIDE, INSTALL AND WIRE SMOKE DAMPERS TO THE FIRE ALARM SYSTEM AS APPLICABLE. COORDINATE WITH MECHANICAL CONTRACTOR.
8. DESIGN INTENT IS TO INSTALL A NEW NOTIFICATION APPLIANCES AND INITIATING DEVICES TO THE NEW NOTIFICATION APPLIANCE CIRCUIT (NAC) AND SIGNALING DEVICES CROUT RESPECTIVELY SERVING THE RENOVATION AREA.
9. CONTRACTOR TO PERFORM VOLTAGE DROP AND BATTERY CALCULATIONS TO DETERMINE IF THE BATTERY NEEDS TO BE UPSEZD OR IF A BATTERY BACKUP BANKS UNIT IS NEEDED.
10. COORDINATE WITH ELEVATOR CONTRACTOR ON FIRE ALARM INTERFACE WIRING FOR SHUNT TRIP OF ELEVATOR MAIN DISCONNECT, ELEVATOR CAB PHONE JACKS, ELEVATOR PIT AND TOP OF SHAFT HEAD AND SMOKE DETECTORS, ETC. AS PER LOCAL ELEVATOR CODES. PROVIDE REQUIRED FIRE ALARM SYSTEM HARDWARE.
11. ISOLATION MODULES SHALL BE INSTALLED EACH 250 APPROXIMATE FEET DEVICES.
12. PROVIDE MONITOR MODULES AND WIRING FOR SPRINKLER WATER FLOW SWITCHES, PRESSURE SWITCHES AND TAMPER SWITCHES FOR MAIN VALVES, PRESSURE, FLOW AND TAMPER SWITCHES TO BE PROVIDED AND INSTALLED BY THE FIRE PROTECTION MECHANICAL CONTRACTOR.
13. FIRE ALARM SYSTEM DESIGN AND INSTALLATION SHALL MEET THE REQUIREMENTS OF ALL LOCAL CODES AND ORDINANCES AND OF THE LOCAL STONEHAM SAFETY DEPARTMENT.
14. FIRE ALARM CONTROL PANEL SHALL BE DUAL LISTED FOR BEST NOTIFICATION.
15. SEE DIVISION 28 SPECIFICATION FOR ADDITIONAL DETAILS OF FIRE ALARM SYSTEM.
16. FIRE ALARM SYSTEM SHALL COMMUNICATE VIA COMMON GENERIC PROTOCOL, WITH THE MECHANICAL BAS SYSTEM AS REQUIRED. IN ADDITION, FIRE ALARM SYSTEM SHALL COMMUNICATE ON A CAMPUS WIDE BASIS TO THE MAIN FIRE ALARM CONTROL PANEL.
17. FIRE ALARM SYSTEM SHALL BE ARRANGED FOR ZONED EVACUATION. THERE WILL BE ONE ZONE FOR THE STADIUM BUILDING AND ONE ZONE FOR THE HIGH SCHOOL BUILDING. THESE INITIATING DEVICES ARE ACTUATING THE ZONE FOR THE HIGH SCHOOL BUILDING. WHILE ONLY OCCUPANTS WITHIN THE HIGH SCHOOL BUILDING AND VICE VERSA. THE CORRESPONDING FIRE ALARM SIGNALS WILL BE TWO SIGNALS. IT IS FROM THE STADIUM BUILDING AND THE HIGH SCHOOL BUILDING.



**FIRE ALARM HIGH SCHOOL BUILDING RISER DIAGRAM**

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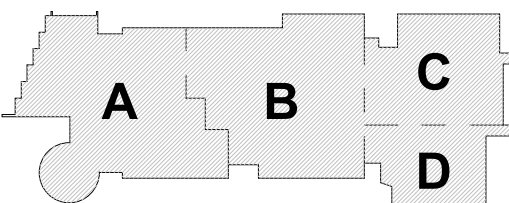
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August 4th, 2022

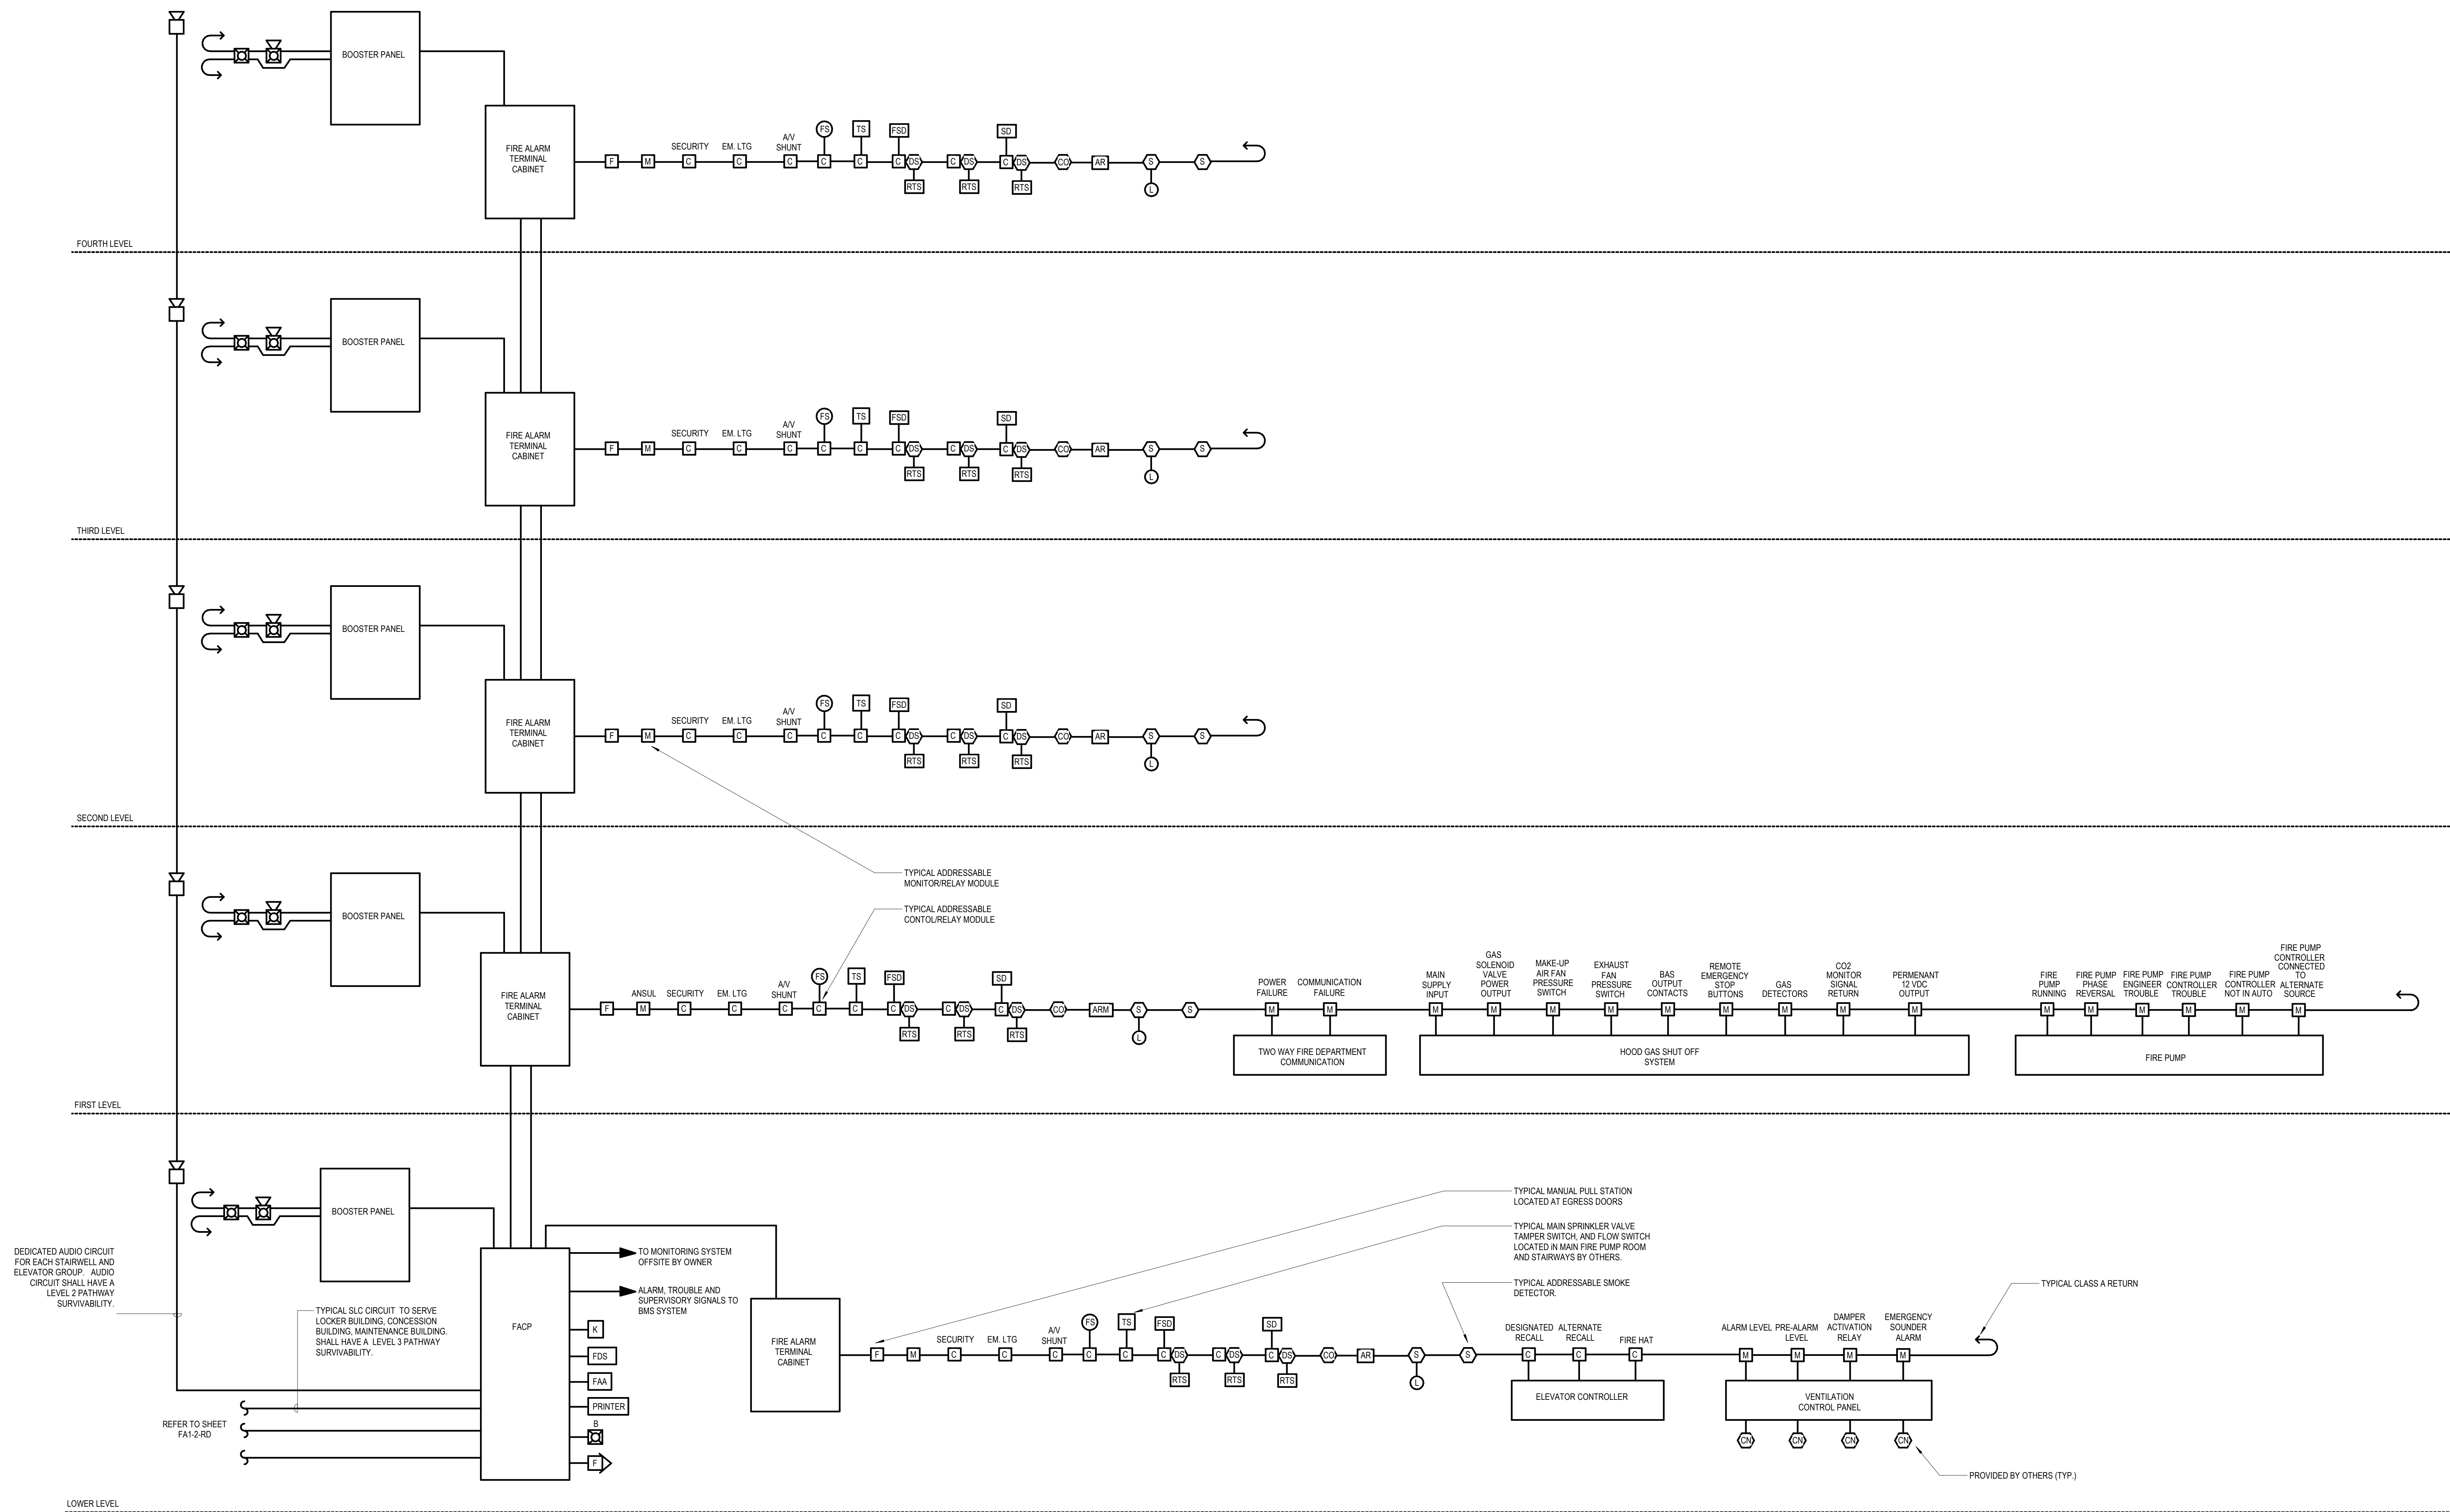

### KEY PLAN

PROJECT NORTH	MAGNETIC NORTH
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# FIRE ALARM HIGH SCHOOL BUILDING RISER DIAGRAM

Scale: 12" = 1'-0"


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Drawn By: DE


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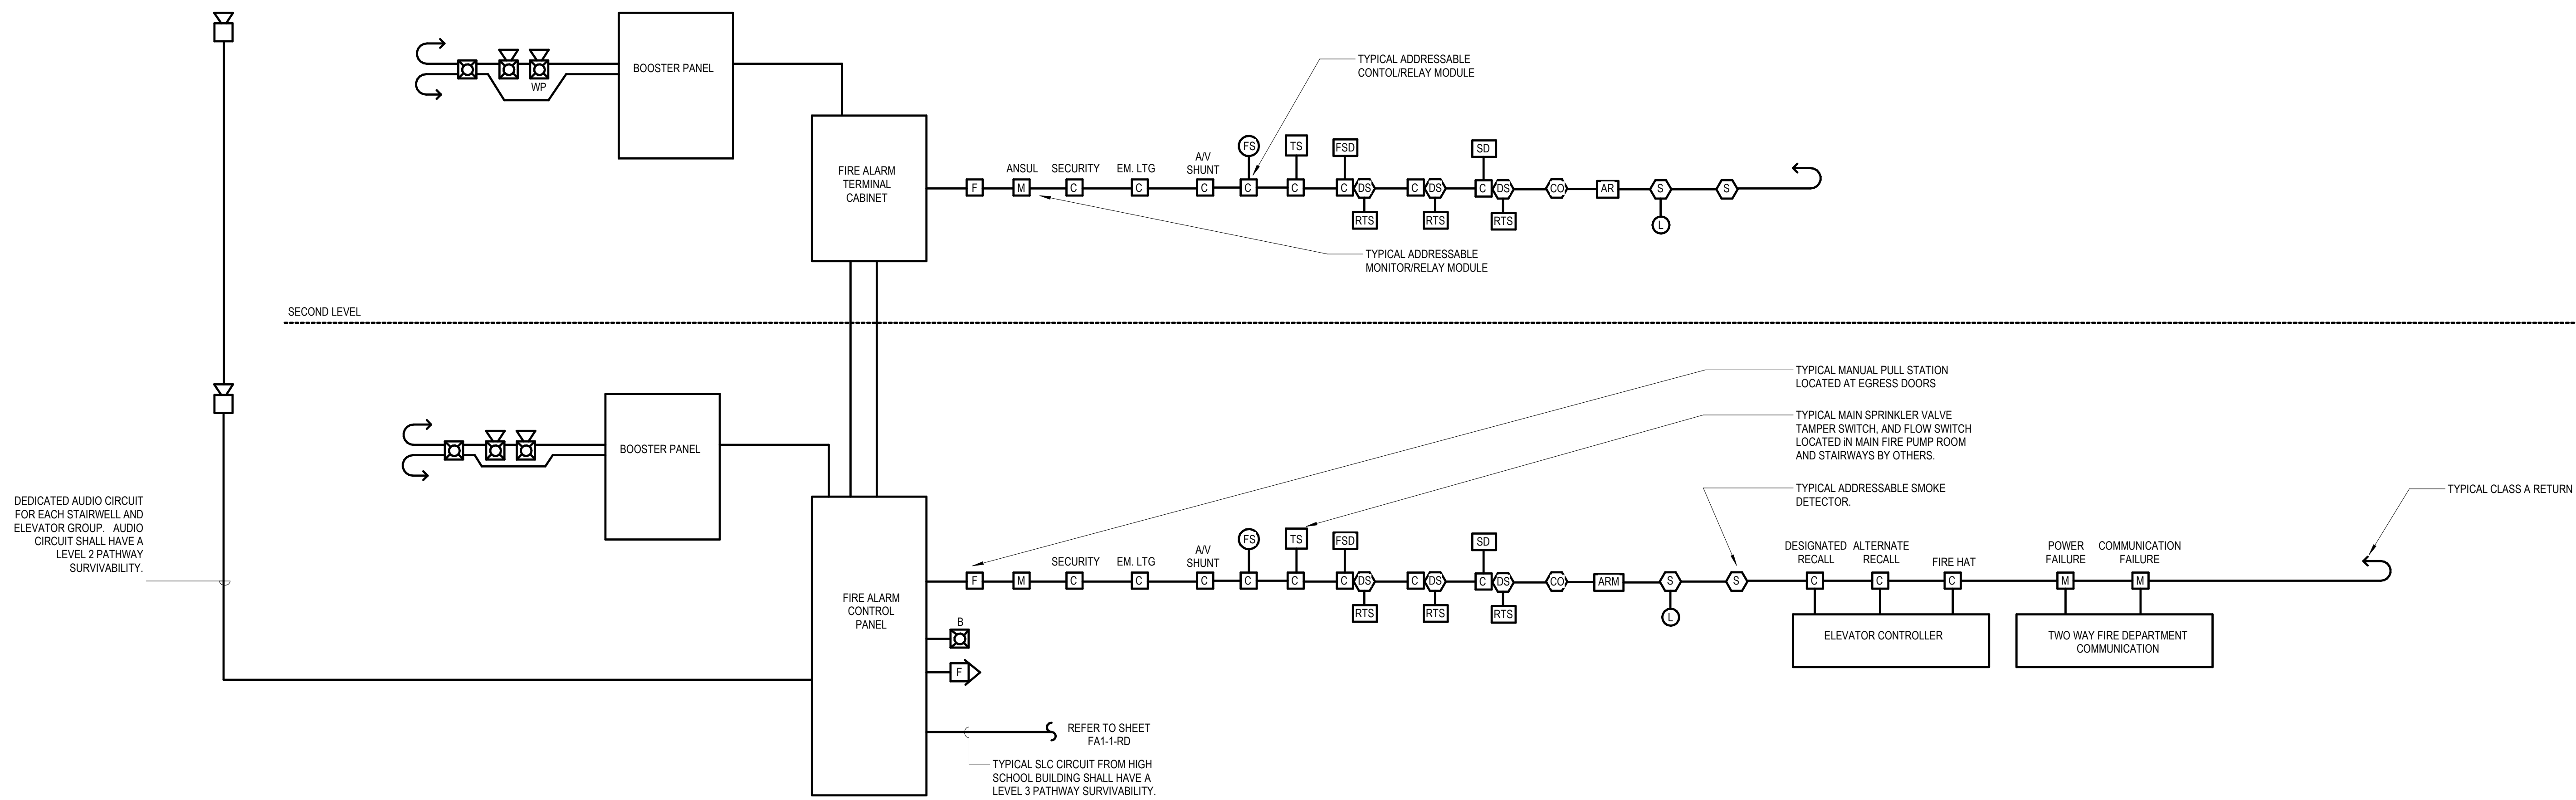
- NOTES:
- ALL DEVICES AND WIRING SHALL BE COMPATIBLE WITH FACP AND SHALL BE U.L. AND FM CERTIFIED AS A COMPLETE AND OPERABLE SYSTEM. THE FIRE ALARM SYSTEM SHALL BE INSTALLED AND OPERATIONAL IN ACCORDANCE WITH NEC ARTICLE 725, ARTICLE 760, NFPA 72 AND ADA. WIRING SHALL BE CLASS 'A' TYPE.
  - THIS DIAGRAM DOES NOT DUPLICATE INFORMATION ABOUT PHYSICAL LOCATION OF EQUIPMENT, WHICH IS ALREADY SHOWN ON THE PLANS. THIS DIAGRAM SHOWS SOME PIECES OF EQUIPMENT NECESSARY FOR THE OPERATION OF THE FIRE ALARM SYSTEM, BUT WHICH ARE TYPICALLY OMITTED FROM THE PLANS FOR THE SAKE OF CLARITY.
  - TYPICALLY IONIZATION TYPE SMOKE DETECTORS SHALL BE PROVIDED AND WIRED TO FACP PER NFPA 99A. COORDINATE WITH MECH. CONTRACTOR ON DETECTOR INSTALLATION AND SHUTDOWN WIRING. USE PHOTOELECTRIC TYPE DETECTORS FOR MECHANICAL ROOM, ELECTRICAL ROOM, SF ROOM, MDF ROOM, TEL/DATA ROOM.
  - PROVIDE CONTROL MODULES FOR HVAC CONTROL (AHU AND RTU SHUTDOWN) VIA DUCT SMOKE DETECTORS WITH RELAYS WIRED TO SLC PER NFPA 99A. COORDINATE WITH MECHANICAL CONTRACTOR ON LOCATIONS OF DUCT DETECTORS, ETC. DUCT DETECTORS SHALL BE SYSTEM TYPE COMPATIBLE WITH FACP AND FURNISHED AND WIRED BY EC.
  - FIRE ALARM SYSTEM SHALL COMMUNICATE VIA COMMON GENERIC PROTOCOL WITH THE MECHANICAL BAS SYSTEM, AND DATA CENTER CMMS SYSTEM AS REQUIRED FOR SUPERVISORY, TROUBLE AND ALARM CONDITIONS. FIRE ALARM SYSTEM AND BAS SYSTEM SHALL BE MONITORED IN THE BUILDING ENGINEER'S OFFICE. PROVIDE REQUIRED HARDWARE, SOFTWARE AND WIRING.
  - PROVIDE, INSTALL AND WIRE SMOKE DAMPERS TO THE FIRE ALARM SYSTEM AS APPLICABLE. COORDINATE WITH MECHANICAL CONTRACTOR.
  - DESIGN INTENT IS TO INSTALL A NEW NOTIFICATION APPLIANCES AND INITIATING DEVICES TO THE NEW NOTIFICATION APPLIANCE CIRCUIT (NAC) AND SIGNALING DEVICES CIRCUIT RESPECTIVELY SERVING THE RENOVATION AREA.
  - CONTRACTOR TO PERFORM VOLTAGE DROP AND BATTERY CALCULATIONS TO DETERMINE IF THE BATTERY NEEDS TO BE UPSIZED OR IF ANOTHER NAC BOOSTER PANEL IS NEEDED.
  - COORDINATE WITH ELEVATOR CONTRACTOR ON FIRE ALARM INTERFACE WIRING FOR SHUNT TRIP OF ELEVATOR MAIN DISCONNECT, ELEVATOR CAB PHONE JACKS, ELEVATOR PIT AND TOP OF SHAFT HEAT AND SMOKE DETECTORS, ETC. AS PER LOCAL ELEVATOR CODES. PROVIDE REQUIRED FIRE ALARM SYSTEM HARDWARE.
  - ISOLATION MODULES SHALL BE INSTALLED EACH 25 ADDRESSABLE DEVICES.
  - PROVIDE MONITOR MODULES AND WIRING FOR SPRINKLER WATER FLOW SWITCHES, PRESSURE SWITCHES AND TAMPER SWITCHES FOR MAIN VALVES. PRESSURE, FLOW AND TAMPER SWITCHES TO BE PROVIDED AND INSTALLED BY THE FIRE PROTECTION MECHANICAL CONTRACTOR.
  - FIRE ALARM SYSTEM DESIGN AND INSTALLATION SHALL MEET THE REQUIREMENTS OF ALL LOCAL CODES AND ORDINANCES AND OF THE LOCAL STONEHAM SAFETY DEPARTMENT.
  - FIRE ALARM CONTROL PANEL SHALL BE DUAL LISTED FOR MASS NOTIFICATION.
  - SEE DIVISION 28 SPECIFICATION FOR ADDITIONAL DETAILS OF FIRE ALARM SYSTEM.
  - FIRE ALARM SYSTEM SHALL COMMUNICATE VIA COMMON GENERIC PROTOCOL WITH THE MECHANICAL BAS SYSTEM, AS REQUIRED. IN ADDITION, FIRE ALARM SYSTEM SHALL COMMUNICATE ON A CAMPUS-WIDE BASIS TO THE MAIN FIRE ALARM CONTROL PANEL.
  - FIRE ALARM SYSTEM SHALL BE ARRANGED FOR ZONED EVACUATION. THERE WILL BE ONE ZONE FOR THE STADIUM BUILDING AND ONE ZONE FOR THE HIGH SCHOOL BUILDING. THUS, INITIATING DEVICES THAT ARE ACTUATED WITHIN THE HIGH SCHOOL BUILDING WILL ONLY NOTIFY OCCUPANTS WITHIN THE HIGH SCHOOL BUILDING AND VICE VERSA. THE CORRESPONDING FIRE ALARM SIGNALS WILL DISTINGUISH IF IT IS FROM THE STADIUM BUILDING OR FROM THE HIGH SCHOOL BUILDING.



3  
FA4-1  
FIRE ALARM CONNESSION BUILDING RISER DIAGRAM  
12" = 1'-0"

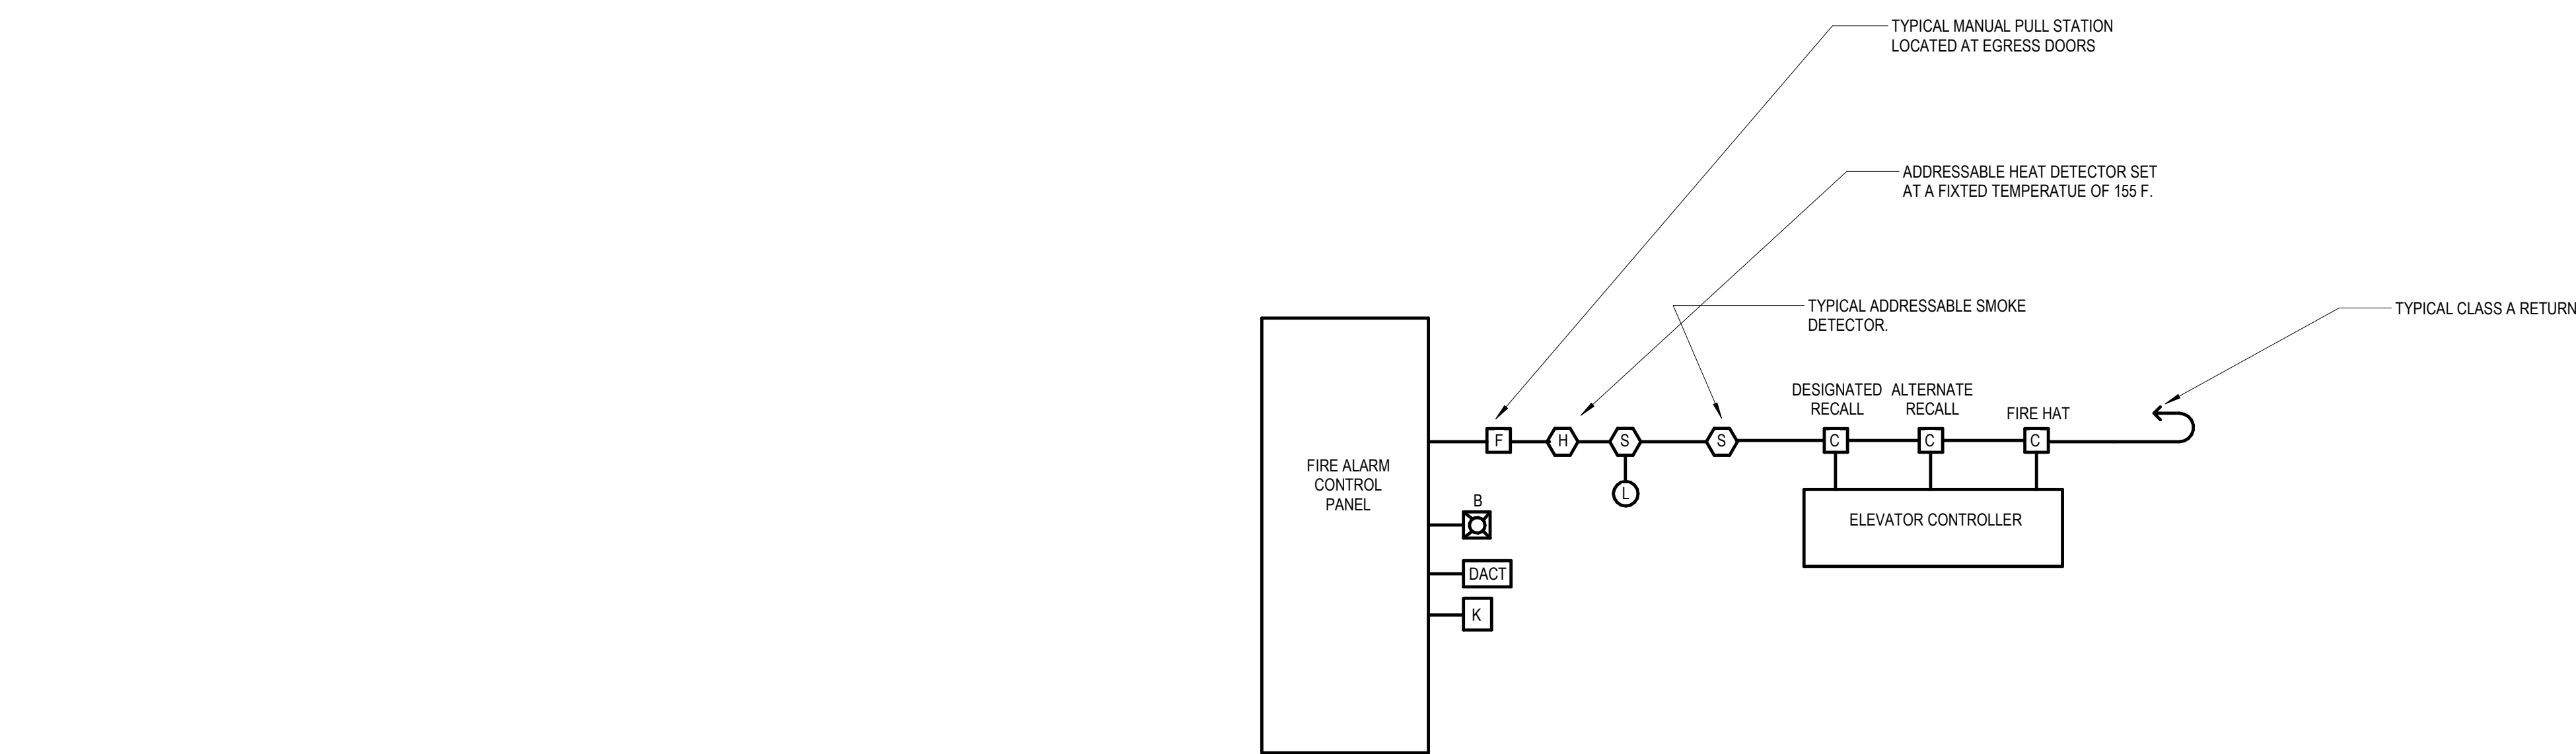

2  
FA4-1  
FIRE ALARM MAINTENANCE BUILDING RISER DIAGRAM  
12" = 1'-0"

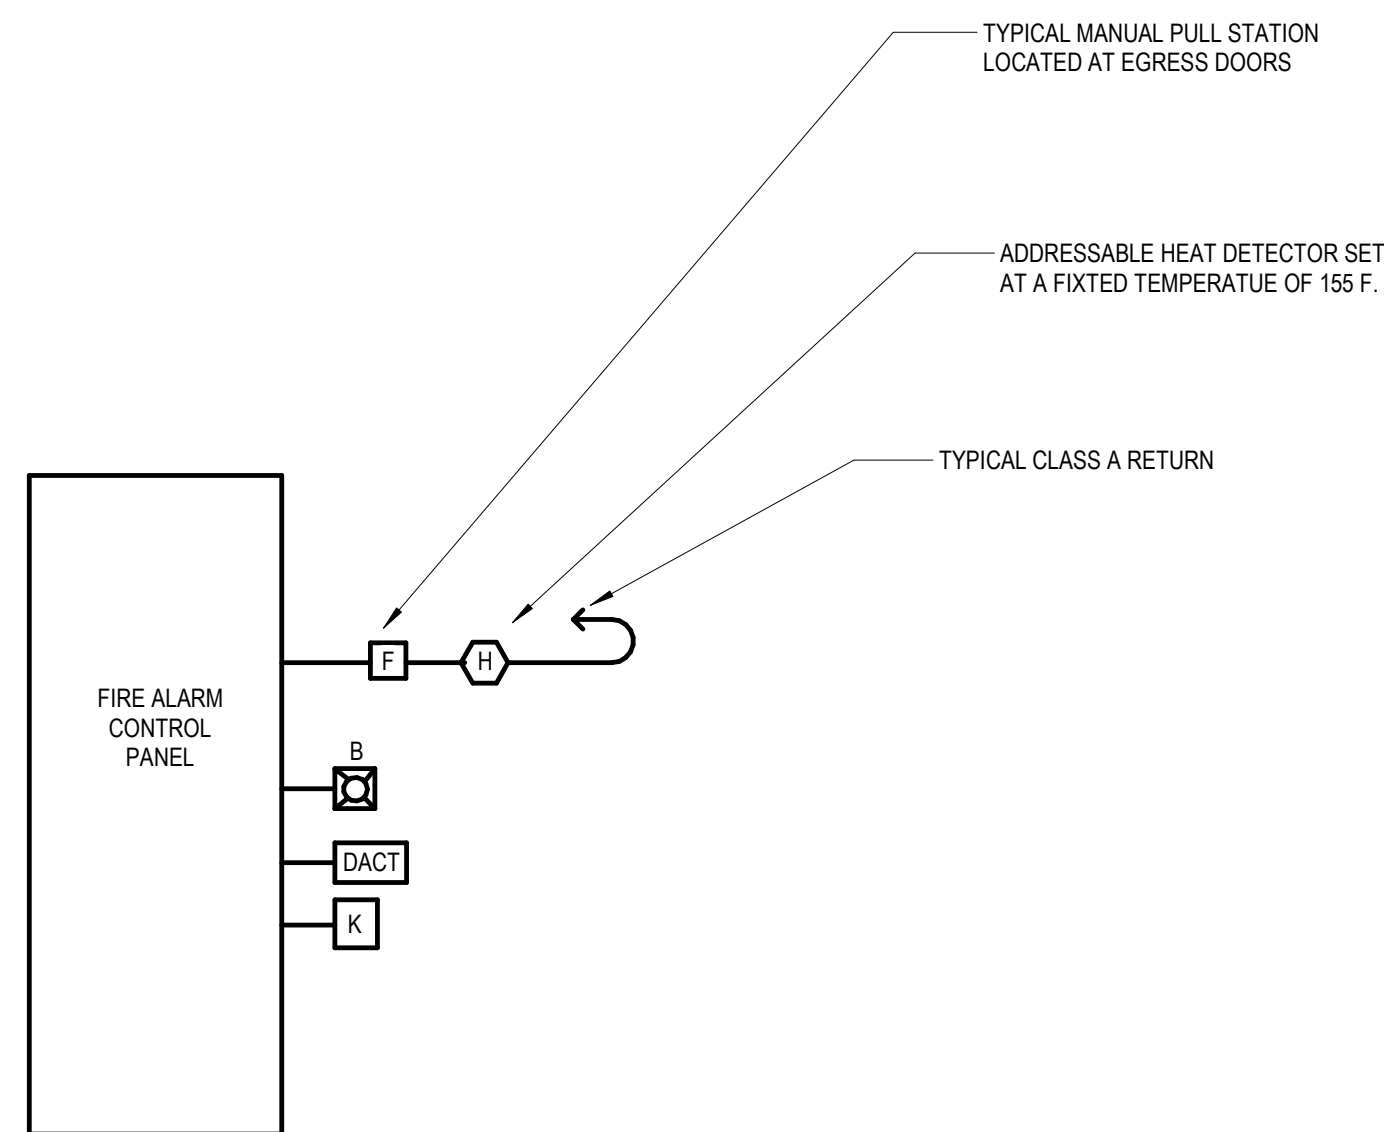

1  
FA4-1  
FIRE ALARM LOCKER BUILDING RISER DIAGRAM  
12" = 1'-0"

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