
ABBREVIATIONS		FIRE PROTECTION LEGEND	GENERAL NOTES	FIRE PROTECTION GENERAL NOTES					
(E) EXISTING ITEM (ED) EXISTING ITEM TO BE DEMOLISHED (ER) EXISTING ITEM TO BE RELOCATED	← FP ← → ← (E) FP ← → ← DR − →	FIRE MAIN EXISTING FIRE MAIN DRAIN PIPING	1. THE WORK TO BE DONE UNDER THESE SPECIFICATIONS AND THE DRAWINGS CONSISTS OF PROVIDING ALL EQUIPMENT, MATERIALS, LABOR AND SERVICES AND PERFORMING ALL OPERATIONS TO COMPLETE THE CONSTRUCTION WORK FOR THIS PROJECT. ANY WORK NOT SPECIFICALLY COVERED BY THESE SPECIFICATIONS OR INDICATED ON THE CONTRACT DRAWINGS, BUT NECESSARY TO COMPLETE OR PERFECT ANY PART OF THIS INSTALLATION IN A SUBSTANTIAL MANNER, SHALL BE PROVIDED WITHOUT EXTRA COST TO THE OWNER.	THE CONTRACT DRAWINGS ARE PERFORMANCE IN NATURE AND REQUIRE DELEGATED FIRE PROTECTION DESIGN SERVICE AS REQUIRED BY NFPA. ALL PIPING, SPECIALTIES AND ACCESSORIES NOT SHOWN SHALL BE PROVIDED AS REQUIRED FOR A COMPLETE AND FUNCTIONAL FIRE PROTECTION SYSTEM. CONTRACTOR SHALL SUBMIT SPRINKLER SYSTEM DRAWINGS IDENTIFIED AS "WORKING DRAWINGS" AND PREPARED IN CONFORMANCE WITH NFPA CODES. SUBMIT ENGINEERED HYDRAULIC CALCULATIONS AND PIPING DIAGRAMS, INCLUDING FLOW TEST DATA, IN CONFORMANCE WITH NFPA STANDARDS, INSURANCE UNDERWRITER AND THE LOCAL AUTHORITY HAVING					
(N) NEW ITEM (RL) EXISTING ITEM TO BE RELOCATED A COMPRESSED AIR AC ABOVE CEILING AFF ABOVE FINISHED FLOOR	⟨— (E) DR — ⟨ SP — ⟨ (E) SP — ⟨ PA — ⟩	EXISTING DRAIN PIPING SPRINKLER PIPING EXISTING SPRINKLER PIPING PREACTION SPRINKLER PIPING	2. THE WORK SHALL CONFORM TO THE MORE STRINGENT OF ALL APPLICABLE CODES & REGULATIONS, UL GUIDELINES, LEED REQUIREMENTS, MANUFACTURER'S LITERATURE AND RECOMMENDATIONS, AND TO THE REQUIREMENTS OF FEDERAL, STATE AND LOCAL REGULATORY AGENCIES AND AUTHORITIES HAVING JURISDICTION.	JURISDICTION. WORKING DRAWINGS AND CALCULATIONS SHALL HAVE STAMPED APPROVALS FROM THE FIRE PROTECTION CONTRACTOR'S PROFESSIONAL ENGINEER OR NICET CERTIFIED DESIGNER, THE INSURANCE UNDERWRITER AND THE LOCAL AUTHORITY HAVING JURISDICTION PRIOR TO SUBMISSION TO THE ARCHITECT OR ENGINEER.					
AFG ABOVE FINISHED GRADE AP ABOVE PIPE BF BELOW RAISED FLOOR BFP BACKFLOW PREVENTER BLDG BUILDING	(E) PA	EXISTING PREACTION SPRINKLER PIPING DRY SPRINKLER PIPING EXISTING DRY SPRINKLER PIPING	3. THE DRAWINGS ARE DIAGRAMMATIC IN NATURE AND INDICATE THE EXTENT, GENERAL CHARACTER, LOCATION AND ARRANGEMENT OF THE WORK UNDER THIS CONTRACT. WHERE JOB CONDITIONS REQUIRE MINOR CHANGES OR ADJUSTMENTS IN THE INDICATED LOCATIONS OR ARRANGEMENT OF THE WORK, SUCH CHANGES SHALL BE PROVIDED WITHOUT EXTRA COST. THE CONTRACTOR SHALL RE-INSTALL EQUIPMENT THAT HAS INADEQUATE OR UNSAFE ACCESSIBILITY.	2. SEE ALL DRAWINGS AND SPECIFICATIONS FOR STANDPIPE AND SPRINKLER SYSTEM HYDRAULIC DESIGN CRITERIA. HYDRAULIC CALCULATION NODE POINTS FOR THE MOST DEMANDING SPRINKLER PROTECTION AREA(S) AND FIRE DEPARTMENT HOSE VALVE CONNECTION(S) ARE INDICATED ON THE PLANS FOR SYSTEM DESIGN INFORMATION ONLY. THE FIRE PROTECTION CONTRACTOR SHALL PROVIDE HYDRAULIC CALCULATIONS FOR EACH TYPE OF OCCUPANCY FOR EACH SPRINKLER ZONE AND SHALL PROVIDE HYDRAULIC CALCULATIONS FOR THE MOST					
BOP BOTTTOM OF PIPE CA CLEAN AGENT CB&V CURB BOX & VALVE CIP CAST IRON PIPE	CA	CLEAN AGENT SYSTEM PIPING EXISTING CLEAN AGENT SYSTEM PIPING DRY STAND PIPE	4. INSTALLATION OF WORK SHALL PROVIDE REASONABLE ACCESSIBILITY FOR OPERATION, INSPECTION AND MAINTENANCE OF EQUIPMENT AND ACCESSORIES. PROVIDE CLEARANCES REQUIRED BY MANUFACTURERS AND APPLICABLE CODES. ALL CEILING MOUNTED EQUIPMENT SHALL BE INSTALLED IN SUCH A MANNER THAT LIGHTS, PIPING, AND DUCTWORK DO NOT BLOCK ACCESS TO EQUIPMENT AND RELATED ACCESSORIES.	REMOTE OR HYDRAULICALLY DEMANDING FIRE DEPARTMENT HOSE CONNECTION BASED ON THE MAXIMUM SYSTEM DEMAND AS REQUIRED PER APPLICABLE NFPA STANDARDS. WORKING DRAWINGS AND HYDRAULIC CALCULATIONS SHALL BE SUBMITTED AND APPROVED BY ALL PARTIES OUTLINED HEREIN PRIOR TO PROCUREMENT OF FIRE PROTECTION EQUIPMENT, FABRICATION AND INSTALLATION OF ANY FIRE PROTECTION SYSTEM.					
CLG CEILING CONN CONNECT CONT CONTINUATION D DETECTION DEVICE (SHOWN IN SYMBOL) DIP DUCTILE IRON PIPE	(E) DSP — ((E) D	EXISTING DRY STAND PIPE CHECK VALVE BUTTERFLY VALVE BALL VALVE	5. THE TERM "FURNISH" SHALL MEAN TO OBTAIN AND SUPPLY TO THE JOB SITE. THE TERM "INSTALL" SHALL MEAN TO FIX IN POSITION AND CONNECT FOR USE. THE TERM "PROVIDE" SHALL MEAN TO FURNISH AND INSTALL. THE TERM "MECHANICAL WORK", "ELECTRICAL WORK", "PLUMBING WORK", ETC. SHALL MEAN ALL LABOR, MATERIAL, EQUIPMENT, SCAFFOLDING, RIGGING, TOOLS, SUPERVISION, SERVICES AND OTHER INCIDENTALS NECESSARY FOR COMPLETE AND OPERABLE INSTALLATION.	 CONTRACTOR SHALL PROVIDE FIRE WATER SERVICE RESTRAINTS AND THRUST BLOCKS AS REQUIRED. STANDPIPE SYSTEMS SHALL BE DESIGNED AND INSTALLED IN STRICT ACCORDANCE WITH NFPA-14, ALL APPLICABLE CODES AND THE AUTHORITY HAVING JURISDICTION. FIRE DEPARTMENT HOSE CONNECTION PATTERNS SHALL MEET THE REQUIREMENTS OF THE LOCAL FIRE MARSHALL AND THE AUTHORITY HAVING JURISDICTION. 					
DN DOWN DP DRY PIPE DR DRAIN RISER DSP DRY STANDPIPE DWG DRAWING	}	GATE VALVE - OUTSIDE SCREW & YOKE ANGLE VALVE PIPE CAP - FLANGED, SCREWED OR GROOVED TYPE	6. THE CM/GC SHALL MAKE SETS OF THE BID DOCUMENTS CONSISTING OF COMPLETE SETS OF DRAWINGS AND SPECIFICATIONS; AND ISSUE THEM TO EACH OF THE PRIME AND SUB-CONTRACTORS. EVERY PRIME AND SUB-CONTRACTOR ON EACH BIDDING TEAM SHALL RECEIVE COMPLETE SETS OF DRAWINGS AND SPECIFICATIONS. THERE ARE NOTES AND CROSS REFERENCES FOR VARIOUS TRADE CONTRACTORS IN MULTIPLE TRADE OR DISCIPLINE DRAWINGS AND SPECIFICATIONS, THUS, EACH CONTRACTOR IS TO RECEIVE COMPLETE	5. ALL DEDICATED WATER SUPPLY WORK ON SITE, INSIDE OF THE PROPERTY LINE, INCLUDING CONNECTION TO THE UTILITY IF APPLICABLE, SERVING THE FIRE PROTECTION SYSTEM (PIPE, FITTINGS, HYDRANTS, ETC.) SHALL BE INSTALLED UNDER THIS CONTRACT.					
EA EACH EC ELECTRICAL CONTRACTOR EL ELEVATION		FLANGED PIPE CONNECTION GROOVED PIPE MECHANICAL CONNECTION UNION	SETS OF THE BID DOCUMENTS. IT IS THE CONTRACTOR'S RESPONSIBILITY TO OBTAIN THESE DRAWINGS FROM CM/GC. EACH CONTRACTOR IS RESPONSIBLE FOR THEIR WORK, AS NOTED ON THE OTHER DISCIPLINE DOCUMENTS. BIDDERS ARE RESPONSIBLE FOR ALL COSTS FOR EACH SET OF BID DOCUMENTS REQUESTED.	6. ALL EXPOSED PIPING AND PIPING ABOVE THE CEILINGS SHALL BE INSTALLED AS CLOSE AS PRACTICAL TO THE UNDERSIDE OF STRUCTURAL MEMBERS OR TO WITHIN ONE FOOT OF THE FLOOR / ROOF DECK ABOVE WHEREVER POSSIBLE.					
EQUIP EQUIPMENT FCV FLOOR CONTROL VALVE FD FLOOR DRAIN FDC FIRE DEPARTMENT CONNECTION	\\\\\\\\\\\\\\\\\\\\\\\\\\\\\\\\\\\\\	FIRE DEPARTMENT CONNECTION ("Y" PROJECTING) FIRE DEPARTMENT CONNECTION (FLUSH) FIRE DEPARTMENT CONNECTION (SIDEWALK)	7. CONTRACTOR IS RESPONSIBLE FOR PROVIDING A FULL COORDINATION EFFORT IN ORDER TO CREATE A FINALIZED COORDINATED LAYOUT OF ALL EQUIPMENT, SYSTEMS, DUCTWORK, PIPING AND ALL OTHER ITEMS WITHIN THEIR RESPECTIVE SCOPE. THE CONTRACTOR'S COORDINATION EFFORT SHALL INCLUDE COORDINATED INFORMATION FROM ALL OTHER TRADE CONTRACTOR'S INVOLVED IN THE PROJECT SCOPE IN ORDER TO PROVIDE COORDINATION BETWEEN TRADES AND ALL EXISTING CONDITIONS. ALL ERRORS MADE AS A RESULT OF A LACK OF	 PROVIDE 2" DRAIN FROM EACH SPRINKLER ZONE CONTROL VALVE ASSEMBLY AND EXTEND TO 2" OR 3" DRAIN RISER, AS APPLICABLE, DISCHARGING TO EXTERIOR GRADE, AN APPROVED DRAINAGE SPECIALTY SIZED TO ACCOMMODATE THE ANTICIPATED DEMAND OR AS SHOWN ON THE DRAWINGS. FINAL LOCATION OF EXTERIOR FIRE DEPARTMENT CONNECTIONS SHALL BE APPROVED BY THE LOCAL FIRE 					
FH FIRE HYDRANT FHC FIRE HOSE CABINET FHR FIRE HOSE RACK FHV FIRE HOSE VALVE FPC FIRE PROTECTION CONTRACTOR	T⊕T 	FIRE DEPARTMENT CONNECTION (SIDEWALK) FIRE HYDRANT WATER MOTOR GONG (OR ELECTRIC BELL)	COORDINATION SHALL BE THE RESPONSIBILITY OF THE CONTRACTOR AND CORRECTED AT NO ADDITIONAL COST TO THE PROJECT. MINOR RELOCATIONS AND SHIFTS OF EQUIPMENT, DUCTWORK, AND PIPING WHICH DO NOT CHANGE THE DESIGN INTENT INDICATED ON THE CONTRACT DOCUMENTS, REQUIRED TO ACCOMMODATE FIELD CONDITIONS ARE AT THE CONTRACTORS DISCRETION AND DO NOT REQUIRE ENGINEER APPROVAL.	MARSHALL PRIOR TO INSTALLATION. 9. PROVIDE ALL NEW SPRINKLER SYSTEM COMPONENTS, REFURBISHING, TESTING, CERTIFICATION, AND ANY OTHER WORK REQUIRED TO ENSURE A COMPLETELY APPROVED AND OPERATIONAL SYSTEM. CONTRACTOR SHALL EXTEND FROM EXISTING PIPING OF ADEQUATE SIZE OR MAKE NEW PIPING CUT-INS AS REQUIRED TO SUIT NEW					
FPTH FIRE PUMP TEST HEADER FS FLOW SWITCH FT FOOT ,FEET GC GENERAL CONTRACTOR	PIV FS PS TS	POST INDICATOR VALVE FLOW SWITCH PRESSURE SWITCH	8. CONTRACTOR SHALL ARRANGE AND OBTAIN ALL PERMITS, INSPECTIONS AND APPROVALS, AND PAY ALL RELATED FEES. 9. THE DRAWINGS INDICATE APPROXIMATE LOCATIONS BASED UPON INFORMATION OBTAINED WITHOUT REMOVING CEILING TILES OR WALLS. THEREFORE, THE CONTRACTOR SHALL INCLUDE IN THEIR BID CONTINGENCY COSTS TO	SPRINKLER LOCATIONS. 10. FIELD COORDINATE ALL FIRE PROTECTION PIPING AND EQUIPMENT LOCATIONS AND/OR MODIFICATIONS WITH THE GENERAL, ELECTRICAL, AND MECHANICAL CONTRACTORS PRIOR TO COMMENCEMENT OF WORK TO ELIMINATE FIELD CONTRACTORS. FINAL SPRINKLER LOCATIONS SHALL BE COORDINATED WITH LIGHTS, FIXTURES, DUCTWORK,					
GP GALVANIZED PIPE GPD GALLONS PER DAY GPH GALLONS PER HOUR GPM GALLONS PER MINUTE	WIV III X	TAMPER SWITCH WALL INDICATOR VALVE WET PIPE SPRINKLER SYSTEM ALARM VALVE	ADDRESS CONFLICTS BETWEEN DESIGN AND EXISTING CONDITIONS. ANY CHANGES AND/OR MODIFICATIONS MUST BE REVIEWED AND APPROVED BY THE ENGINEER AND/OR OWNER'S REPRESENTATIVE PRIOR TO CONSTRUCTION. 10. FOR ANY DISCREPANCY BETWEEN DRAWINGS AND/OR SPECIFICATIONS, THE CONTRACTOR SHALL BASE THEIR BID UPON THE MOST STRINGENT REQUIREMENT (QUALITY, QUANTITY, SIZE, ETC.). THE CONTRACTOR SHALL IDENTIFY	DIFFUSERS, PIPING, EQUIPMENT, ETC. 11. THE FIRE PROTECTION CONTRACTOR SHALL CONFIRM LIGHTING TO BE INSTALLED FOR COORDINATION OF LOCATIONS, SIZE, AND MOUNTING HEIGHTS. THE CONTRACTOR SHALL COORDINATE FINAL SPRINKLER HEAD LOCATIONS PER NFPA 13 OBSTRUCTION REQUIREMENTS AND COORDINATE WITH THE ELECTRICAL CONTRACTOR TO ENSURE ALL AREAS ARE COVERED IN ACCORDANCE WITH NFPA STANDARDS.					
H HALON I. E. INVERT ELEVATION L.Z. LOW ZONE NC NORMALLY CLOSED NIC NOT IN CONTRACT		DRY PIPE SPRINKLER SYSTEM ALARM VALVE PREACTION SPRINKLER SYSTEM ALARM VALVE SMOKE DETECTOR HEAT OR THERMAL DETECTOR	DISCREPANCIES AS PART OF THEIR BID. 11. THE CONTRACTOR SHALL EFFECTIVELY PROTECT ALL MATERIALS AND EQUIPMENT FROM ENVIRONMENTAL AND PHYSICAL DAMAGE UNTIL FINAL ACCEPTANCE. CLOSE AND PROTECT ALL OPENINGS DURING CONSTRUCTION. PROVIDE NEW MATERIALS AND EQUIPMENT TO REPLACE ITEMS DAMAGED.	 COORDINATE ALL LOCATIONS AND MOUNTING HEIGHTS OF FIRE PROTECTION DEVICES AND APPURTENANCES WITH THE LOCAL AUTHORITY HAVING JURISDICTION, APPLICABLE ADA REQUIREMENTS AND ALL TRADE CONTRACTORS. 					
NO NORMALLY OPEN NTS NOT TO SCALE PA PRE ACTION PC PLUMBING CONTRACTOR		PREACTION SYSTEM PULL STATION HORN BELL/AMBER STROBE (INSIDE ROOM, PREACTION SYSTEM) BELL/AMBER STROBE ALARM (OUTSIDE ROOM, PREACTION SYSTEM)	12. WHERE BEAMS ARE INDICATED TO BE PENETRATED WITH DUCTWORK AND/OR PIPING, CAREFULLY COORDINATE SIZES AND LOCATIONS OF THE ELEMENTS BEFORE FABRICATION. COORDINATE WITH FINAL LOCATION OF BEAM PENETRATIONS AND SHEAR WALL PENETRATIONS.	 HYDRAULIC CALCULATIONS SHALL DICTATE THE ADEQUATE SIZES OF PIPING. CONTRACTOR SHALL BE RESPONSIBLE FOR PROVIDING PIPING OF A LARGER DIAMETER, IF NECESSARY, TO BRING THE SYSTEM TO FULL COMPLIANCE WITH THE HYDRAULIC CALCULATIONS. AS APPLICABLE, FIRE PROTECTION SPRINKLER AND OR STANDPIPE SYSTEM HYDRAULIC CALCULATIONS SHALL BE 					
PG PRESSURE GAUGE PIV POST INDICATOR VALVE PRESS PRESSURE PS PRESSURE SWITCH		HORN BELL/RED STROBE (INSIDE ROOM, PREACTION SYSTEM) BELL/RED STROBE ALARM (OUTSIDE ROOM, PREACTION SYSTEM)	 13. CONTRACTOR SHALL COORDINATE LOCATION OF ALL WALL, FLOOR AND ROOF OPENINGS WITH STRUCTURAL AND OTHER TRADES. 14. PROVIDE CUTTING AND PATCHING AS REQUIRED AND WHERE NECESSARY TO ACCOMMODATE NEW WORK AND THE 	SUBMITTED AND APPROVED BY THE OWNER'S UNDERWRITER, AUTHORITIES HAVING JURISDICTION AND THE ENGINEER PRIOR TO REVIEW AND APPROVAL OF A FIRE PUMP SHOP DRAWING SUBMISSION. 15. CONTRACTOR SHALL VERIFY CONCEALED SPACES ARE PROTECTED IN ACCORDANCE WITH N.F.P.A. 13 AND ANY					
PSI POUNDS PER SQUARE INCH PSIG POUNDS PER SQUARE INCH GAUGE SF SQUARE FOOT SP SPRINKLER PIPING		ION DETECTOR (CEILING MOUNTED) ION DETECTOR (ABOVE CEILING MOUNTED) ION DETECTOR (BELOW RAISED FLOOR)	REPAIR OF EXISTING WORK. 15. WHEN WORK INVOLVES CONTACT WITH MATERIALS CONTAINING ASBESTOS, PCB, OR OTHER TOXIC MATERIALS, NOTIFY OWNER, WHO WILL ESTABLISH PROCEDURES FOR REMEDIATION AND REMOVAL.	LOCAL CODE REQUIREMENTS. 16. ADDITIONAL SPRINKLER HEADS SHALL BE PROVIDED UNDER ALL DUCTS AND ALL OTHER OBSTRUCTIONS THAT ARE 4'-0" AND GREATER IN WIDTH IN ACCORDANCE WITH NFPA 13. COORDINATE FINAL SPRINKLER HEAD LOCATIONS AND REQUIREMENTS WITH THE MECHANICAL AND ARCHITECTURAL DRAWINGS.					
SPR SPRINKLER STDP STAND PIPE TB THRUST BLOCK TDH TOTAL DYNAMIC HEAD	*	PHOTOELECTRIC DETECTOR (CEILING MOUNTED) PHOTOELECTRIC DETECTOR (ABOVE CEILING MOUNTED) PHOTOELECTRIC DETECTOR (BELOW RAISED FLOOR)	 16. CONTRACTOR SHALL SCHEDULE THE WORK UNDER THIS CONTRACT WITH WORK OF OTHER TRADES AS NOT TO DELAY THE OVERALL PROGRESS OF THE PROJECT. 17. CONTRACTOR SHALL NOTIFY ARCHITECT/ENGINEER OF ANY CONFLICTS PRIOR TO PURCHASING EQUIPMENT AND PRIOR TO CUTTING OPENINGS. 	 17. ADDITIONAL SPRINKLER HEADS SHALL BE PROVIDED AT THE LOWEST LANDING AND TOP OF ALL STAIRTOWERS IN ACCORDANCE WITH NFPA 13. 18. SPRINKLER SHALL BE LOCATED IN THE CENTER OF CEILING TILES UNLESS SPECIFICALLY NOTED OTHERWISE. 					
TOP TOP OF PIPE TS TAMPER SWITCH TYP TYPICAL VIF VERIFY IN FIELD	M	LIMIT OF REMOVAL CONNECT TO EXISTING CLEAN AGENT SYSTEM PULL STATION CLEAN AGENT SYSTEM ABORT STATION	18. CONTRACTOR SHALL PROVIDE SHOP DRAWINGS PER SPECIFICATIONS PRIOR TO PURCHASING OR INSTALLING EQUIPMENT AND SYSTEMS INDICATED ON CONTRACT DOCUMENTS. PRIOR TO SUBMITTAL, CONTRACTOR SHALL VERIFY THAT ADEQUATE SPACE EXISTS FOR THE SUBMITTED EQUIPMENT. SHOP DRAWINGS MUST BE REVIEWED BY ARCHITECT/ENGINEER.	 ALL PIPING PENETRATIONS THROUGH FIRE RATED WALLS SHALL BE PROTECTED WITH UL LISTED FIREPROOFING SYSTEM TO MATCH THE RATING OF THE WALL OR FLOOR. PROVIDE NEC REQUIRED PIPE CLEARANCE ABOVE OR AROUND ANY ELECTRICAL EQUIPMENT, PANELS, ETC. 					
W/ WITH W/O WITHOUT WSP WET STAND PIPE	MD SV	MASTER DISABLE SWITCH SOLENOID VALVE	19. CONTRACTOR SHALL BE RESPONSIBLE FOR ALL COSTS INCURRED BY OTHER TRADES DUE TO SUBSTITUTION OF OTHER THAN SCHEDULED EQUIPMENT. WHEN EQUIPMENT FURNISHED IS DIFFERENT THAN INDICATED, THE COST OF ADDITIONAL ELECTRICAL SERVICE, STRUCTURAL AND RELATED WORK SHALL BE PAID BY THIS CONTRACTOR.	21. PROVIDE PROTECTIVE SPRINKLER GUARDS ON SPRINKLER HEADS LOCATED BELOW 7'-0" A.F.F. IN MECHANICAL ROOMS, STORAGE ROOMS, PUMP ROOMS, SERVICE AREAS, GYMNASIUMS REGARDLESS OF SPRINKLER HEAD ELEVATION AND WHERE OTHERWISE SUSCEPTIBLE TO DAMAGE.					
PIPE LOCATION NOTES 1 CONCEALED IN CEILING SPACE ABOVE	CI EPO AC-3	CYLINDER INITIATOR EMERGENCY POWER OFF AC UNIT NUMBER	 20. ALL WORK SHALL BE EXECUTED IN A NEAT AND WORKMANLIKE MANNER AND SHALL BE DONE IN ACCORDANCE WITH GOOD TRADE PRACTICE AND IN CONFORMANCE WITH APPLICABLE MANUFACTURERS' RECOMMENDATIONS. 21. CONTRACTOR SHALL REMOVE ALL TRASH, DEBRIS AND DEMOLITION MATERIAL FROM PREMISES AT THE END OF 	22. SPRINKLER PIPING, IN BAR JOIST CONSTRUCTION, SHALL BE SUPPORTED FROM PANEL POINTS OF BAR JOIST. THRUST SUPPORTS SHALL BE ATTACHED TO TOP CHORD ONLY, UNLESS SUFFICIENT CROSS BRACING IS PROVIDED.					
2 EXPOSED IN STRUCTURE ABOVE	\rightarrow \times \leftarrow	CLEAN AGENT DISCHARGE NOZZLE (UNDER FLOOR)	EACH DAY. 22. RESTORE ALL SURFACES (WALLS, CEILINGS, FLOORS AND ROOFS) THAT ARE DAMAGED BY THE WORK OF THIS CONTRACT TO THEIR ORIGINAL CONDITION AT NO EXTRA COST TO THE OWNER.	23. FOR ADDITION OR RELOCATION OF SPRINKLER HEADS IN NEW AND EXISTING CONSTRUCTION, ALL SPRINKLER HEAD RESPONSE CHARACTERISTICS SHALL MATCH EXISTING SPRINKLER HEADS WITHIN THE SCOPE OF WORK INCLUDING SURROUNDING SPACES OUTSIDE OF THE SCOPE OF WORK AS REQUIRED PER NFPA STANDARDS.					
CONCEALED IN CEILING SPACE, BELOW FLOOR	R •	CLEAN AGENT DISCHARGE NOZZLE (CEILING)	23. PRIOR TO EQUIPMENT STARTUP, CONTRACTOR SHALL PERFORM THE SPECIFIED STARTUP AND COMMISSIONING PROCEDURES.						
EXPOSED ON STRUCTURE, FLOOR BELOW	→) (←	CLEAN AGENT DISCHARGE NOZZLE (ABOVE CEILING)	 24. IN THE ABSENCE OF OTHER SPECIFIC INSTRUCTIONS, ALL WORK AND MATERIALS SUPPLIED SHALL BE GUARANTEED FOR A PERIOD OF ONE (1) YEAR FROM THE DATE OF THEIR ACCEPTANCE BY THE OWNER. 25. BALA CONSULTING ENGINEERS, INC. (BALA) WILL PROVIDE CONTRACTOR WITH ELECTRONIC CADD FILES OF THE 						
5 BELOW GRADE 6 RACK ON WALL, BELOW COUNTER TOP		EQUIPMENT TAG	ENGINEERING DESIGNS FOR THE SOLE USE IN EXPEDITING SHOP DRAWINGS. BALA'S FILES SHALL NOT BE DIRECTLY COPIED AND ISSUED AS SHOP DRAWINGS. THE CONTRACTOR SHALL BE RESPONSIBLE FOR ALL FIELD COORDINATION, DIMENSIONING AND ADHERENCE TO THE SHOP DRAWING REQUIREMENTS AS NOTED IN THE SPECIFICATIONS. SHOULD THE SHOP DRAWINGS SUBMITTED PROVE TO BE A DIRECT COPY OF OUR FILES WITHOUT THE NECESSARY FIELD COORDINATION, DIMENSIONING AND ADHERENCE TO THE SHOP DRAWING						
7 ABOVE FLOOR	DSP #	DRY STAND PIPE RISER No. SPRINKLER RISER No.	REQUIREMENTS AS NOTED IN THE SPECIFICATIONS, THESE SHOP DRAWINGS WILL BE RETURNED AS REJECTED. BALA'S ELECTRONIC FILES ARE SAVED IN VERSION REVIT 2021 AND ARE COMPATIBLE WITH ALL VERSIONS AFTER THAT. BALA MAKES NO REPRESENTATION AS TO THE COMPATIBILITY OF THESE FILES WITH THE CONTRACTOR'S HARDWARE OR THEIR SOFTWARE. DATA CONTAINED ON THESE ELECTRONIC FILES ARE PART OF BALA'S						
8 RUN THROUGH OR BETWEEN BAR JOIST	WSP #	WET STAND PIPE RISER No.	"INSTRUMENTS OF SERVICE" AND ARE COPYRIGHTED. CONTRACTOR'S USE OF FILES IS FOR THE SOLE PURPOSE AS A CONVENIENCE IN THE PREPARATION OF DRAWINGS FOR THE REFERENCED PROJECT. ANY OTHER USE OR REUSE BY CONTRACTOR IS UNLAWFUL.						
9 CONCEALED BELOW RAISED FLOOR	DR #	DRAIN RISER No.							

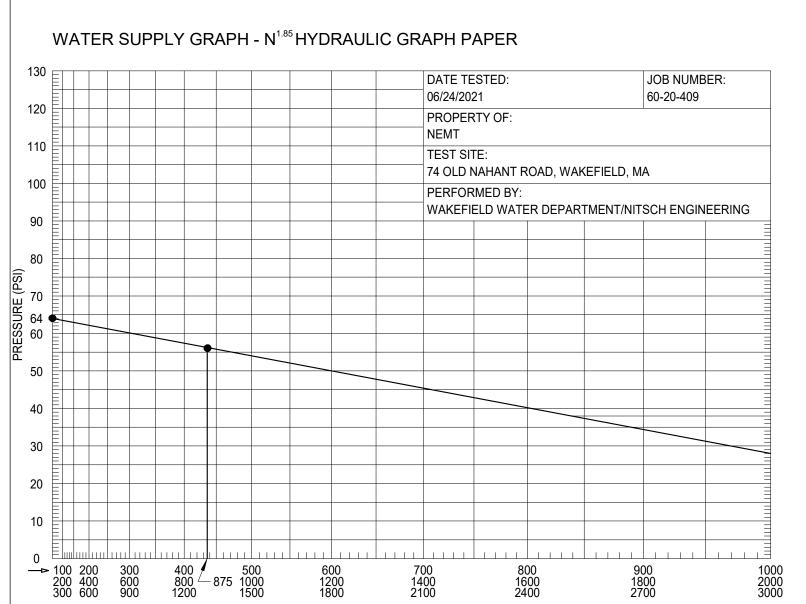

HYDRANT F	LOW	IES	DATA
STATIC PRESSURE RESIDUAL PRESSURE FLOW	56	PSI PSI GPM	
BASED ON PUMP TEST PE	RFORME	D	06/24/2021
DESIG	N CRI	TERI	A
LIGHT HAZARD OCCUPANC	Y FOR O	FFICE	TYPE SPACES & SIMILAR
DENSITY 0.10 GPM/SQ SPRINKLER SPACING			
MINIMUM 100 GPM OUTSIDE	E HOSE A	ALLOW	ANCE
ORDINARY HAZARD GROUF RECEIVING AREAS AND SIM			Y FOR STORAGE AREAS
DENSITY 0.20 GPM/SQ SPRINKLER SPACING			
MINIMUM 250 GPM OUTSIDE	E HOSE A	ALLOW	ANCE
ORDINARY HAZARD GROUF SPACES, KITCHEN TYPE SF			
DENSITY 0.15 GPM/SQ SPRINKLER SPACING			
MINIMUM 250 GPM OUTSIDE	E HOSE A	ALLOW	ANCE
EXTRA HAZARD GROUP II C	CCUPAN	ICY FO	R PAINT BOOTHS
DENSITY 0.40 GPM/SQ SPRINKLER SPACING			
MINIMUM 500 GPM OUTSIDE	E HOSE A	ALLOW	ANCE
EXTRA HAZARD GROUP I O	CCUPAN	CY FO	R METAL FABRICATION
DENSITY 0.30 GPM/SQ SPRINKLER SPACING			

	DRAWING LIST - FIRE	. FNU			1				
DRAWING NUMBER	DRAWING TITLE	06-23-2022 DESIGN DEVELOPMENT COST ESTIMATE SET	11-21-2022 60% CONSTRUCTION DOCUMENTS COST ESTIMATE SET	01-13-2023 MSBA 60% CD SUBMISSION					
FP0-0-1	FIRE PROTECTION COVER SHEET	0	•	•					
FP1-1-0.5CD	FIRE PROTECTION UNDER MEZZANINE - AREAS C&D		0	•					
FP1-1-0C	FIRE PROTECTION LOWER LEVEL FLOOR PLAN - AREA C	0	•	•					
FP1-1-0D	FIRE PROTECTION LOWER LEVEL FLOOR PLAN - AREA D	0	•	•					
FP1-1-1.5AB	FIRE PROTECTION FIRST FLOOR MEZZANINE LVL PLAN - AREA A		0	•					
FP1-1-1A	FIRE PROTECTION FIRST FLOOR PLAN - AREA A	0	•	•					
FP1-1-1B	FIRE PROTECTION FIRST FLOOR PLAN - AREA B	0	•	•					
FP1-1-1C	FIRE PROTECTION FIRST FLOOR PLAN - AREA C	0	•	•					
FP1-1-1D	FIRE PROTECTION FIRST FLOOR PLAN - AREA D	<u> </u>	•	•					
FP1-1-2A	FIRE PROTECTION SECOND FLOOR PLAN - AREA A	O	•	•					
FP1-1-2B	FIRE PROTECTION SECOND FLOOR PLAN - AREA B	O	•	•					
FP1-1-2C	FIRE PROTECTION SECOND FLOOR PLAN - AREA C	O	•	•			1		
FP1-1-2D	FIRE PROTECTION SECOND FLOOR PLAN - AREA D	O	•	•					
FP1-1-3A FP1-1-3B	FIRE PROTECTION THIRD FLOOR PLAN - AREA A FIRE PROTECTION THIRD FLOOR PLAN - AREA B	O	•	•					
FP1-1-3B FP1-1-3C	FIRE PROTECTION THIRD FLOOR PLAN - AREA C	0	•	•					
FP1-1-3C FP1-1-3D	FIRE PROTECTION THIRD FLOOR PLAN - AREA D	0	•	•				 	
FP1-1-4A	FIRE PROTECTION THIRD FLOOR PLAN - AREA A	0	•	•					
FP1-1-4B	FIRE PROTECTION FOURTH FLOOR PLAN - AREA B	0	•	•					
FP1-1-4C	FIRE PROTECTION FOURTH FLOOR PLAN - AREA C	0	•	•	1				
FP1-1-4D	FIRE PROTECTION FOURTH FLOOR PLAN - AREA D	0	•	•					
FP1-2-1A	FIRE PROTECTION ROOF PLAN - AREA A	0	•	•					
FP1-2-1B	FIRE PROTECTION ROOF PLAN - AREA B	0	•	•	1				
FP1-2-1C	FIRE PROTECTION ROOF PLAN - AREA C	0	•	•					
FP1-2-1D	FIRE PROTECTION ROOF PLAN - AREA D	0	•	•				+ +	
FP5-0-1	FIRE PROTECTION RISER DIAGRAM	9	•	•			1		
FP6-0-1	FIRE PROTECTION DETAILS	0	•	•		+		+ +	



Drummey Rosane Anderson, Inc. 225 Oakland Road Studio 205 South Windsor, CT 06074 260 Charles Street Studio 300 Waltham, MA 02453

Planning | Architecture | Interior Design

Tel: 617.964.1700 www.draws.com Northeast Metropolitan Regional Vocational High

Wakefield, MA 01880

School


MSBA 60% CD SUBMISSION

BALA ENGINEERS
PHIADELPHA | NEW YORK | BOSTON | BALTMORE | WASHINGTON, DC

January 13, 2023


KEY PLAN

PROJECT NORTH MAGNETIC NORTH

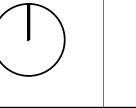



PROTECTION COVER SHEET

FP0-0-1

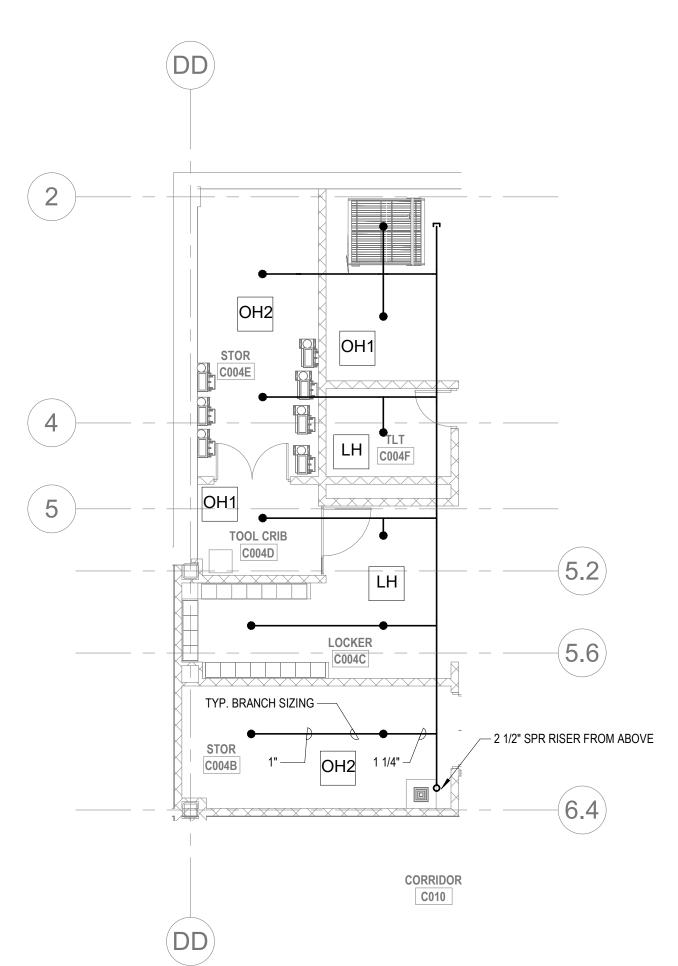



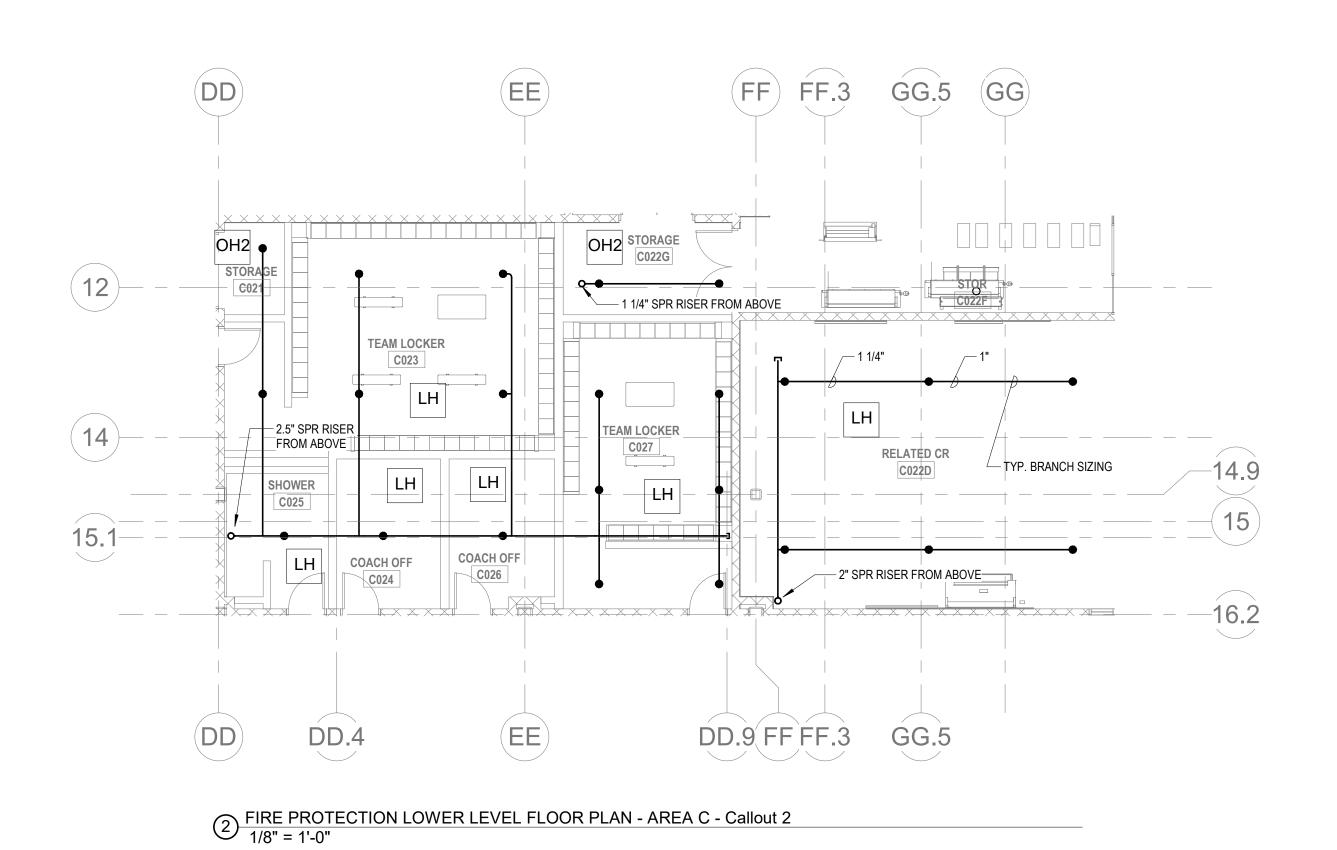

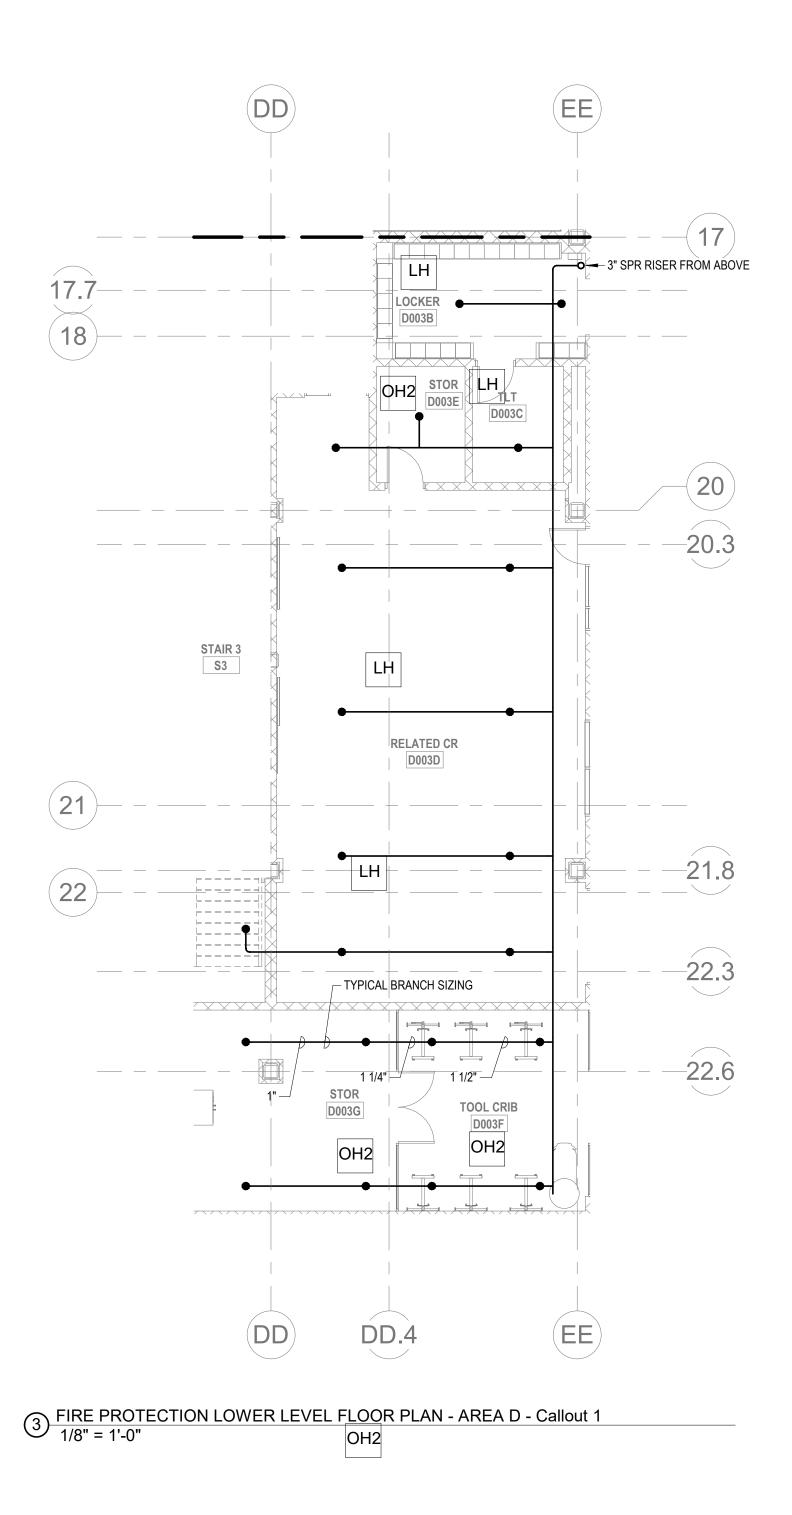

Drummey Rosane Anderson, Inc. 225 Oakland Road 260 Charles Street Studio 205 South Windsor, CT

Waltham, MA Planning | Architecture | Interior Design Tel: 617.964.1700 www.draws.com

Studio 300


Northeast Metropolitan Regional Vocational High School

Wakefield, MA 01880

BALA ENGINEERS MECHANICAL | ELECTRICAL | PLUMBING | FIRE PROTECTION STRUCTURAL | TECHNOLOGY | COMMISSIONING


MSBA 60% CD SUBMISSION

January 13, 2023

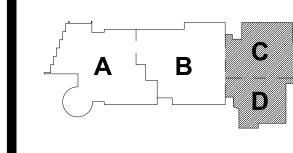

KEY PLAN

PROJECT NORTH MAGNETIC NORTH

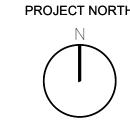


PROTECTION UNDER

MEZZANINE -AREAS C&D

Scale: 1/8" = 1'-0"

Drawn By: DRA **FP1-1-0.5CD** Date: January 13, 2023

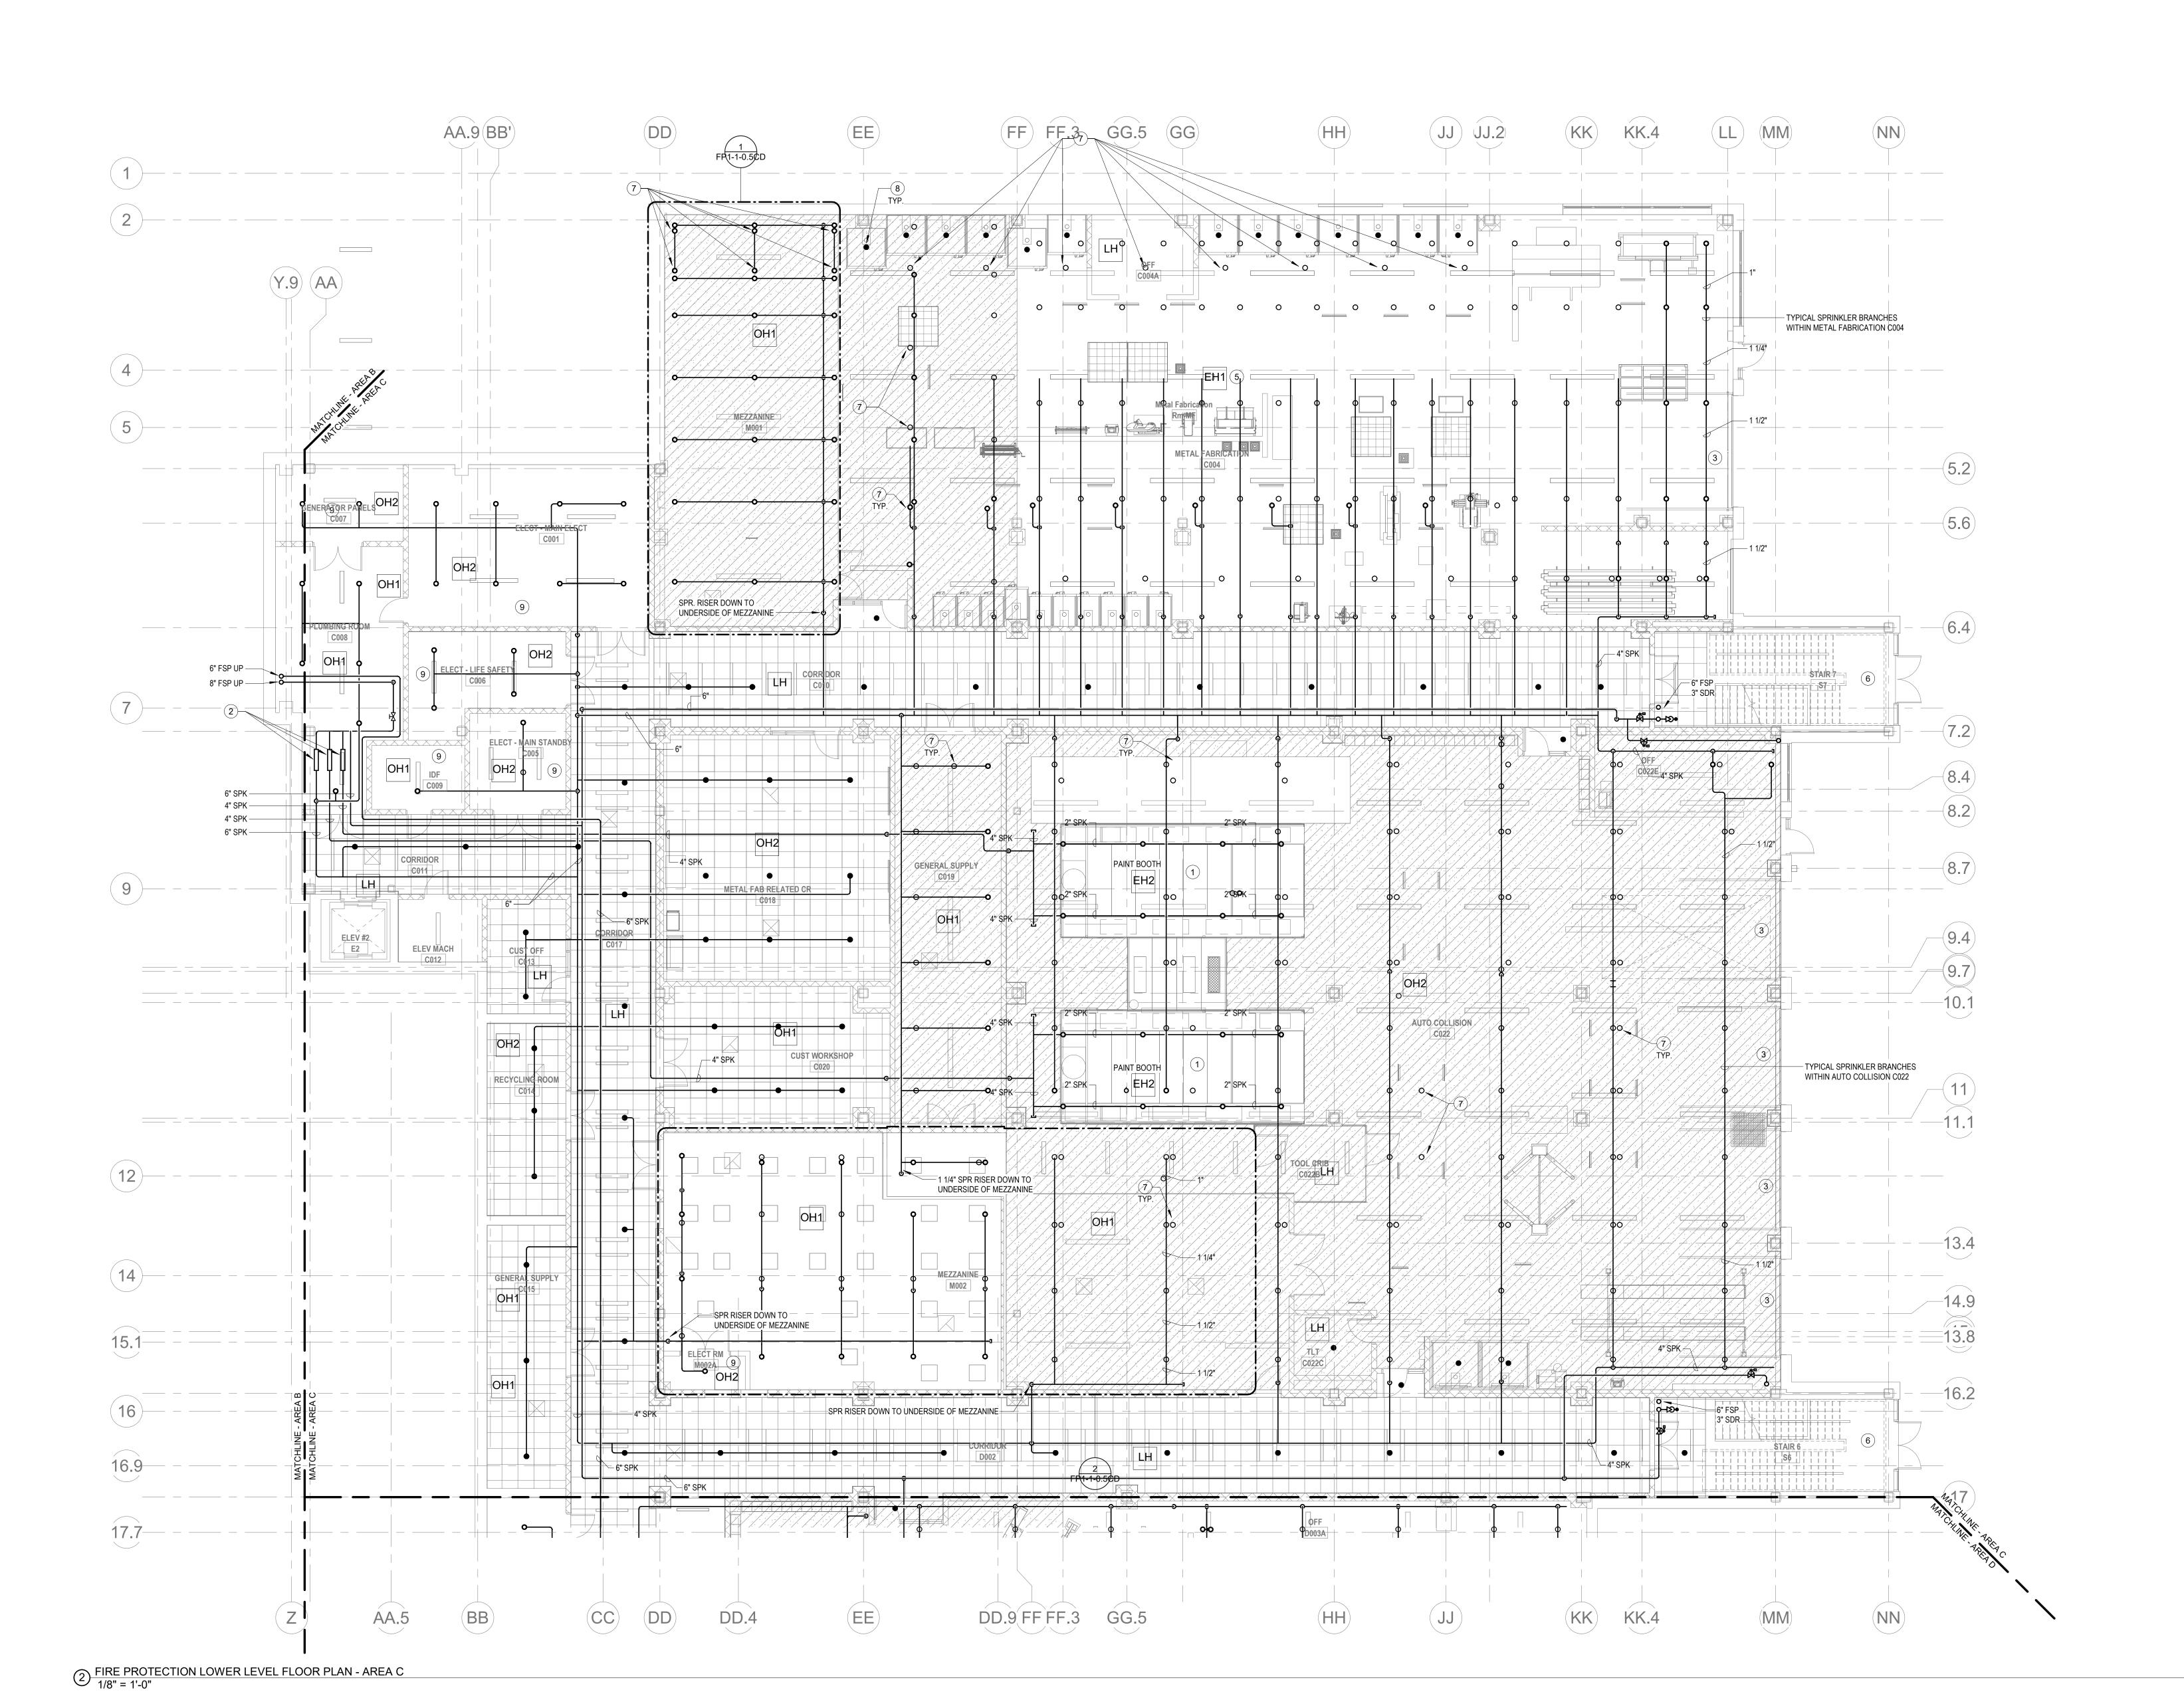

LH LIGHT HAZARD OCCUPANCY

OH ORDINARY HAZARD OCCUPANCY

EH EXTRA HAZARD OCCUPANCY

1 THE INDICATED AREA SHALL BE PROTECTED BY SPRINKLERS WITH A EXTRA HAZARD GROUP 2 EQUIVA SPRINKLER DESIGN CRITERIA PER

PROVIDE FLOOR CONTROL VALVE. THE FLOOR CONTROL VALVE
ASSEMBLY SHALL CONSIST OF A BUTTERFLY VALVE, CHECK VALVE, FLOW
SWITCH, PRESSURE GAUGE AND MAIN DRAIN VALVE WITH INSPECTOR'S
TEST CONNECTION. (AS REQUIRED PER DETAIL)

3 PROVIDE DRY PENDENTS WITH GUARDS BENEATH THE GARAGE DOOR

FOR ALL PIPING PASSING THROUGH COORDINATE Y9, PROVIDE AN EXPANSION LOOP AND ADD FLEXIBLE COUPLINGS ON EITHER SIDE.

5 PROVIDE HIGH TEMPERATURE RATED SPRINKLERS THROUGHOUT THE INDICATED AREA.

6 SPRINKLER COVERAGE REQUIRED BELOW ALL ACCESSIBLE AREAS.

(7) PROVIDE SPRINKLER UNDERSIDE OF DUCTWORK. FIELD COORDINATE.

PROVIDE SPRINKLER IN EACH WELDING PAINT BOOTH. COORDINATE SPRINKLER LOCATION WITH MANUFACTURER..

9 FINAL LOCATION OF ALL PIPING AND SPRINKLER HEADS IN ELECTRIC TYPE SPACES AND UTILITY ROOMS SHALL BE FIELD COORDINATED WITH ELECTRICAL CONTRACTOR AS TO VERIFY COMPLIANCE WITH ELECTRICAL CODES.

GENERAL NOTES FOR PAINT SPRAY BOOTHS

 SPRINKLERS PROTECTING THE PAINT SPRAY BOOTHS SHALL BE DESIGNED FOR AN EXTRA HAZARD (GROUP 2) OCCUPANCY IN ACCORDANCE WTH NFPA 13.

 THE SPRINKLER SYSTEM PROTECTING DUCTS SHALL MEET ALL OF THE FOLLOWING REQUIREMENTS:
 A. ONE SPRINKLER SHALL BE LOCATED AT THE TOP OF EACH VERTICAL RISER AND AT THE MIDPOINT OF EACH OFFSET. ADDITIONAL HEADS SHALL BE SPACED ON 24 FT

A. ONE SPRINKLER SHALL BE LOCATED AT THE TOP OF EACH VERTICAL RISER AND AT THE MIDPOINT OF EACH OFFSET. ADDITIONAL HEADS SHALL BE SPACED ON 24 FT CENTERS IF THE RISE IS GREATER TAHN 24 FT.
 B. HORIZONTAL EXHAUST DUCTS SHALL HAVE SPRINKLERS LOCATED 12 FT CENTERS

BEGINNING NO MORE THAN 6 FT FROM THE DUCT ENTRANCE.

C. WHERE EXHAUST DUCTS ARE MANIFOLDED, A SPRINKLER SHALL BE LOCATED IN THE MANIFOLD AT THE JUNCTION OF EACH EXHAUST DUCT WITH THE MANIFOLD.
D. SPRINKLERS SHALL PROVIDE A MINIMUM FLOW OF 30 GPM PER HEAD AT A MINIMUM OF 15 PSI PRESSURE.
E. SPRINKLERS SHALL BE ORDINARY TEMPURATE RATE, UNLESS REQUIRED TO BE

HIGHER DUE TO OPERATING TEMPERATURES MEASURED IN THE DUCTS, IN WHICH CASE THE OPERATING TEMPERATURE SHALL BE AT LEAST 50 F ABOVE THE INSIDE

TEMPERATURE OF THE DUCT.

3. EXHAUST DUCTS SHALL BE PROVIDED WITH ACCESS OPENING FOR INSPECTION AND MAINTENANCE OF SPRINKLERS.

BE REPLACED WITH NEW SPRINKLERS.

 SPRNKLERS SHALL BE PERMITTED TO BE COVERED ONLY BY CELLOPHANE BAGS HAVING A THICKNESS OF 0.003 IN. OR LESS OR BY THIN PAPER BAGS. THESE COVERINGS SHALL BE REPLACED FREQURENTLY SO THAT HEAVY DEPOSITS DO NOT ACCUMULATE.
 SPRINKLERS THAT HAVE BEEN PAINTED OR COATED BY OVERSPRAY OR RESIDUES SHALL

GENERAL NOTES

1. WITHIN AREA OF SCOPE EXTEND NEW 4" SPRINKLER MAIN PIPING FROM A NEW ZONE CONTROL VALVE. CONTRACTOR SHALL SIZE BRANCH PIPING TO ALLOW FOR VELOCITY WILL REMAIN BELOW 20 FPS. PROVIDE QUICK RESPONSE UPRIGHTS IN OPEN CEILING AREAS AND CONCEALED PENDENTS IN AREAS WHERE DROP CEILINGS ARE INDICATED. EXTEND NEW 1" ARMOVERS TO NEW CONCEALED PENDENTS. 1" SPRIGS SHALL BE ROUTED TO UPRIGHTS WITHIN 12" OF DECK. DESIGN INTENT IS TO PROVIDE A CODE COMPLIANT SPRINKLER LAYOUT FOR THE NEW PROGRAM LAYOUT. CONTRACTOR IS

2. PROVIDE PROTECTIVE SPRINKLER GUARDS ON SPRINKLER HEADS LOCATED BELOW 7'-0" A.F.F. IN MECHANICAL ROOMS, STORAGE ROOMS, PUMP ROOMS, SERVICE AREAS, GYMNASIUMS REGARDLESS OF SPRINKLER HEAD ELEVATION AND WHERE OTHERWISE SUSCEPTIBLE TO DAMAGE.

REQUIRE TO SUBMIT HYDRAULIC CALCULATIONS TERMINATED AT THE HYDRANT OUTLET.

SPRINKLERS SHALL BE PROVIDED WITH MAXIMUM SPACING OF 6 FEET NEAR STAIR FLOOR OPENINGS.

4. SPRINKELRS SHALL BE PROVIDED BENEATH MECHANICAL DUCTWORK AND/OR GROUPS OF MECHANICAL DUCTWORK GREATER THAN 4 FT IN WIDTH. WHERE DUCTWORK INTERFERE WITH SPRINKLERS, ADDITIONAL COVERAGE SHALL BE PROVIDED IN ACCORDANCE WITH NFPA 13

5. CONCEALED SPRNKLER HEAD FINISHES TO MATCH CEILING COLOR. UNLESS OTHERWISE NOTED REFER TO ARCHITECTURAL DRAWINGS.

SPRINKLERS SHALL BE PROVIDED BENEATH ACCESSIBLE LANDINGS. PIPING AND
FITTINGS SHALL BE PROVIDED TO SPRINKLERS BENEATH ACCESSIBLE LANDINGS AND AT
MAIN LANDING. LOCATION OF ALL EXPOSED PIPING SHALL BE FIELD COORDINATED WITH
ARCHITECT.

7. DRY PENDENTS AND/OR DRY SIDEWALLS SHALL BE PROVIDED IN ROOMS/AREAS WHERE THE OPERATING TEMPERATURE IS LESS THAN 40F.

8. SPRINKLERS SHALL BE PROVIED BENEATH FIXTURES GREATER THAN 4 FT IN WIDTH.



Drummey Rosane Anderson, Inc.

225 Oakland Road Studio 205 South Windsor, CT Waltham, MA 06074 02453

Northeast
Metropolitan

Planning | Architecture | Interior Design

School

Wakefield, MA 01880

Regional


Vocational High

BALA CONSULTING ENGINEERS 52 TEMPLE PLACE BOSTON, MA 02111-1306 TEL: 617 537 6060 FAX: 617 357 WWW.BALA.COM

> MSBA 60% CD SUBMISSION

January 13, 2023




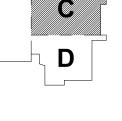

KEY PLAN

MAGNETIC NORTH



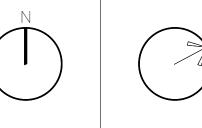


FIRE
PROTECTION
LOWER LEVEL
FLOOR PLAN AREA C

ale: 1/8" = 1'-0"

No.: 20202

wn By: DRA

FP1-1-0C

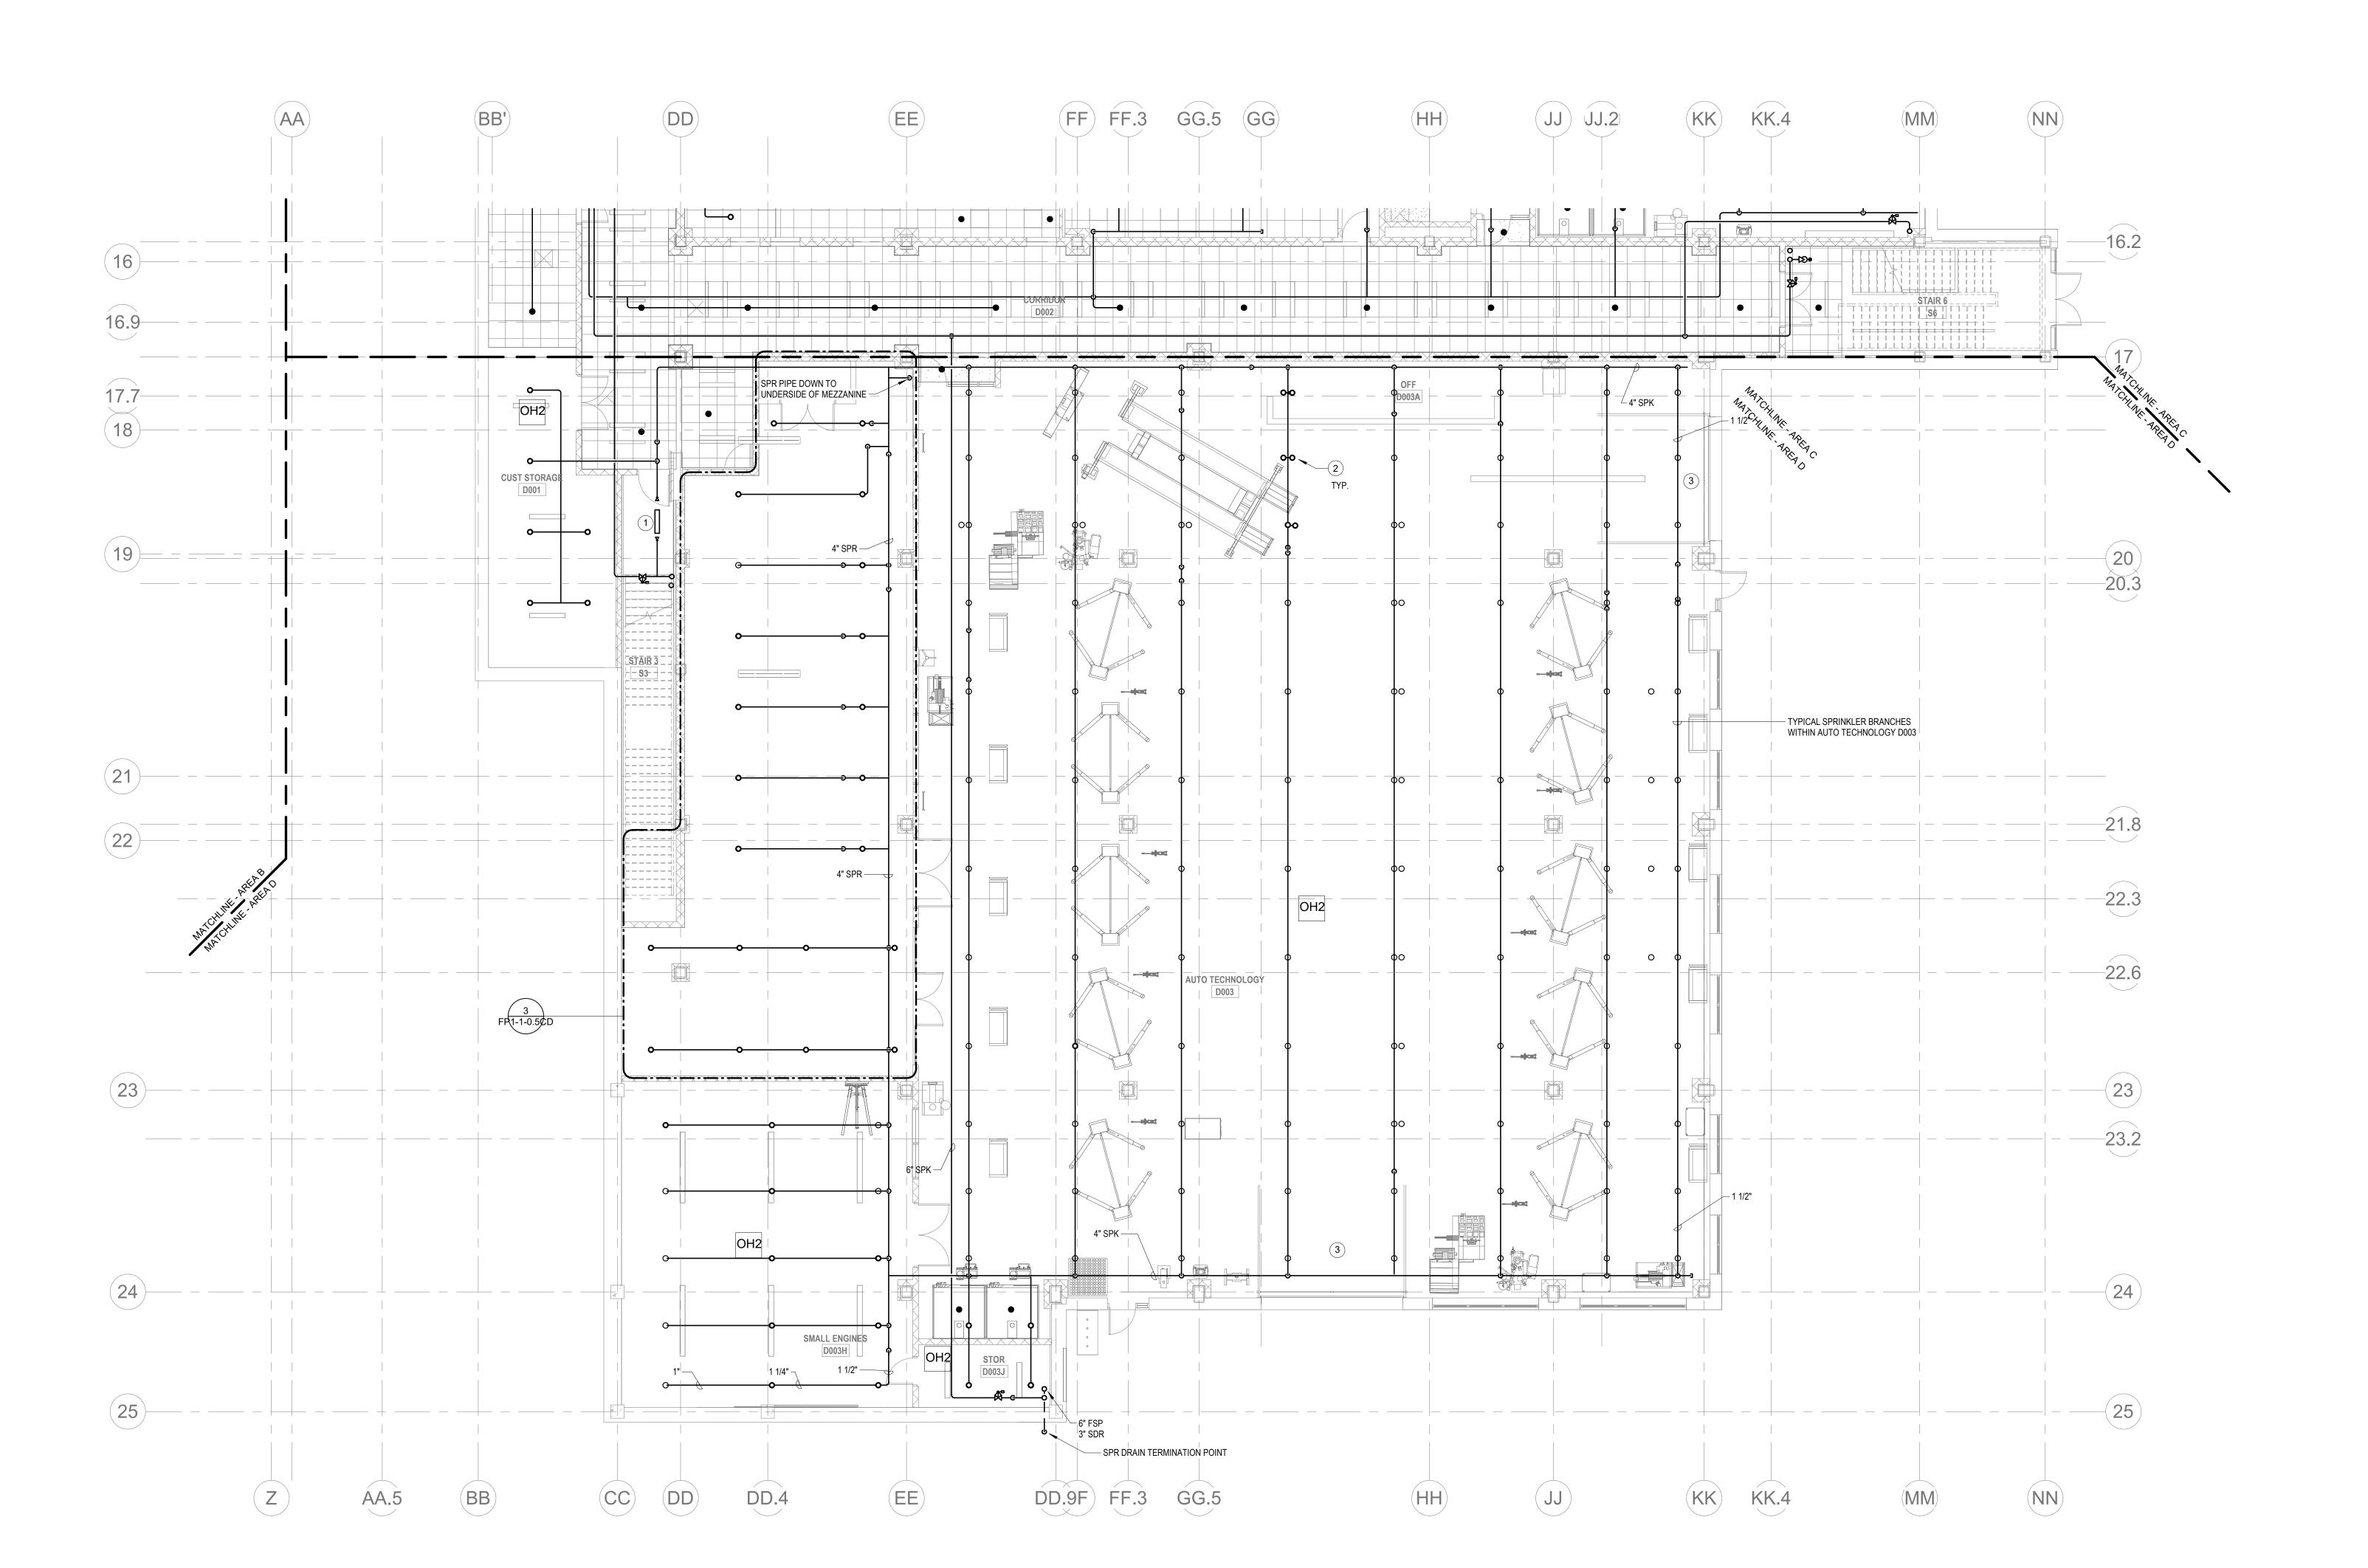

2 FIRE PROTECTION LOWER LEVEL FLOOR PLAN - AREA D
1/8" = 1'-0"

KEYNOTES

- LH LIGHT HAZARD OCCUPANCY
- OH ORDINARY HAZARD OCCUPANCY
- EH EXTRA HAZARD OCCUPANCY (1) PROVIDE FLOOR CONTROL VALVE. THE FLOOR CONTROL VALVE ASSEMBLY SHALL CONSIST OF A BUTTERFLY VALVE, CHECK VALVE, FLOW

TEST CONNECTION. (AS REQUIRED PER DETAIL)

(2) PROVIDE SPRINKLER UNDERSIDE OF DUCTWORK. FIELD COORDINATE. 3 PROVIDE DRY PENDENTS WITH GUARDS BENEATH THE GARAGE DOOR TRACK.

SWITCH, PRESSURE GAUGE AND MAIN DRAIN VALVE WITH INSPECTOR'S

GENERAL NOTES

- 1. WITHIN AREA OF SCOPE EXTEND NEW 4" SPRINKLER MAIN PIPING FROM A NEW ZONE CONTROL VALVE. CONTRACTOR SHALL SIZE BRANCH PIPING TO ALLOW FOR VELOCITY WILL REMAIN BELOW 20 FPS. PROVIDE QUICK RESPONSE UPRIGHTS IN OPEN CEILING AREAS AND CONCEALED PENDENTS IN AREAS WHERE DROP CEILINGS ARE INDICATED. EXTEND NEW 1" ARMOVERS TO NEW CONCEALED PENDENTS. 1" SPRIGS SHALL BE ROUTED TO UPRIGHTS WITHIN 12" OF DECK. DESIGN INTENT IS TO PROVIDE A CODE COMPLIANT SPRINKLER LAYOUT FOR THE NEW PROGRAM LAYOUT. CONTRACTOR IS REQUIRE TO SUBMIT HYDRAULIC CALCULATIONS TERMINATED AT THE HYDRANT OUTLET.
- 2. PROVIDE PROTECTIVE SPRINKLER GUARDS ON SPRINKLER HEADS LOCATED BELOW 7'-0" A.F.F. IN MECHANICAL ROOMS, STORAGE ROOMS, PUMP ROOMS, SERVICE AREAS, GYMNASIUMS REGARDLESS OF SPRINKLER HEAD ELEVATION AND WHERE OTHERWISE SUSCEPTIBLE TO DAMAGE.
- 3. SPRINKLERS SHALL BE PROVIDED WITH MAXIMUM SPACING OF 6 FEET NEAR STAIR FLOOR OPENINGS.
- 4. SPRINKELRS SHALL BE PROVIDED BENEATH MECHANICAL DUCTWORK AND/OR GROUPS OF MECHANICAL DUCTWORK GREATER THAN 4 FT IN WIDTH. WHERE DUCTWORK INTERFERE WITH SPRINKLERS, ADDITIONAL COVERAGE SHALL BE PROVIDED IN ACCORDANCE WITH NFPA 13
- 5. CONCEALED SPRNKLER HEAD FINISHES TO MATCH CEILING COLOR. UNLESS OTHERWISE NOTED REFER TO ARCHITECTURAL DRAWINGS. 6. SPRINKLERS SHALL BE PROVIDED BENEATH ACCESSIBLE LANDINGS. PIPING AND
- FITTINGS SHALL BE PROVIDED TO SPRINKLERS BENEATH ACCESSIBLE LANDINGS AND AT MAIN LANDING. LOCATION OF ALL EXPOSED PIPING SHALL BE FIELD COORDINATED WITH
- 7. DRY PENDENTS AND/OR DRY SIDEWALLS SHALL BE PROVIDED IN ROOMS/AREAS WHERE THE OPERATING TEMPERATURE IS LESS THAN 40F.
- 8. SPRINKLERS SHALL BE PROVIED BENEATH FIXTURES GREATER THAN 4 FT IN WIDTH.



Drummey Rosane Anderson, Inc. 225 Oakland Road 260 Charles Street Studio 205 South Windsor, CT Waltham, MA 06074

Planning | Architecture | Interior Design Tel: 617.964.1700 www.draws.com

Studio 300


02453


Northeast Metropolitan Regional Vocational High

Wakefield, MA 01880


MSBA 60% CD SUBMISSION

January 13, 2023

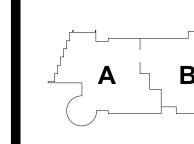

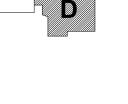

KEY PLAN

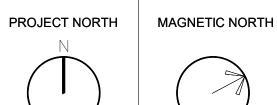

PROTECTION LOWER LEVEL FLOOR PLAN -AREA D

Drawn By: DRA

FP1-1-0D

- LH LIGHT HAZARD OCCUPANCY
- OH ORDINARY HAZARD OCCUPANCY
- EH EXTRA HAZARD OCCUPANCY
- 1 FINAL LOCATION OF ALL PIPING AND SPRINKLER HEADS IN ELECTRIC TYPE SPACES AND UTILITY ROOMS SHALL BE FIELD COORDINATED WITH ELECTRICAL CONTRACTOR AS TO VERIFY COMPLIANCE WITH ELECTRICAL CODES.



Drummey Rosane Anderson, Inc.

225 Oakland Road
Studio 205
South Windsor, CT

260 Charles Street
Studio 300
Waltham, MA

South Windsor, CT Waltham, MA 06074 02453

Planning | Architecture | Interior Design


Tel: 860.644.8300


www.draws.com

Northeast Metropolitan Regional Vocational High

School


Wakefield, MA 01880

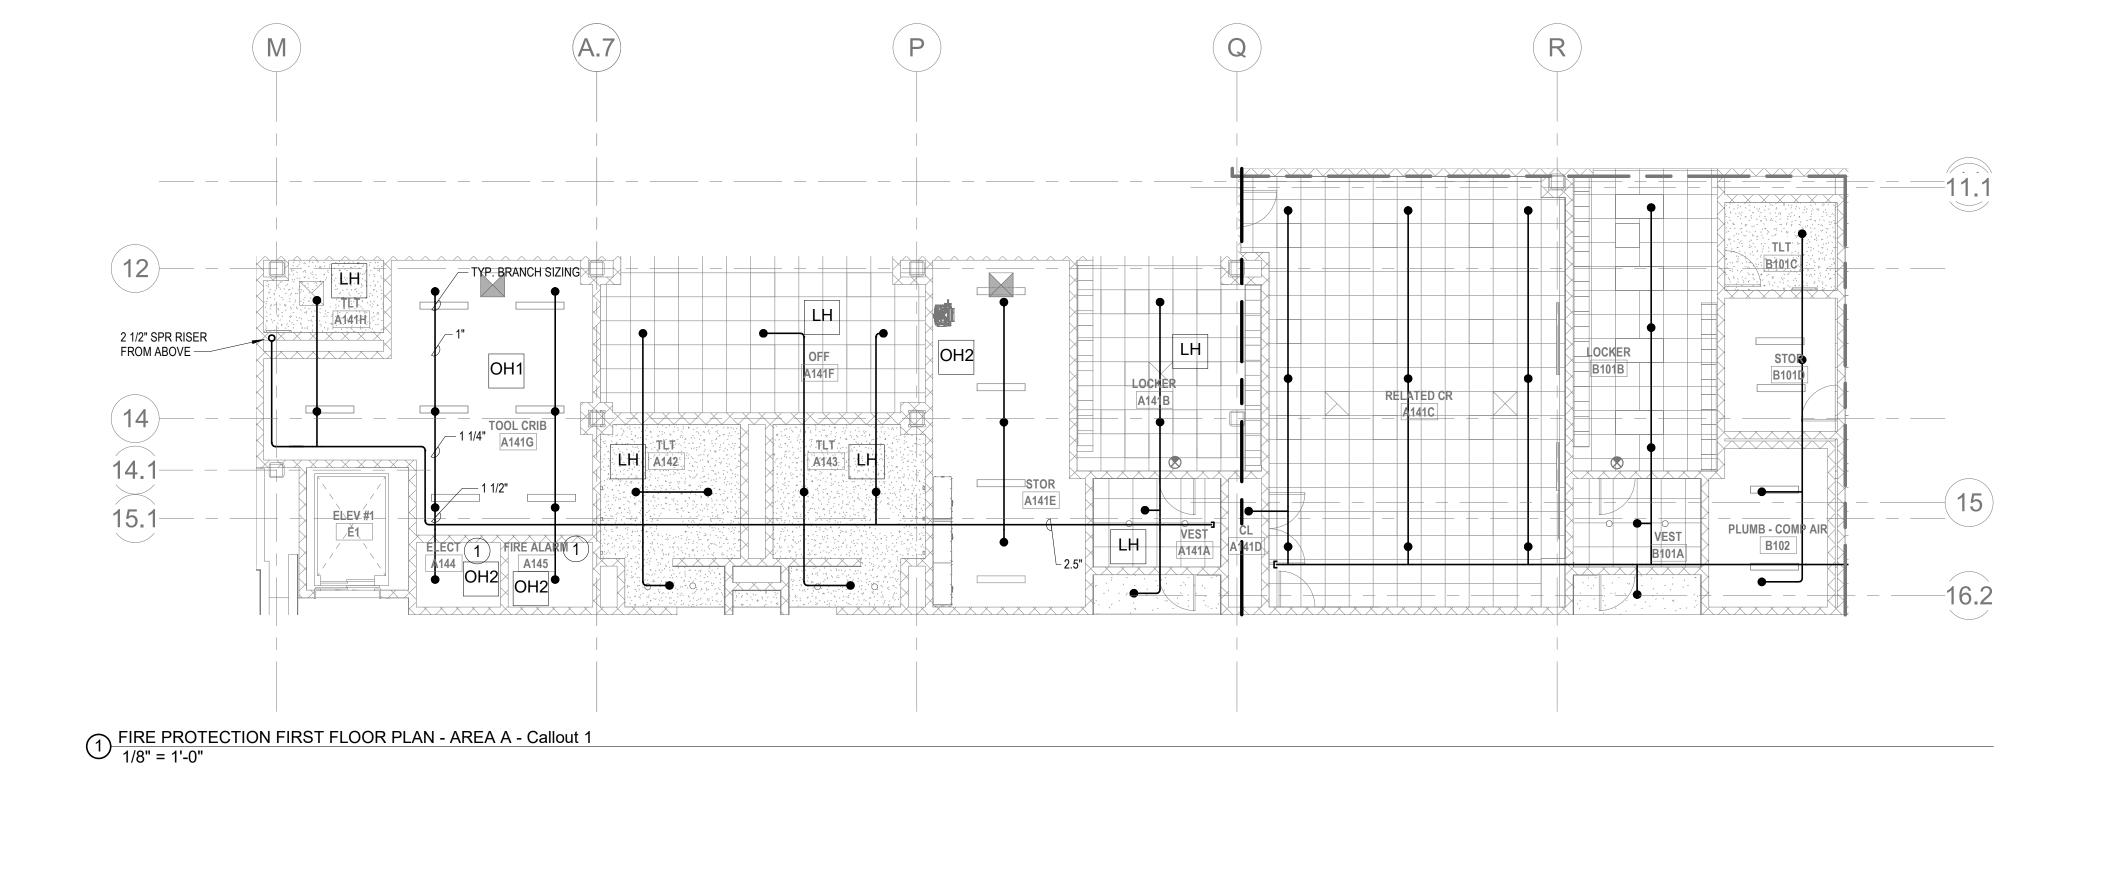

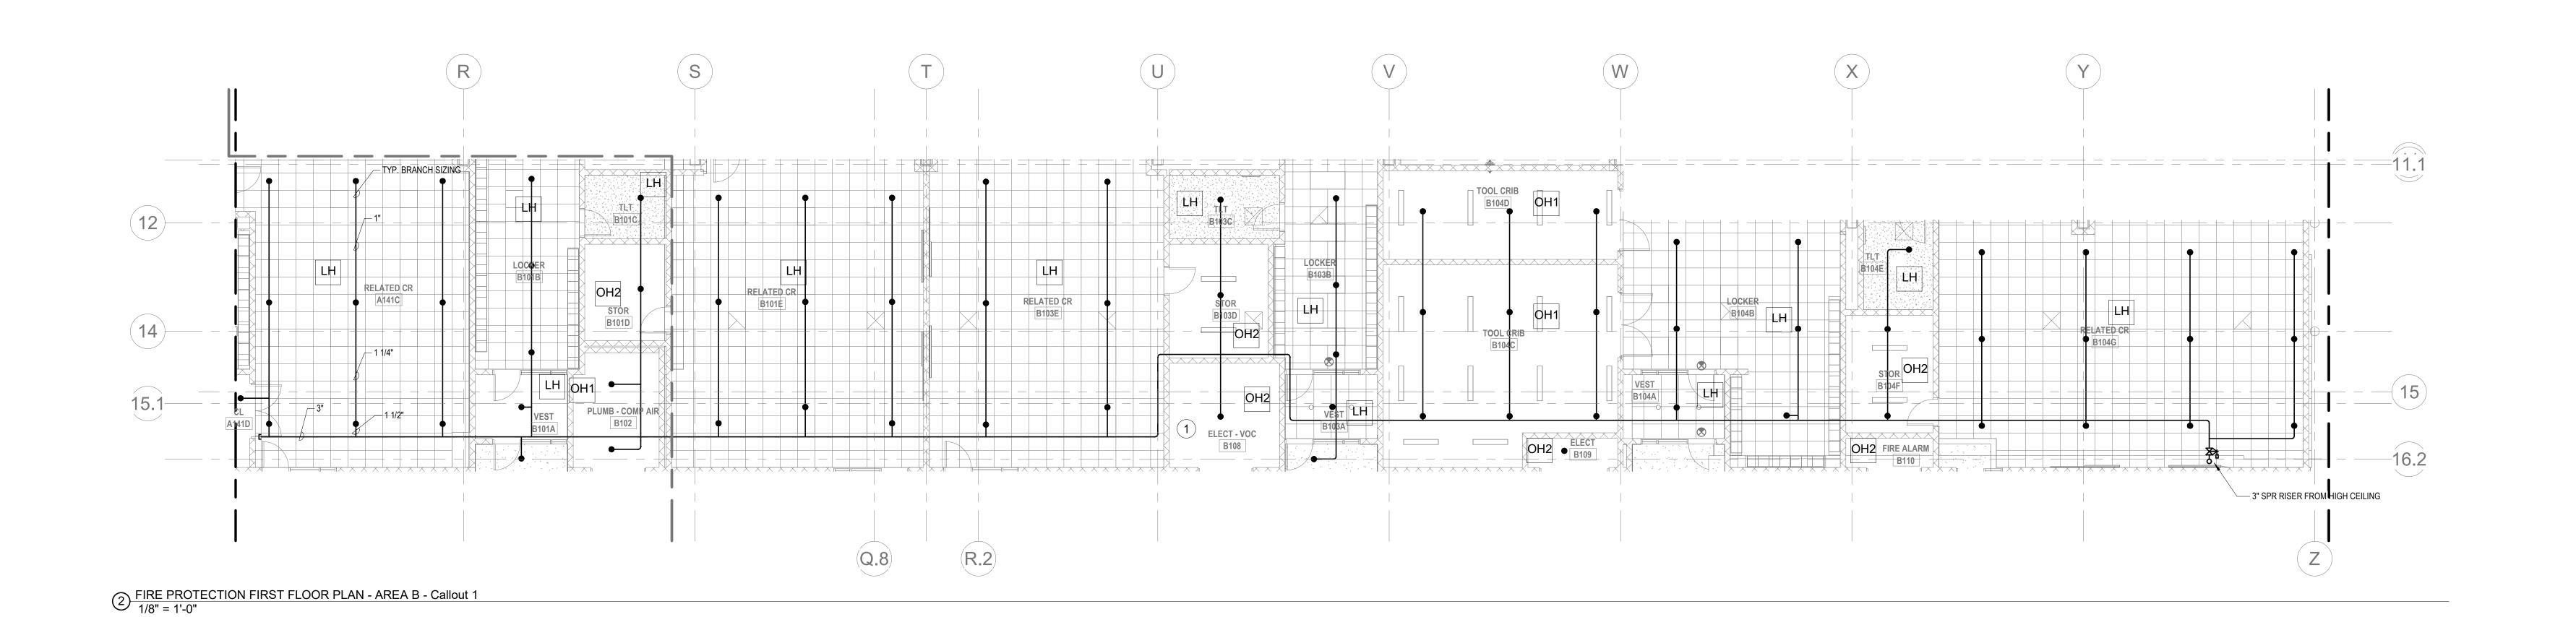

MSBA 60% CD SUBMISSION

January 13, 2023

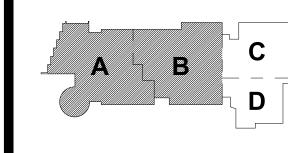

KEY PLAN

MAGNETIC NORTH


PROJECT NORTH

FIRE OTECTION ST FLOOR

PROTECTION FIRST FLOOR MEZZANINE LVL PLAN - AREA A

ale: 1/8" = 1'-0" o No.: 20202

Drawn By: DRA **FP1-1-1.5AB**Date: January 13, 2023

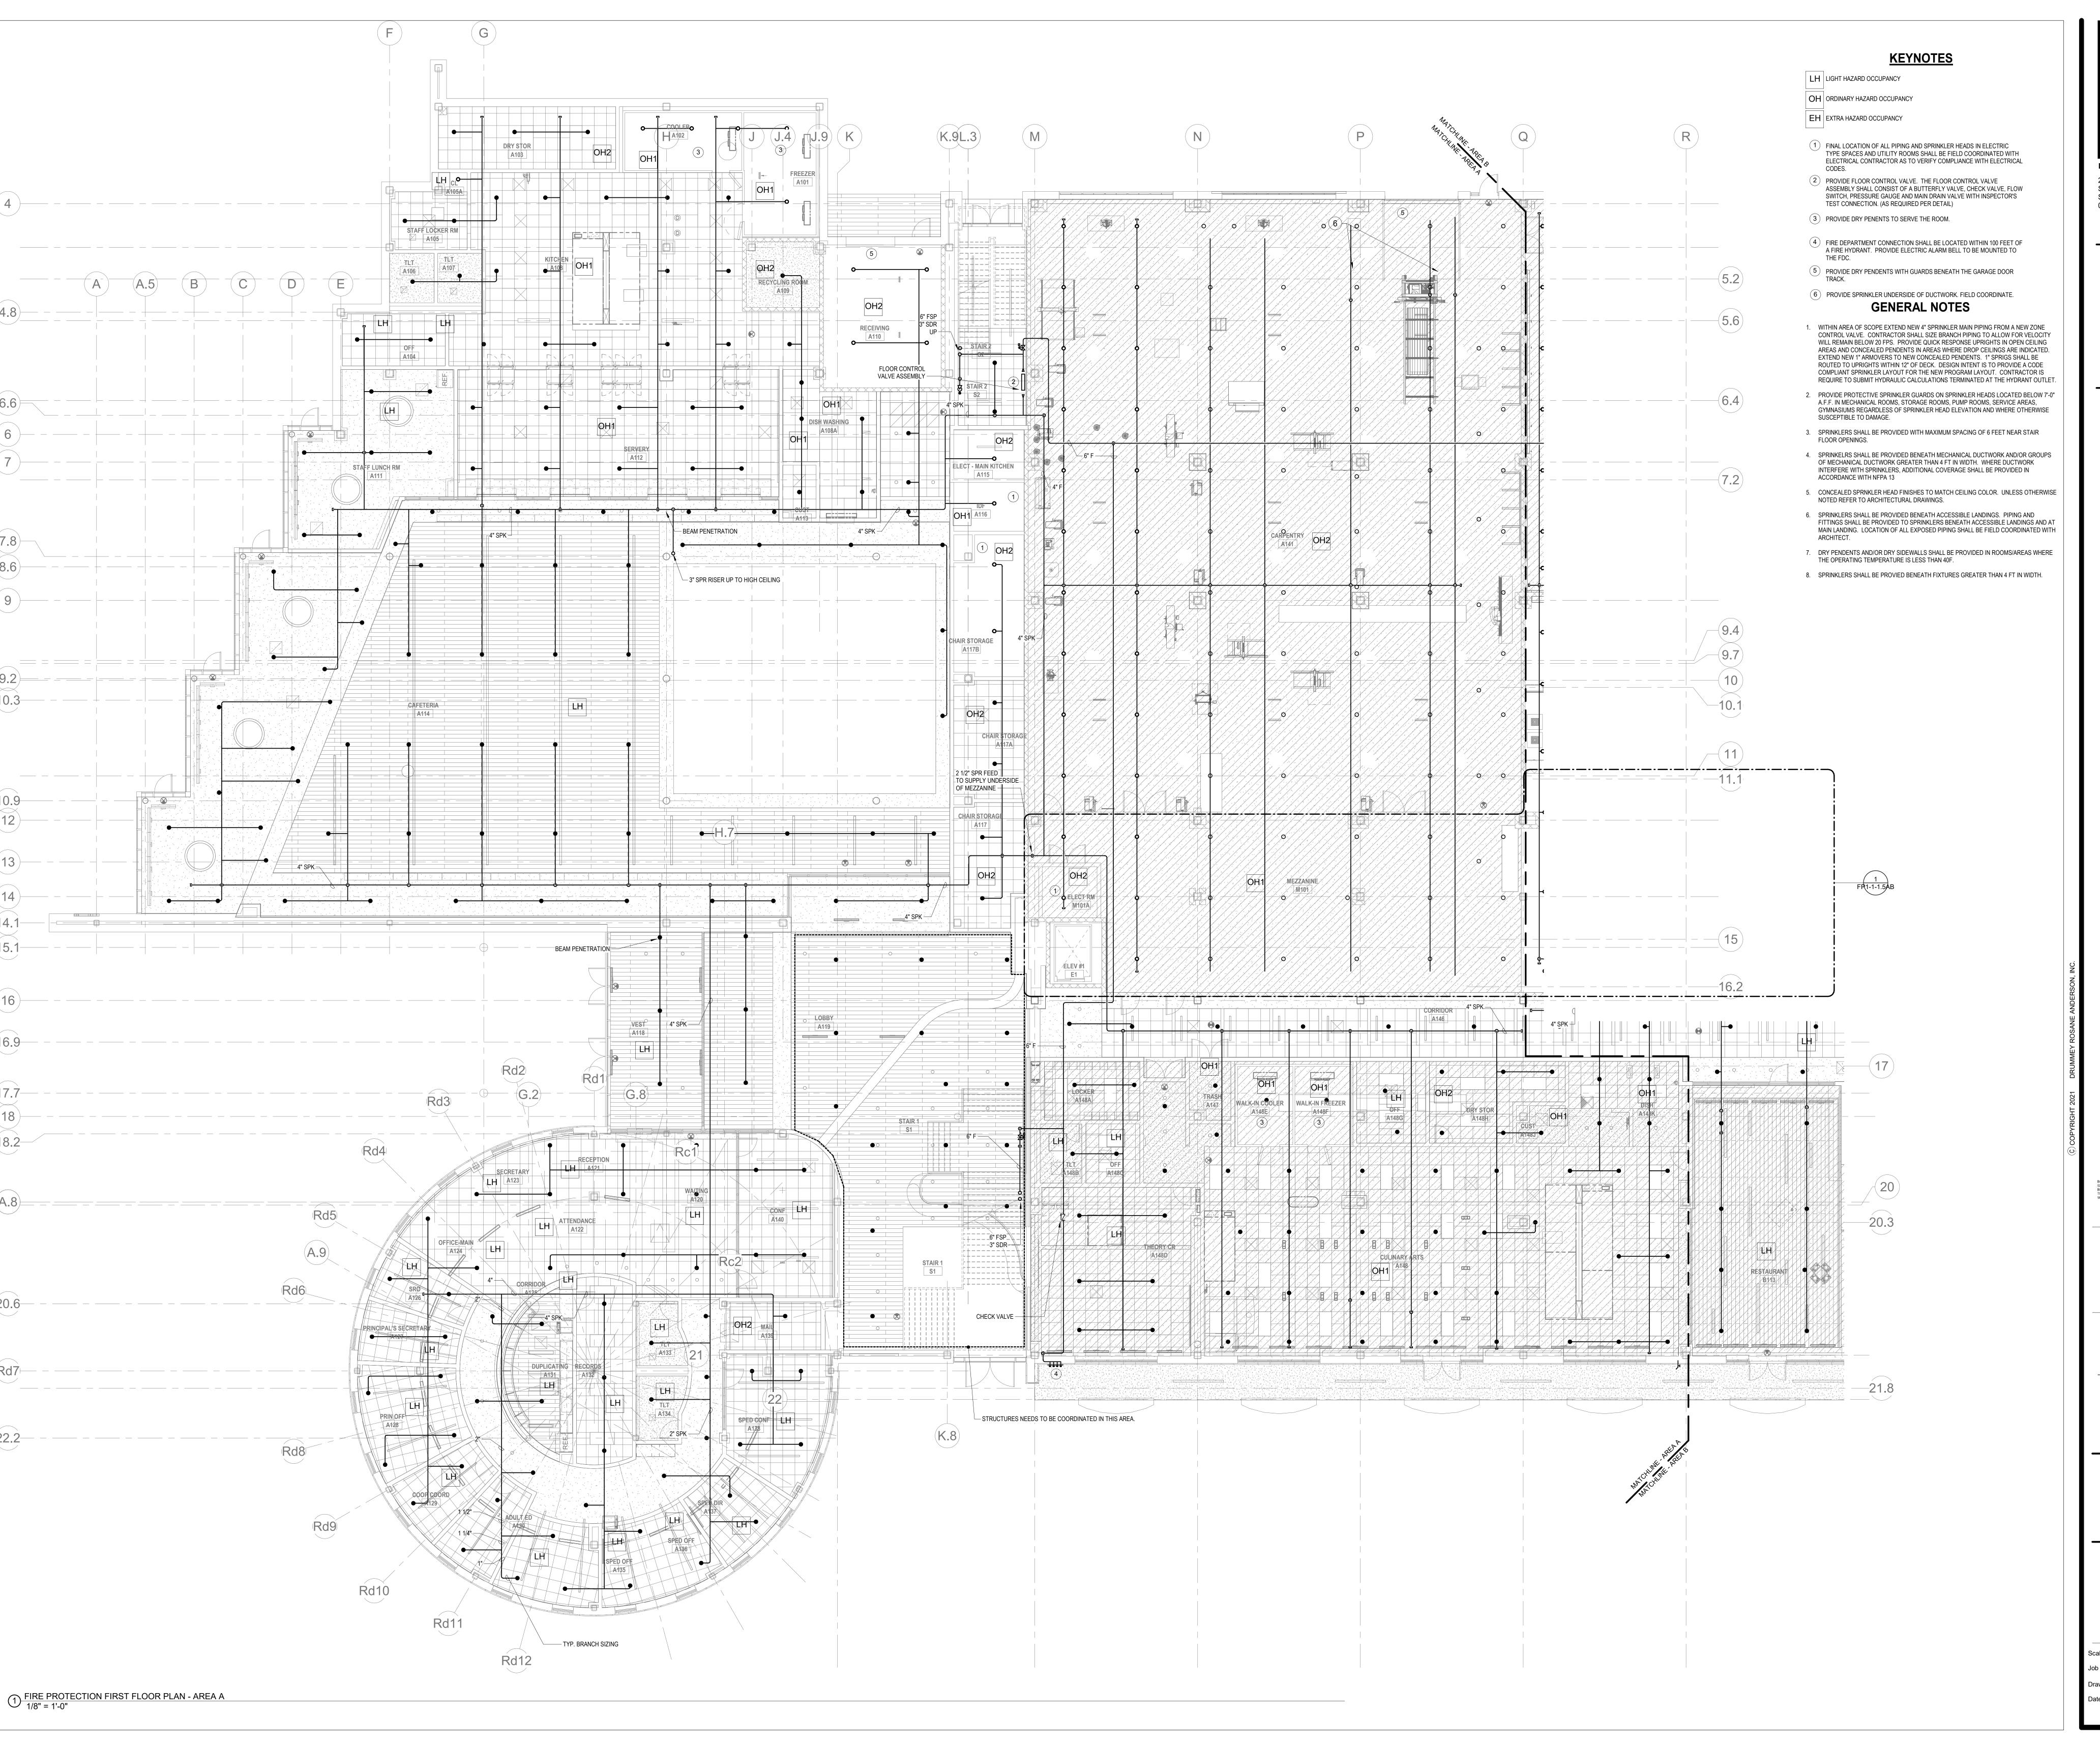



Drummey Rosane Anderson, Inc. 225 Oakland Road 260 Charles Street Studio 205 Studio 300 South Windsor, CT Waltham, MA


06074 Planning | Architecture | Interior Design Tel: 617.964.1700 www.draws.com

Northeast Metropolitan Regional Vocational High

Wakefield, MA 01880


MSBA 60% CD SUBMISSION

January 13, 2023

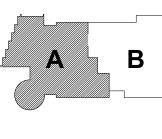


KEY PLAN

MAGNETIC NORTH

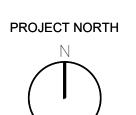



PROTECTION FIRST FLOOR PLAN - AREA A

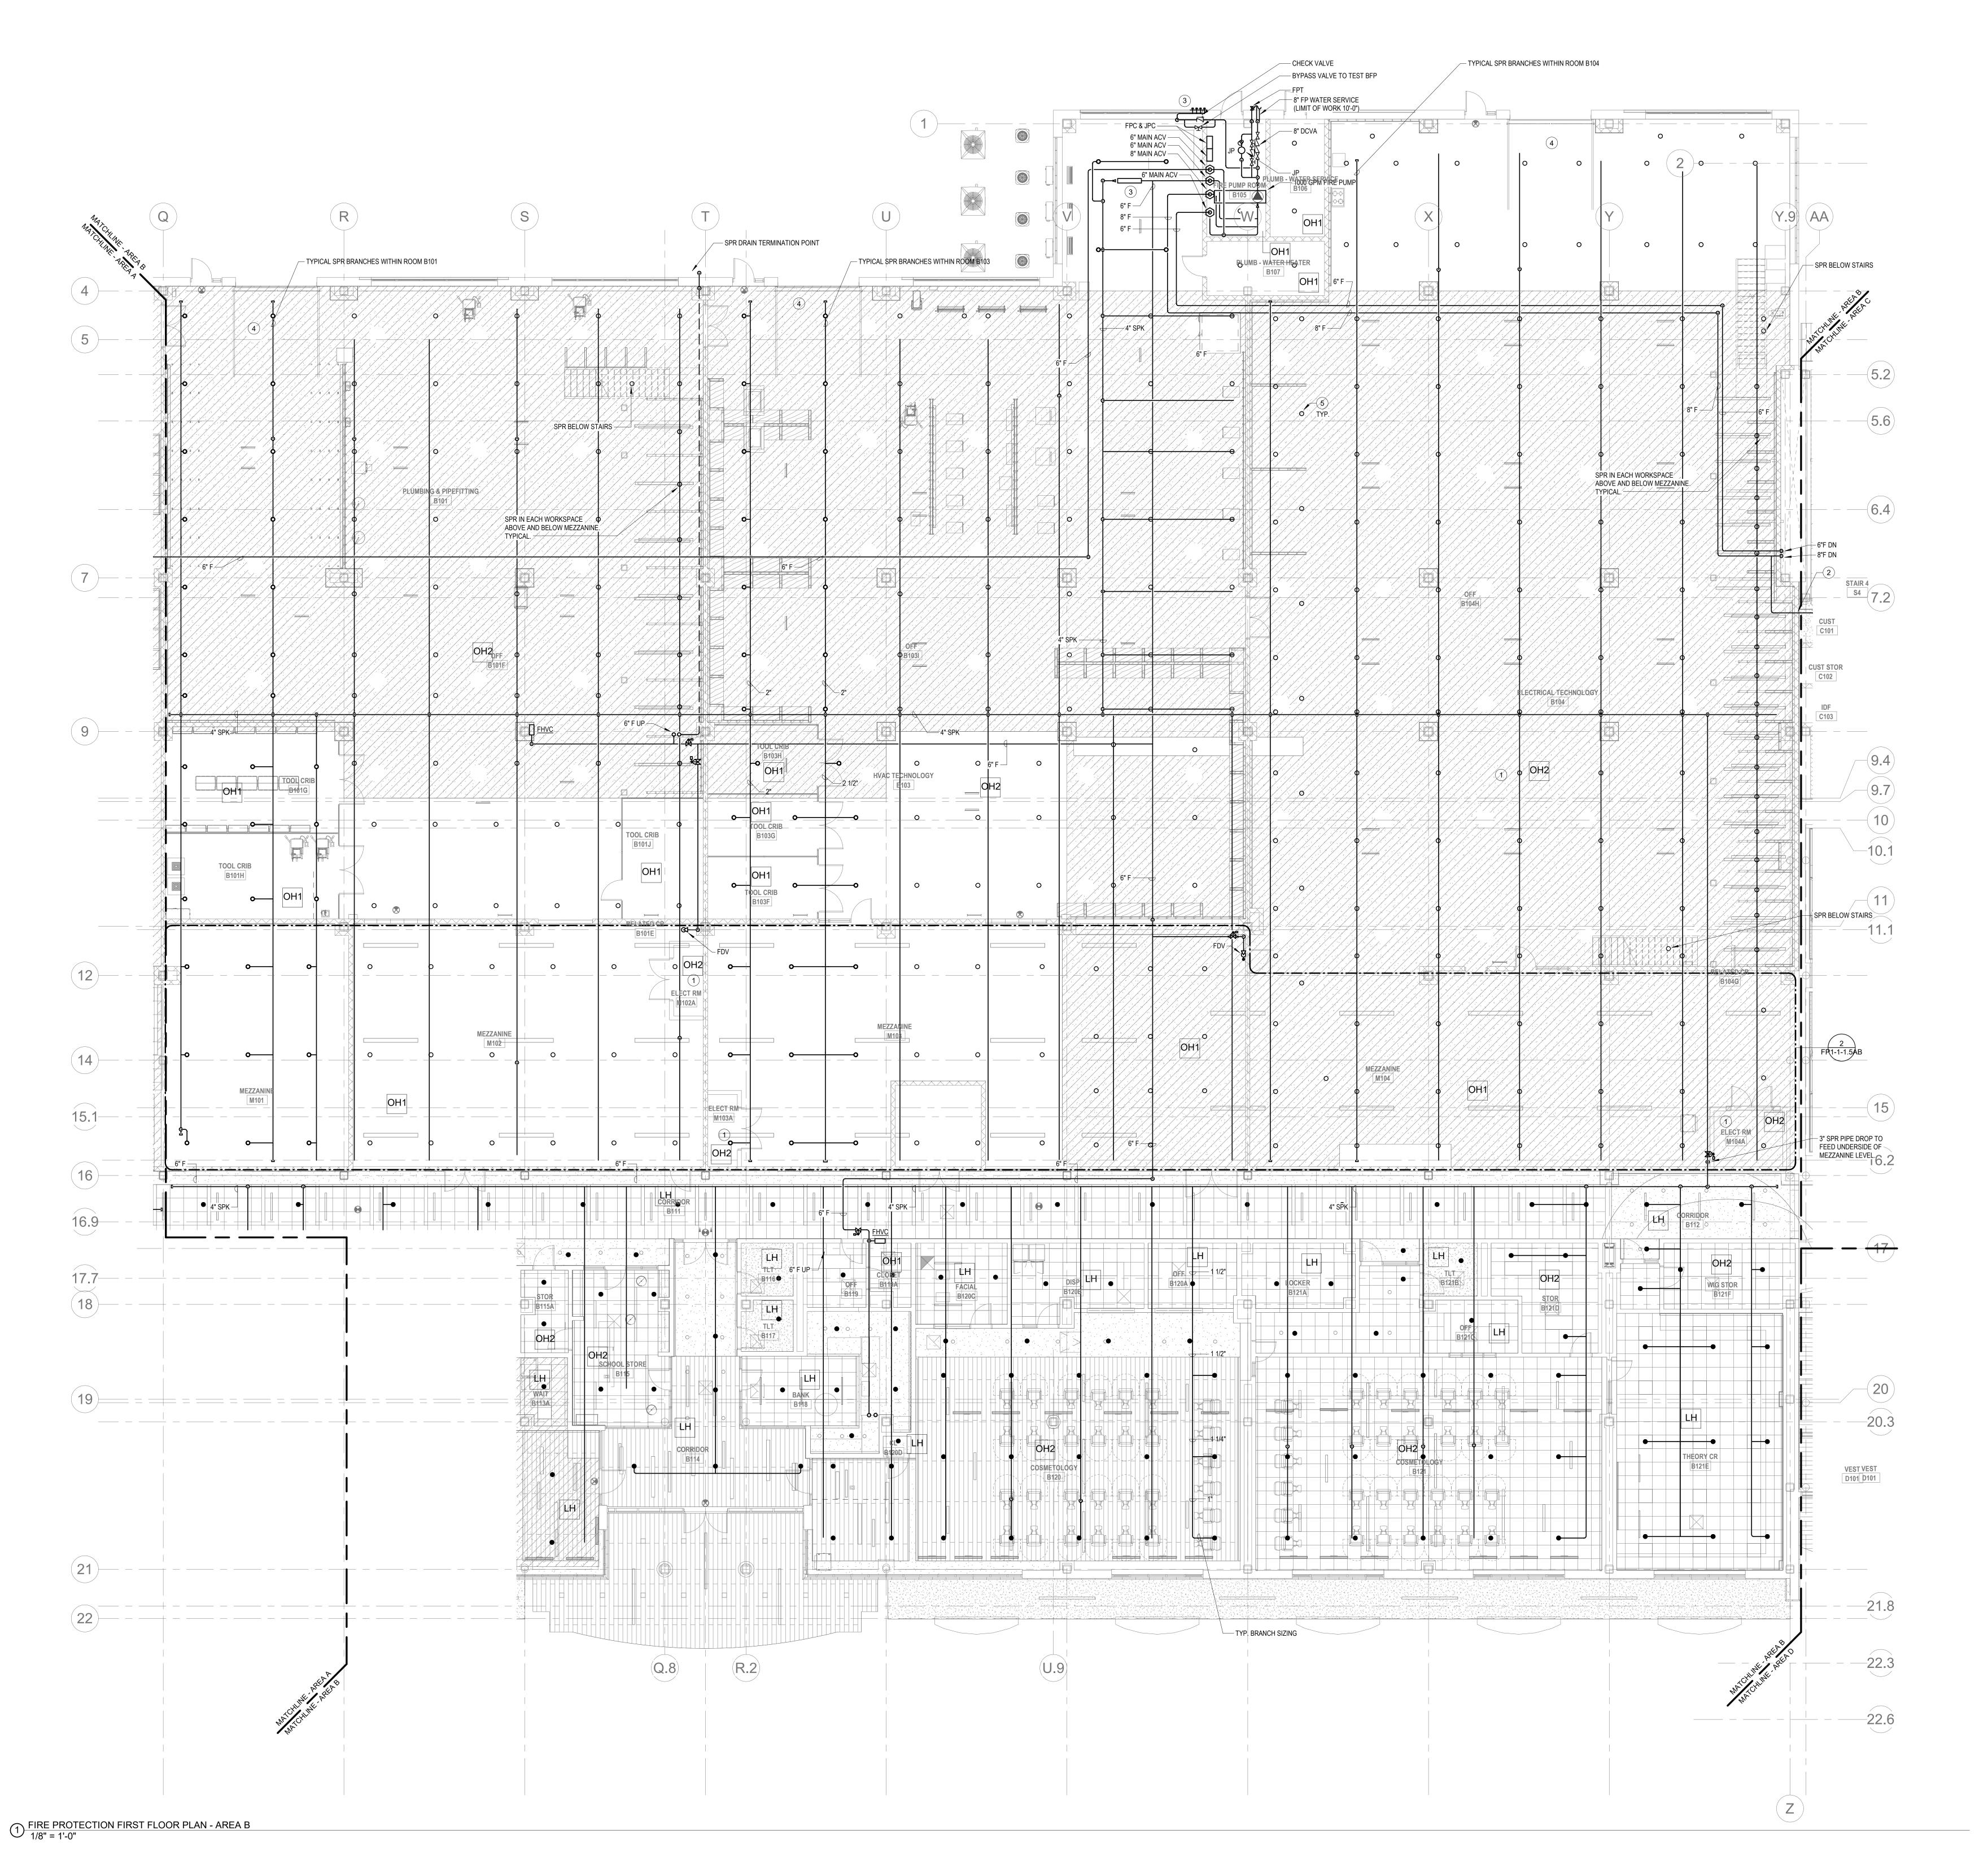

- LH LIGHT HAZARD OCCUPANCY
- OH ORDINARY HAZARD OCCUPANCY
- EH EXTRA HAZARD OCCUPANCY
- (1) FINAL LOCATION OF ALL PIPING AND SPRINKLER HEADS IN ELECTRIC TYPE SPACES AND UTILITY ROOMS SHALL BE FIELD COORDINATED WITH ELECTRICAL CONTRACTOR AS TO VERIFY COMPLIANCE WITH ELECTRICAL
- (2) FOR ALL PIPING PASSING THROUGH COORDINATE Y9, PROVIDE AN EXPANSION LOOP AND ADD FLEXIBLE COUPLINGS ON EITHER SIDE.
- 3) PROVIDE FLOOR CONTROL VALVE. THE FLOOR CONTROL VALVE ASSEMBLY SHALL CONSIST OF A BUTTERFLY VALVE, CHECK VALVE, FLOW SWITCH, PRESSURE GAUGE AND MAIN DRAIN VALVE WITH INSPECTOR'S TEST CONNECTION. (AS REQUIRED PER DETAIL)
- (4) PROVIDE DRY PENDENTS WITH GUARDS BENEATH THE GARAGE DOOR 5 PROVIDE SPRINKLER UNDERSIDE OF DUCTWORK. FIELD COORDINATE.

GENERAL NOTES

- 1. WITHIN AREA OF SCOPE EXTEND NEW 4" SPRINKLER MAIN PIPING FROM A NEW ZONE CONTROL VALVE. CONTRACTOR SHALL SIZE BRANCH PIPING TO ALLOW FOR VELOCITY WILL REMAIN BELOW 20 FPS. PROVIDE QUICK RESPONSE UPRIGHTS IN OPEN CEILING AREAS AND CONCEALED PENDENTS IN AREAS WHERE DROP CEILINGS ARE INDICATED. EXTEND NEW 1" ARMOVERS TO NEW CONCEALED PENDENTS. 1" SPRIGS SHALL BE ROUTED TO UPRIGHTS WITHIN 12" OF DECK. DESIGN INTENT IS TO PROVIDE A CODE COMPLIANT SPRINKLER LAYOUT FOR THE NEW PROGRAM LAYOUT. CONTRACTOR IS REQUIRE TO SUBMIT HYDRAULIC CALCULATIONS TERMINATED AT THE HYDRANT OUTLET.
- 2. PROVIDE PROTECTIVE SPRINKLER GUARDS ON SPRINKLER HEADS LOCATED BELOW 7'-0" A.F.F. IN MECHANICAL ROOMS, STORAGE ROOMS, PUMP ROOMS, SERVICE AREAS, GYMNASIUMS REGARDLESS OF SPRINKLER HEAD ELEVATION AND WHERE OTHERWISE SUSCEPTIBLE TO DAMAGE.
- SPRINKLERS SHALL BE PROVIDED WITH MAXIMUM SPACING OF 6 FEET NEAR STAIR FLOOR OPENINGS.
- 4. SPRINKELRS SHALL BE PROVIDED BENEATH MECHANICAL DUCTWORK AND/OR GROUPS OF MECHANICAL DUCTWORK GREATER THAN 4 FT IN WIDTH. WHERE DUCTWORK INTERFERE WITH SPRINKLERS, ADDITIONAL COVERAGE SHALL BE PROVIDED IN ACCORDANCE WITH NFPA 13
- 5. CONCEALED SPRNKLER HEAD FINISHES TO MATCH CEILING COLOR. UNLESS OTHERWISE NOTED REFER TO ARCHITECTURAL DRAWINGS. 6. SPRINKLERS SHALL BE PROVIDED BENEATH ACCESSIBLE LANDINGS. PIPING AND FITTINGS SHALL BE PROVIDED TO SPRINKLERS BENEATH ACCESSIBLE LANDINGS AND AT MAIN LANDING. LOCATION OF ALL EXPOSED PIPING SHALL BE FIELD COORDINATED WITH
- 7. DRY PENDENTS AND/OR DRY SIDEWALLS SHALL BE PROVIDED IN ROOMS/AREAS WHERE THE OPERATING TEMPERATURE IS LESS THAN 40F.
- 8. SPRINKLERS SHALL BE PROVIED BENEATH FIXTURES GREATER THAN 4 FT IN WIDTH.



Drummey Rosane Anderson, Inc. 225 Oakland Road 260 Charles Street Studio 205 Studio 300 South Windsor, CT Waltham, MA

06074 Planning | Architecture | Interior Design Tel: 617.964.1700 www.draws.com

Northeast Metropolitan Regional Vocational High


Wakefield, MA 01880

BALLA ENGINEERS MECHANICAL | ELECTRICAL | PLUMBING | FIRE PROTECTION STRUCTURAL | TECHNOLOGY | COMMISSIONING


January 13, 2023

MSBA 60% CD


SUBMISSION

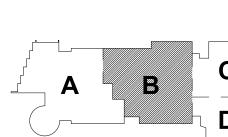

KEY PLAN

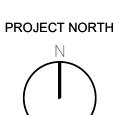

PROTECTION FIRST FLOOR PLAN - AREA B

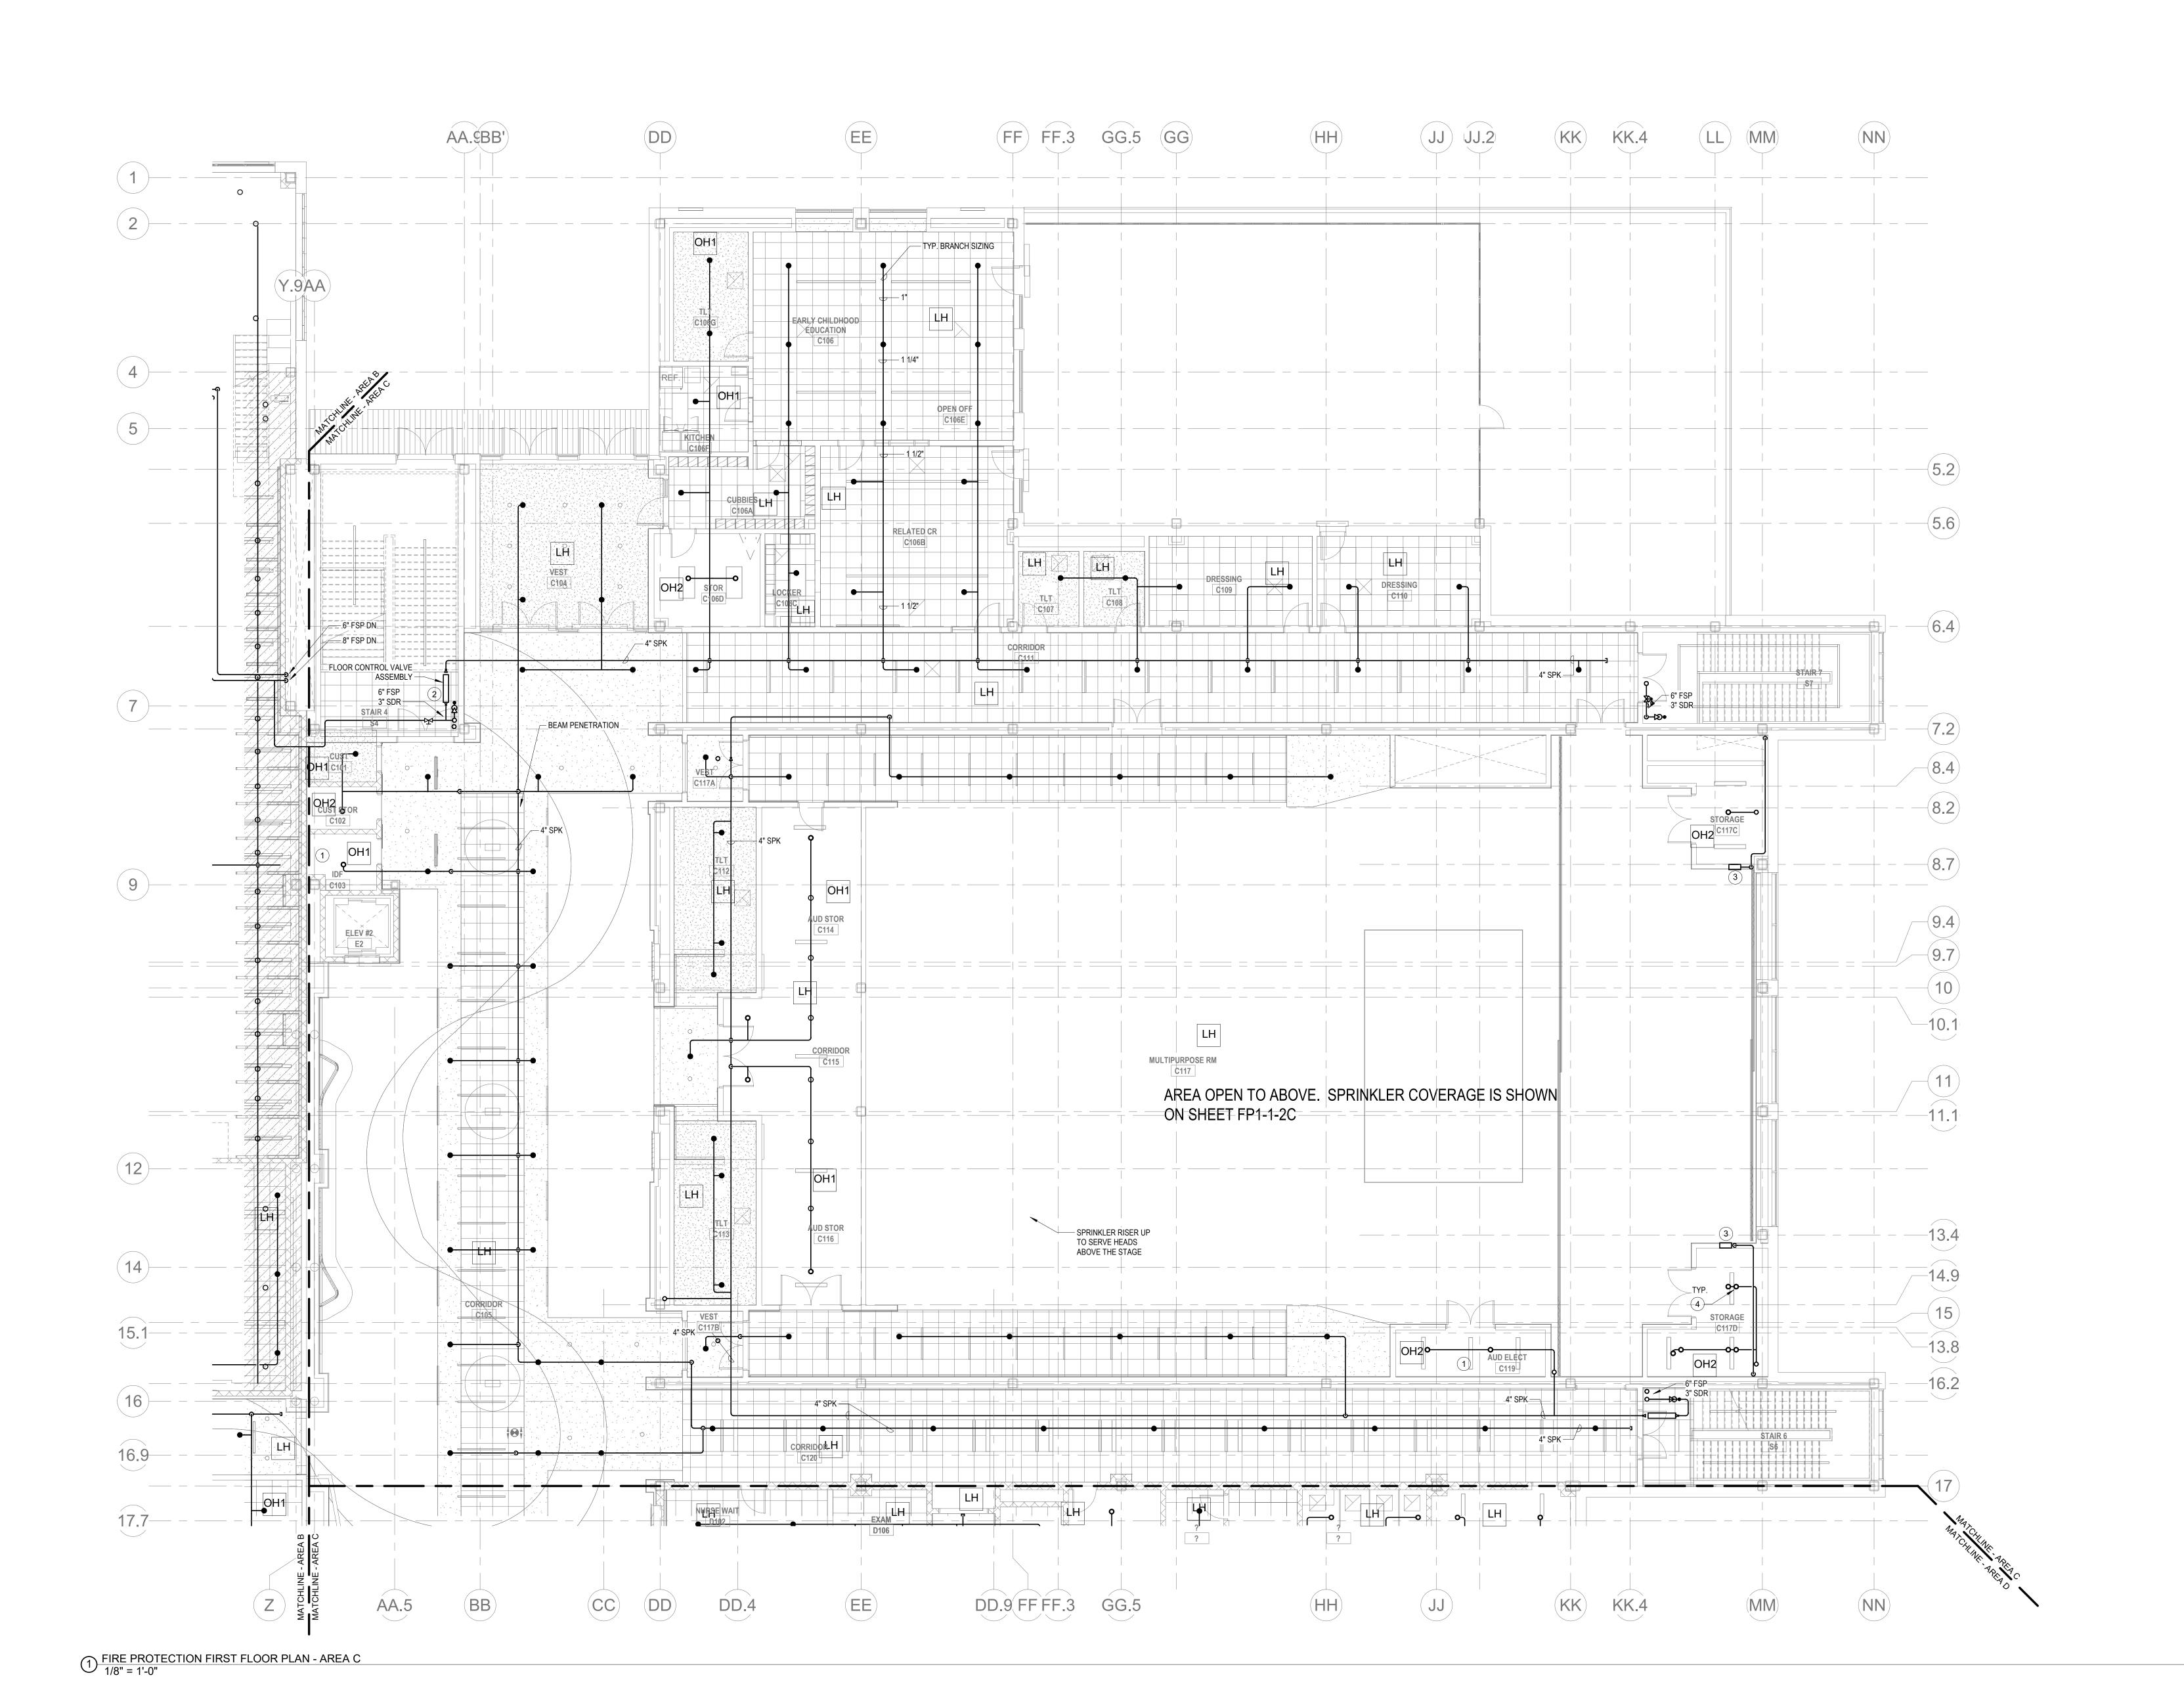

LH LIGHT HAZARD OCCUPANCY

OH ORDINARY HAZARD OCCUPANCY

EH EXTRA HAZARD OCCUPANCY

FLOOR OPENINGS.

(1) FINAL LOCATION OF ALL PIPING AND SPRINKLER HEADS IN ELECTRIC TYPE SPACES AND UTILITY ROOMS SHALL BE FIELD COORDINATED WITH ELECTRICAL CONTRACTOR AS TO VERIFY COMPLIANCE WITH ELECTRICAL

- PROVIDE FLOOR CONTROL VALVE. THE FLOOR CONTROL VALVE ASSEMBLY SHALL CONSIST OF A BUTTERFLY VALVE, CHECK VALVE, FLOW SWITCH, PRESSURE GAUGE AND MAIN DRAIN VALVE WITH INSPECTOR'S TEST CONNECTION. (AS REQUIRED PER DETAIL)
- 3) PROVIDE A FIRE HOSE VALVE CABINET ON EACH SIDE OF THE STAGE IN ACCORDANCE WITH 780 CMR 905.3.4.
- PROVIDE SPRINKLER UNDERSIDE OF DUCTWORK. FIELD COORDINATE.

GENERAL NOTES

- 1. WITHIN AREA OF SCOPE EXTEND NEW 4" SPRINKLER MAIN PIPING FROM A NEW ZONE CONTROL VALVE. CONTRACTOR SHALL SIZE BRANCH PIPING TO ALLOW FOR VELOCITY WILL REMAIN BELOW 20 FPS. PROVIDE QUICK RESPONSE UPRIGHTS IN OPEN CEILING AREAS AND CONCEALED PENDENTS IN AREAS WHERE DROP CEILINGS ARE INDICATED. EXTEND NEW 1" ARMOVERS TO NEW CONCEALED PENDENTS. 1" SPRIGS SHALL BE ROUTED TO UPRIGHTS WITHIN 12" OF DECK. DESIGN INTENT IS TO PROVIDE A CODE COMPLIANT SPRINKLER LAYOUT FOR THE NEW PROGRAM LAYOUT. CONTRACTOR IS REQUIRE TO SUBMIT HYDRAULIC CALCULATIONS TERMINATED AT THE HYDRANT OUTLET. 2. PROVIDE PROTECTIVE SPRINKLER GUARDS ON SPRINKLER HEADS LOCATED BELOW 7'-0"
- GYMNASIUMS REGARDLESS OF SPRINKLER HEAD ELEVATION AND WHERE OTHERWISE SUSCEPTIBLE TO DAMAGE. 3. SPRINKLERS SHALL BE PROVIDED WITH MAXIMUM SPACING OF 6 FEET NEAR STAIR

A.F.F. IN MECHANICAL ROOMS, STORAGE ROOMS, PUMP ROOMS, SERVICE AREAS,

- 4. SPRINKELRS SHALL BE PROVIDED BENEATH MECHANICAL DUCTWORK AND/OR GROUPS OF MECHANICAL DUCTWORK GREATER THAN 4 FT IN WIDTH. WHERE DUCTWORK INTERFERE WITH SPRINKLERS, ADDITIONAL COVERAGE SHALL BE PROVIDED IN ACCORDANCE WITH NFPA 13
- 5. CONCEALED SPRNKLER HEAD FINISHES TO MATCH CEILING COLOR. UNLESS OTHERWISE NOTED REFER TO ARCHITECTURAL DRAWINGS.
- 6. SPRINKLERS SHALL BE PROVIDED BENEATH ACCESSIBLE LANDINGS. PIPING AND FITTINGS SHALL BE PROVIDED TO SPRINKLERS BENEATH ACCESSIBLE LANDINGS AND AT MAIN LANDING. LOCATION OF ALL EXPOSED PIPING SHALL BE FIELD COORDINATED WITH
- 7. DRY PENDENTS AND/OR DRY SIDEWALLS SHALL BE PROVIDED IN ROOMS/AREAS WHERE THE OPERATING TEMPERATURE IS LESS THAN 40F.
- 8. SPRINKLERS SHALL BE PROVIED BENEATH FIXTURES GREATER THAN 4 FT IN WIDTH.



Drummey Rosane Anderson, Inc. 225 Oakland Road 260 Charles Street Studio 205 Studio 300 South Windsor, CT Waltham, MA

06074 02453 Planning | Architecture | Interior Design Tel: 617.964.1700 www.draws.com

Northeast Metropolitan Regional Vocational High


Wakefield, MA 01880

PHILADELPHIA | NEW YORK | BOSTON | BALTIMORE | WASHINGTON, DC MECHANICAL | ELECTRICAL | PLUMBING | FIRE PROTECTION STRUCTURAL | TECHNOLOGY | COMMISSIONING

SUBMISSION January 13, 2023

MSBA 60% CD



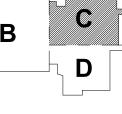


KEY PLAN

MAGNETIC NORTH

PROJECT NORTH

PROTECTION FIRST FLOOR PLAN - AREA C

FP1-1-1C

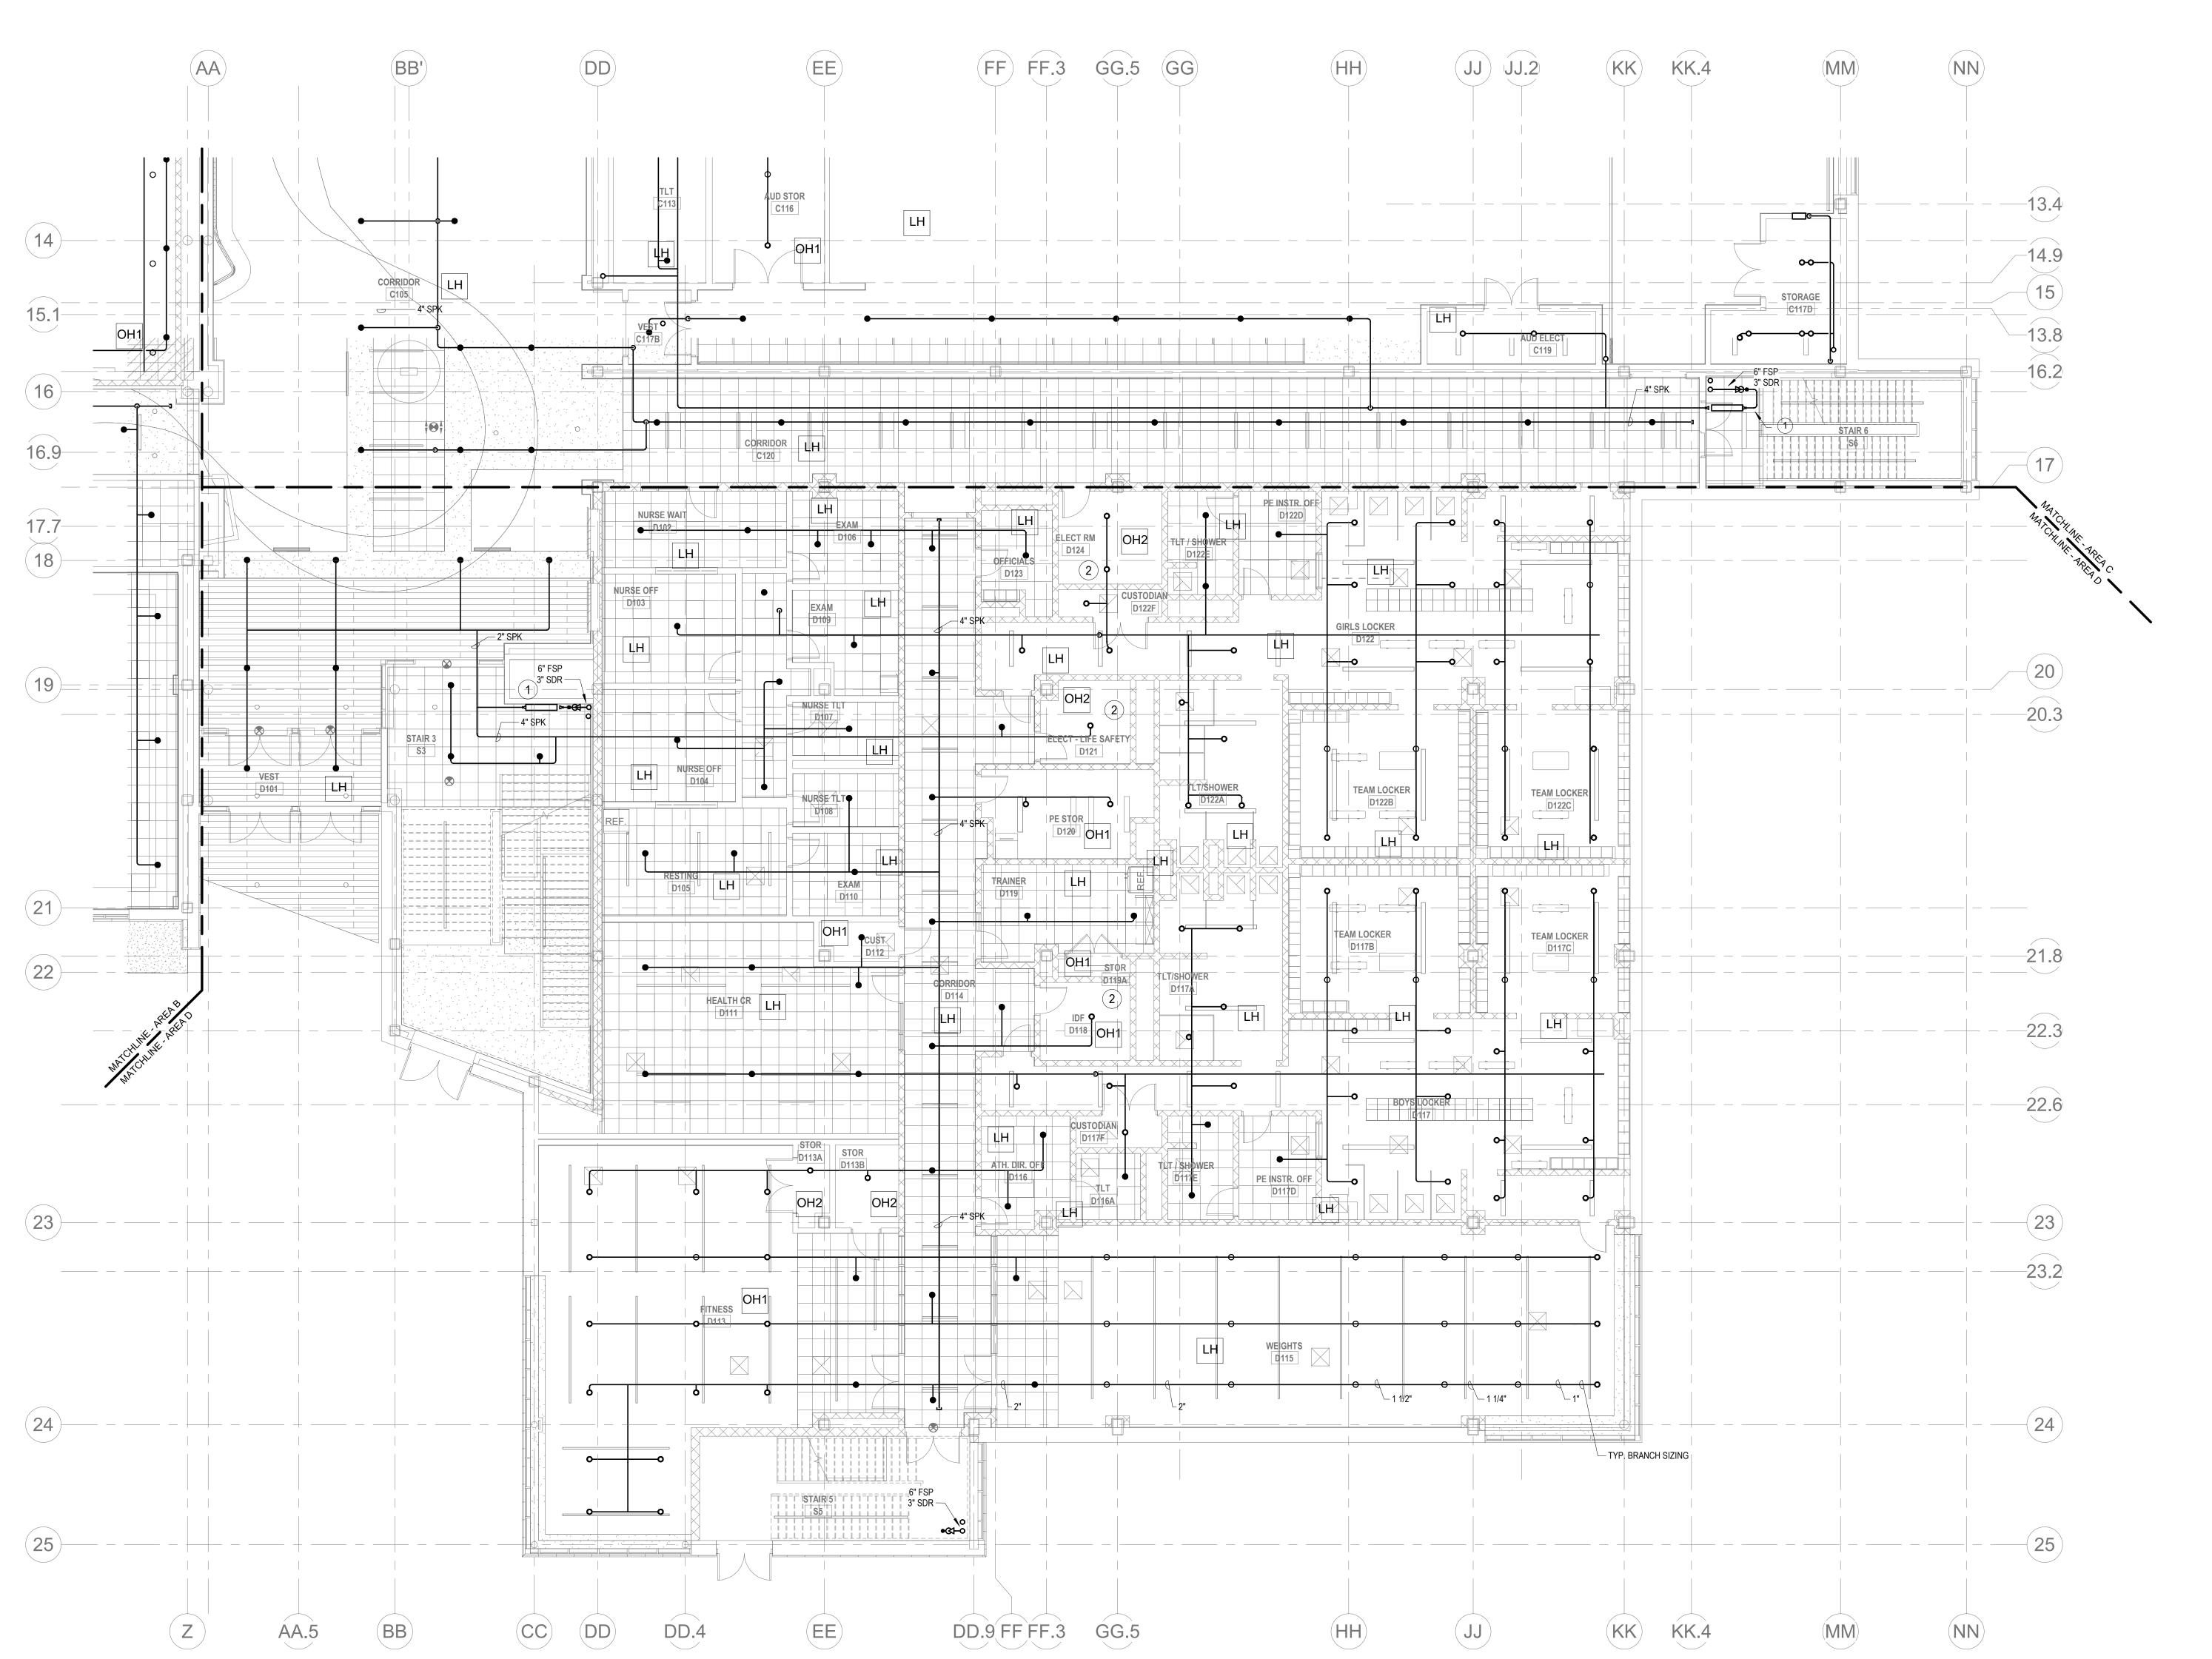

1) FIRE PROTECTION FIRST FLOOR PLAN - AREA D 1/8" = 1'-0"

KEYNOTES

- LH LIGHT HAZARD OCCUPANCY
- OH ORDINARY HAZARD OCCUPANCY
- EH EXTRA HAZARD OCCUPANCY
- (1) PROVIDE FLOOR CONTROL VALVE. THE FLOOR CONTROL VALVE
- SWITCH, PRESSURE GAUGE AND MAIN DRAIN VALVE WITH INSPECTOR'S TEST CONNECTION. (AS REQUIRED PER DETAIL) (2) FINAL LOCATION OF ALL PIPING AND SPRINKLER HEADS IN ELECTRIC TYPE

ASSEMBLY SHALL CONSIST OF A BUTTERFLY VALVE, CHECK VALVE, FLOW

SPACES AND UTILITY ROOMS SHALL BE FIELD COORDINATED WITH ELECTRICAL CONTRACTOR AS TO VERIFY COMPLIANCE WITH ELECTRICAL

GENERAL NOTES

- 1. WITHIN AREA OF SCOPE EXTEND NEW 4" SPRINKLER MAIN PIPING FROM A NEW ZONE CONTROL VALVE. CONTRACTOR SHALL SIZE BRANCH PIPING TO ALLOW FOR VELOCITY WILL REMAIN BELOW 20 FPS. PROVIDE QUICK RESPONSE UPRIGHTS IN OPEN CEILING AREAS AND CONCEALED PENDENTS IN AREAS WHERE DROP CEILINGS ARE INDICATED. EXTEND NEW 1" ARMOVERS TO NEW CONCEALED PENDENTS. 1" SPRIGS SHALL BE ROUTED TO UPRIGHTS WITHIN 12" OF DECK. DESIGN INTENT IS TO PROVIDE A CODE COMPLIANT SPRINKLER LAYOUT FOR THE NEW PROGRAM LAYOUT. CONTRACTOR IS REQUIRE TO SUBMIT HYDRAULIC CALCULATIONS TERMINATED AT THE HYDRANT OUTLET.
- 2. PROVIDE PROTECTIVE SPRINKLER GUARDS ON SPRINKLER HEADS LOCATED BELOW 7'-0" A.F.F. IN MECHANICAL ROOMS, STORAGE ROOMS, PUMP ROOMS, SERVICE AREAS, GYMNASIUMS REGARDLESS OF SPRINKLER HEAD ELEVATION AND WHERE OTHERWISE SUSCEPTIBLE TO DAMAGE.
- 3. SPRINKLERS SHALL BE PROVIDED WITH MAXIMUM SPACING OF 6 FEET NEAR STAIR FLOOR OPENINGS.
- 4. SPRINKELRS SHALL BE PROVIDED BENEATH MECHANICAL DUCTWORK AND/OR GROUPS OF MECHANICAL DUCTWORK GREATER THAN 4 FT IN WIDTH. WHERE DUCTWORK INTERFERE WITH SPRINKLERS, ADDITIONAL COVERAGE SHALL BE PROVIDED IN ACCORDANCE WITH NFPA 13
- 5. CONCEALED SPRNKLER HEAD FINISHES TO MATCH CEILING COLOR. UNLESS OTHERWISE NOTED REFER TO ARCHITECTURAL DRAWINGS. 6. SPRINKLERS SHALL BE PROVIDED BENEATH ACCESSIBLE LANDINGS. PIPING AND FITTINGS SHALL BE PROVIDED TO SPRINKLERS BENEATH ACCESSIBLE LANDINGS AND AT MAIN LANDING. LOCATION OF ALL EXPOSED PIPING SHALL BE FIELD COORDINATED WITH ARCHITECT.
- 7. DRY PENDENTS AND/OR DRY SIDEWALLS SHALL BE PROVIDED IN ROOMS/AREAS WHERE THE OPERATING TEMPERATURE IS LESS THAN 40F.
- 8. SPRINKLERS SHALL BE PROVIED BENEATH FIXTURES GREATER THAN 4 FT IN WIDTH.



Drummey Rosane Anderson, Inc. 225 Oakland Road 260 Charles Street Studio 205 South Windsor, CT Waltham, MA

06074 02453 Planning | Architecture | Interior Design Tel: 617.964.1700 www.draws.com

Studio 300


Northeast Metropolitan Regional Vocational High School

Wakefield, MA 01880

BALLA ENGINEERS PHLADELPHA | NEW YORK | BOSTON | BALTMORE | WASHINGTON, DC MECHANICAL | ELECTRICAL | PLUMBING | FIRE PROTECTION STRUCTURAL | TECHNOLOGY | COMMISSIONING


MSBA 60% CD SUBMISSION

January 13, 2023

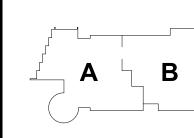

KEY PLAN


MAGNETIC NORTH

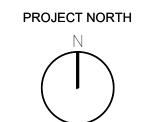

PROTECTION FIRST FLOOR PLAN - AREA D

Drawn By: DRA

FP1-1-1D

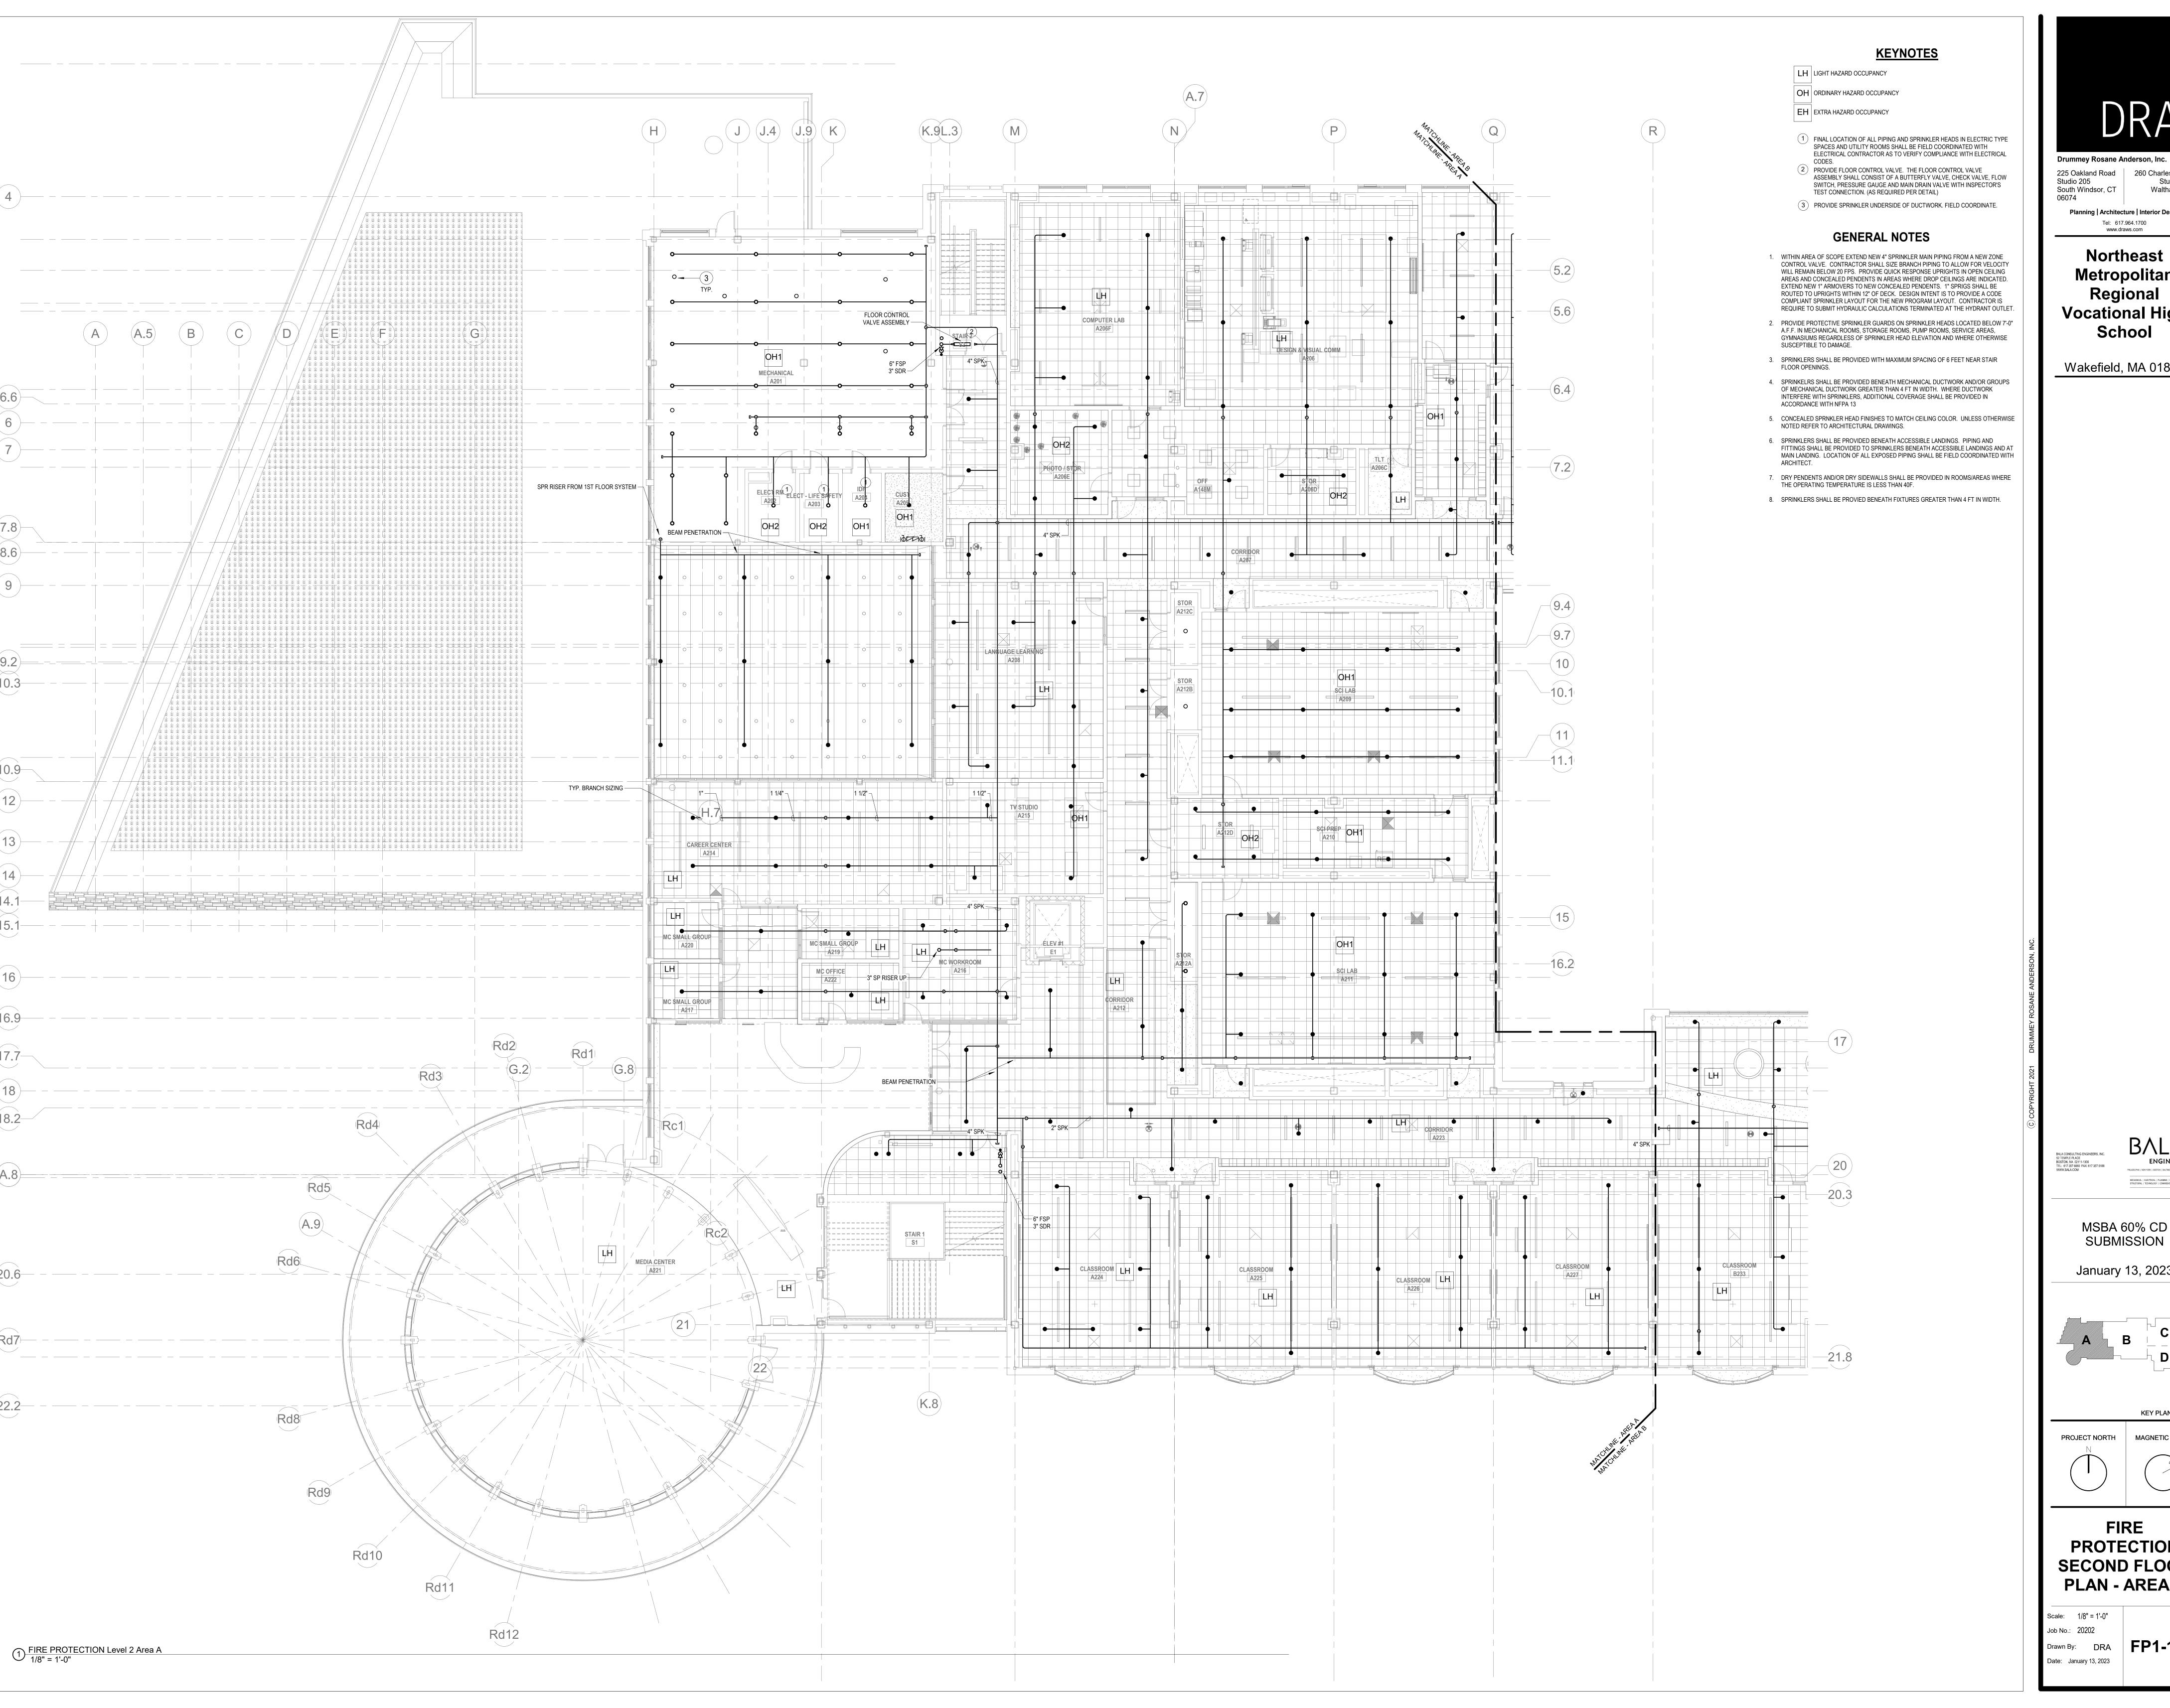



Drummey Rosane Anderson, Inc. 225 Oakland Road 260 Charles Street Studio 300 South Windsor, CT Waltham, MA

Planning | Architecture | Interior Design Tel: 617.964.1700 www.draws.com


Northeast Metropolitan Regional Vocational High

Wakefield, MA 01880


MECHANICAL | ELECTRICAL | PLUMBING | FIRE PROTECTION STRUCTURAL | TECHNOLOGY | COMMISSIONING

PHLADELPHIA | NEW YORK | BOSTON | BALTIMORE | WASHINGTON, DC

January 13, 2023

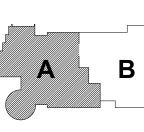


KEY PLAN MAGNETIC NORTH

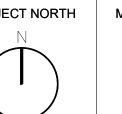

PROTECTION SECOND FLOOR PLAN - AREA A

FP1-1-2A

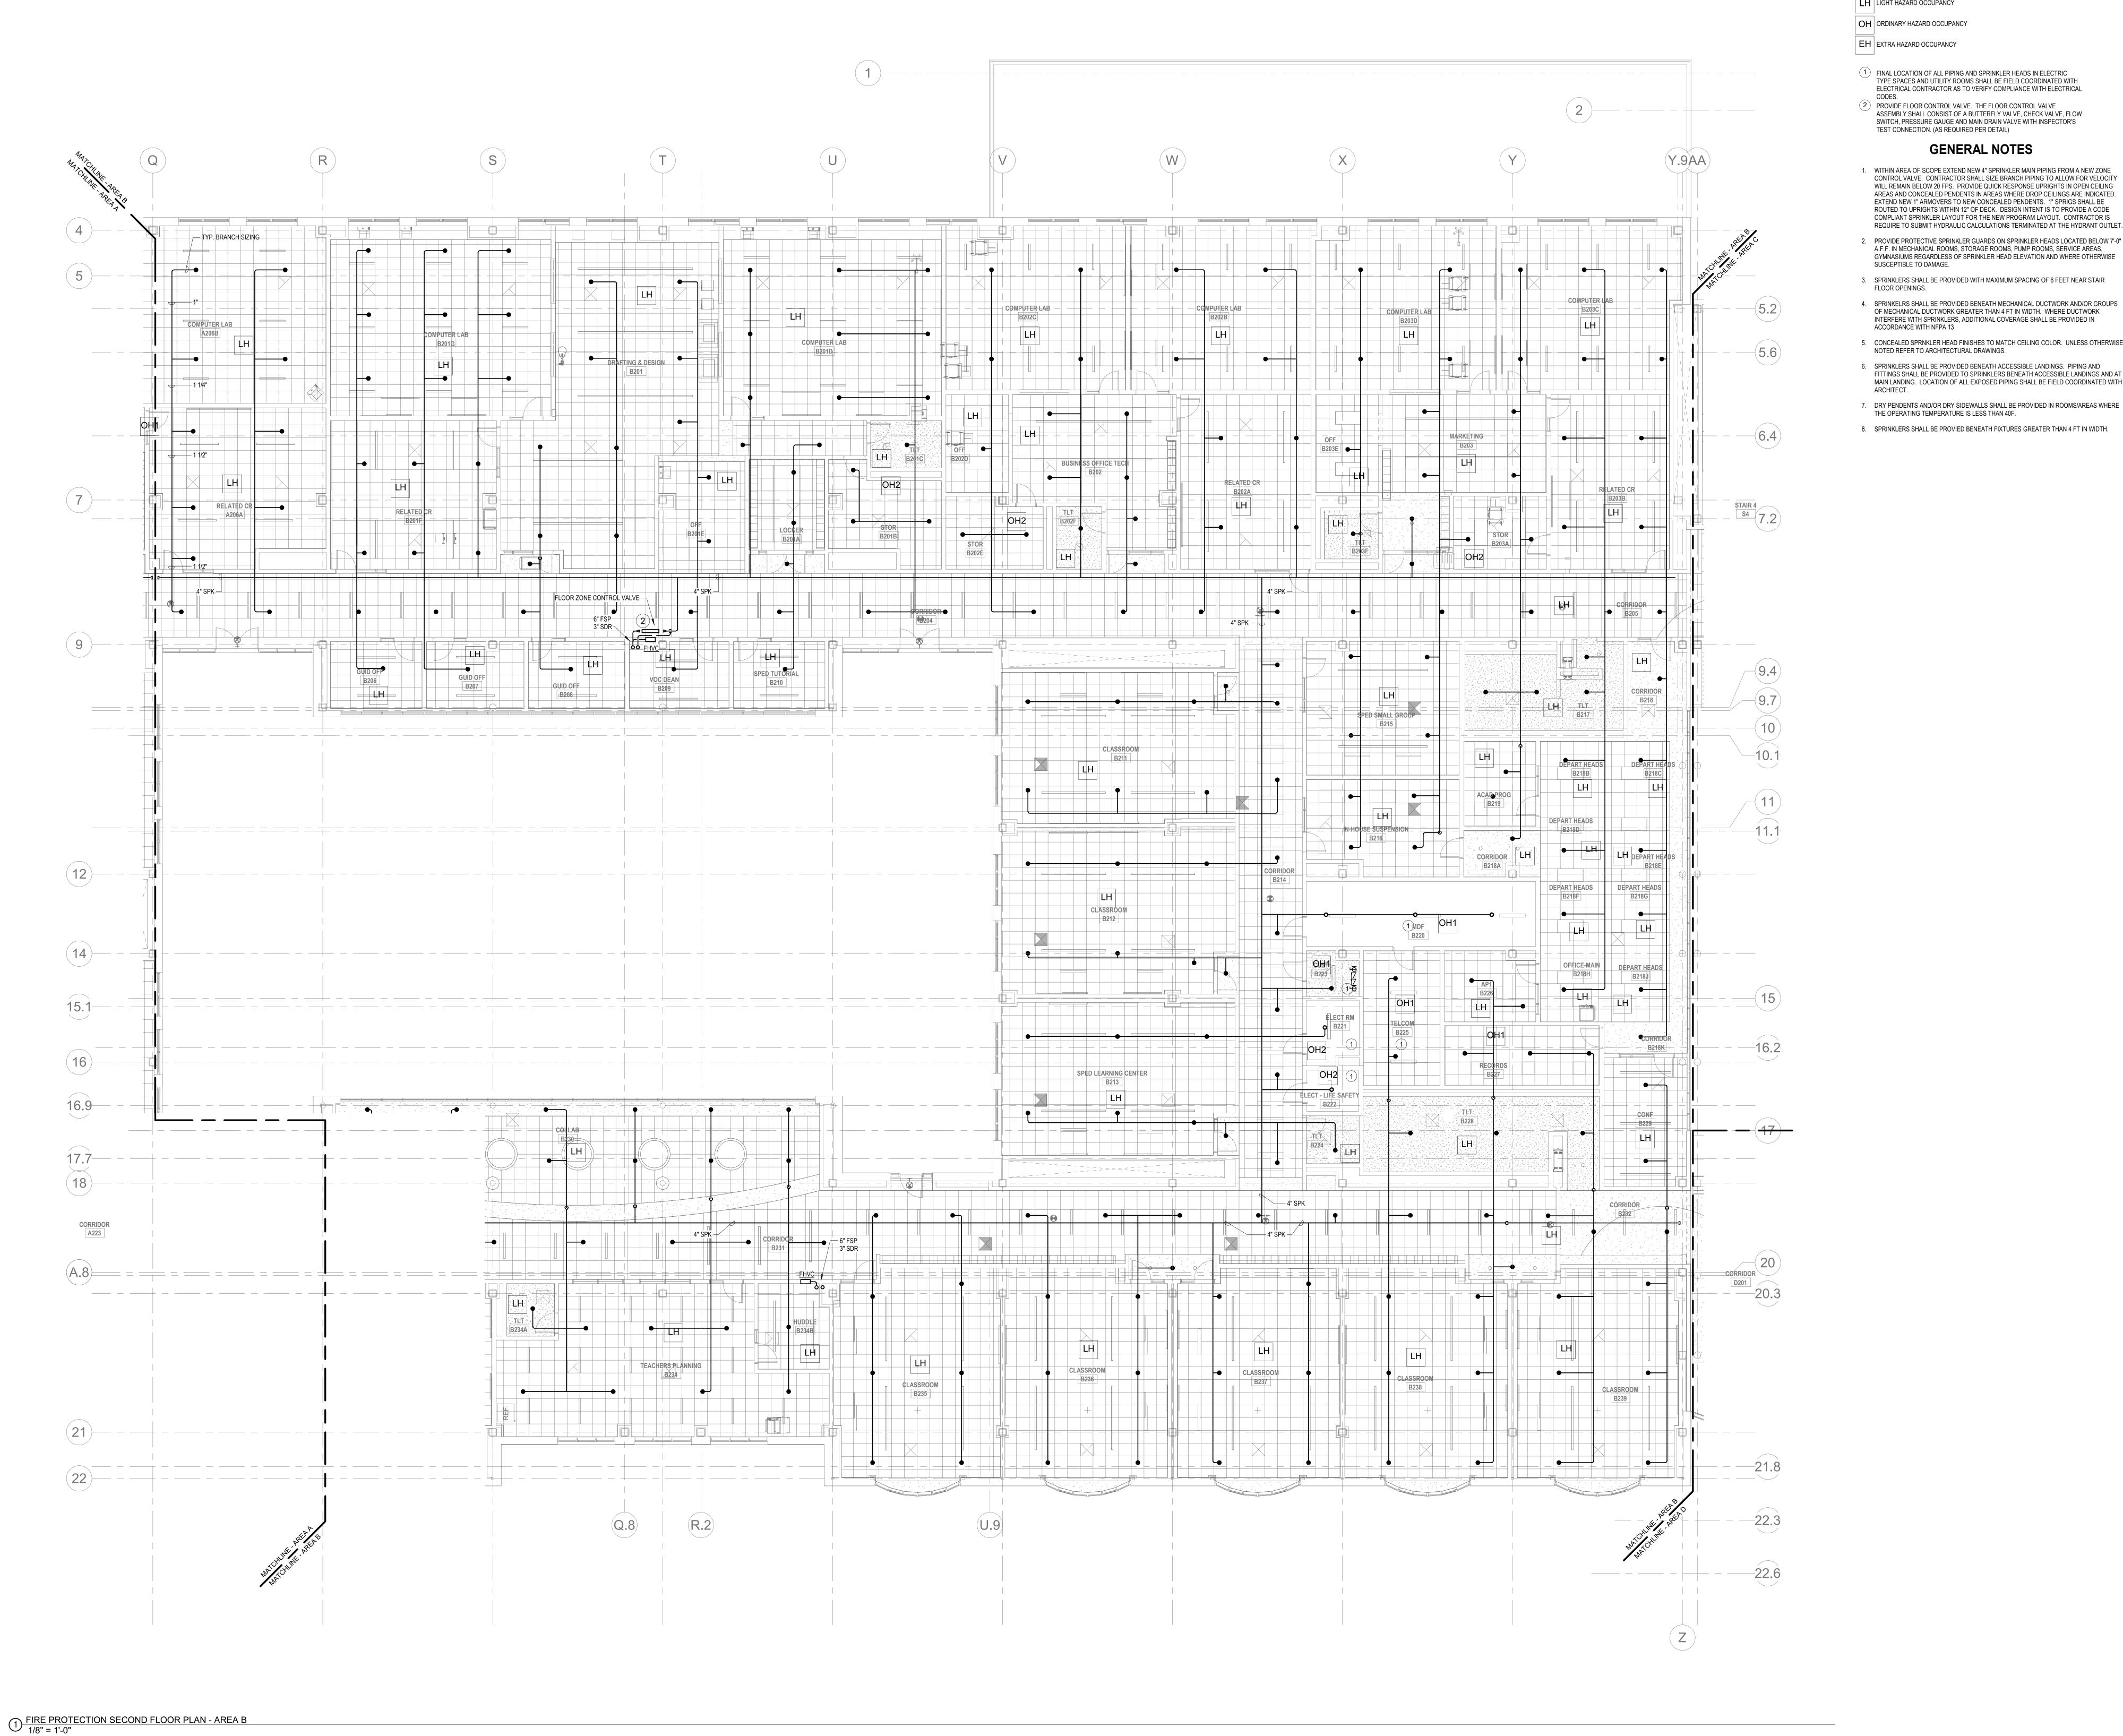

- LH LIGHT HAZARD OCCUPANCY
- OH ORDINARY HAZARD OCCUPANCY
- EH EXTRA HAZARD OCCUPANCY
- 1 FINAL LOCATION OF ALL PIPING AND SPRINKLER HEADS IN ELECTRIC TYPE SPACES AND UTILITY ROOMS SHALL BE FIELD COORDINATED WITH ELECTRICAL CONTRACTOR AS TO VERIFY COMPLIANCE WITH ELECTRICAL CODES. (2) PROVIDE FLOOR CONTROL VALVE. THE FLOOR CONTROL VALVE

ASSEMBLY SHALL CONSIST OF A BUTTERFLY VALVE, CHECK VALVE, FLOW SWITCH, PRESSURE GAUGE AND MAIN DRAIN VALVE WITH INSPECTOR'S TEST CONNECTION. (AS REQUIRED PER DETAIL)

1. WITHIN AREA OF SCOPE EXTEND NEW 4" SPRINKLER MAIN PIPING FROM A NEW ZONE CONTROL VALVE. CONTRACTOR SHALL SIZE BRANCH PIPING TO ALLOW FOR VELOCITY WILL REMAIN BELOW 20 FPS. PROVIDE QUICK RESPONSE UPRIGHTS IN OPEN CEILING AREAS AND CONCEALED PENDENTS IN AREAS WHERE DROP CEILINGS ARE INDICATED.

EXTEND NEW 1" ARMOVERS TO NEW CONCEALED PENDENTS. 1" SPRIGS SHALL BE ROUTED TO UPRIGHTS WITHIN 12" OF DECK. DESIGN INTENT IS TO PROVIDE A CODE COMPLIANT SPRINKLER LAYOUT FOR THE NEW PROGRAM LAYOUT. CONTRACTOR IS REQUIRE TO SUBMIT HYDRAULIC CALCULATIONS TERMINATED AT THE HYDRANT OUTLET.

GENERAL NOTES

- A.F.F. IN MECHANICAL ROOMS, STORAGE ROOMS, PUMP ROOMS, SERVICE AREAS, GYMNASIUMS REGARDLESS OF SPRINKLER HEAD ELEVATION AND WHERE OTHERWISE SUSCEPTIBLE TO DAMAGE.
- 3. SPRINKLERS SHALL BE PROVIDED WITH MAXIMUM SPACING OF 6 FEET NEAR STAIR FLOOR OPENINGS. 4. SPRINKELRS SHALL BE PROVIDED BENEATH MECHANICAL DUCTWORK AND/OR GROUPS OF MECHANICAL DUCTWORK GREATER THAN 4 FT IN WIDTH. WHERE DUCTWORK INTERFERE WITH SPRINKLERS, ADDITIONAL COVERAGE SHALL BE PROVIDED IN
- 5. CONCEALED SPRNKLER HEAD FINISHES TO MATCH CEILING COLOR. UNLESS OTHERWISE NOTED REFER TO ARCHITECTURAL DRAWINGS.
- 6. SPRINKLERS SHALL BE PROVIDED BENEATH ACCESSIBLE LANDINGS. PIPING AND FITTINGS SHALL BE PROVIDED TO SPRINKLERS BENEATH ACCESSIBLE LANDINGS AND AT MAIN LANDING. LOCATION OF ALL EXPOSED PIPING SHALL BE FIELD COORDINATED WITH
- 7. DRY PENDENTS AND/OR DRY SIDEWALLS SHALL BE PROVIDED IN ROOMS/AREAS WHERE THE OPERATING TEMPERATURE IS LESS THAN 40F.
- 8. SPRINKLERS SHALL BE PROVIED BENEATH FIXTURES GREATER THAN 4 FT IN WIDTH.



Drummey Rosane Anderson, Inc. 225 Oakland Road 260 Charles Street Studio 205 Studio 300 South Windsor, CT Waltham, MA


06074 Planning | Architecture | Interior Design Tel: 617.964.1700 www.draws.com

Northeast Metropolitan Regional Vocational High

Wakefield, MA 01880


SUBMISSION January 13, 2023

MSBA 60% CD

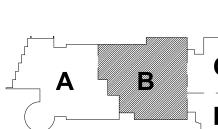


KEY PLAN

MAGNETIC NORTH

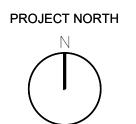

PROTECTION SECOND FLOOR PLAN - AREA B

FP1-1-2B

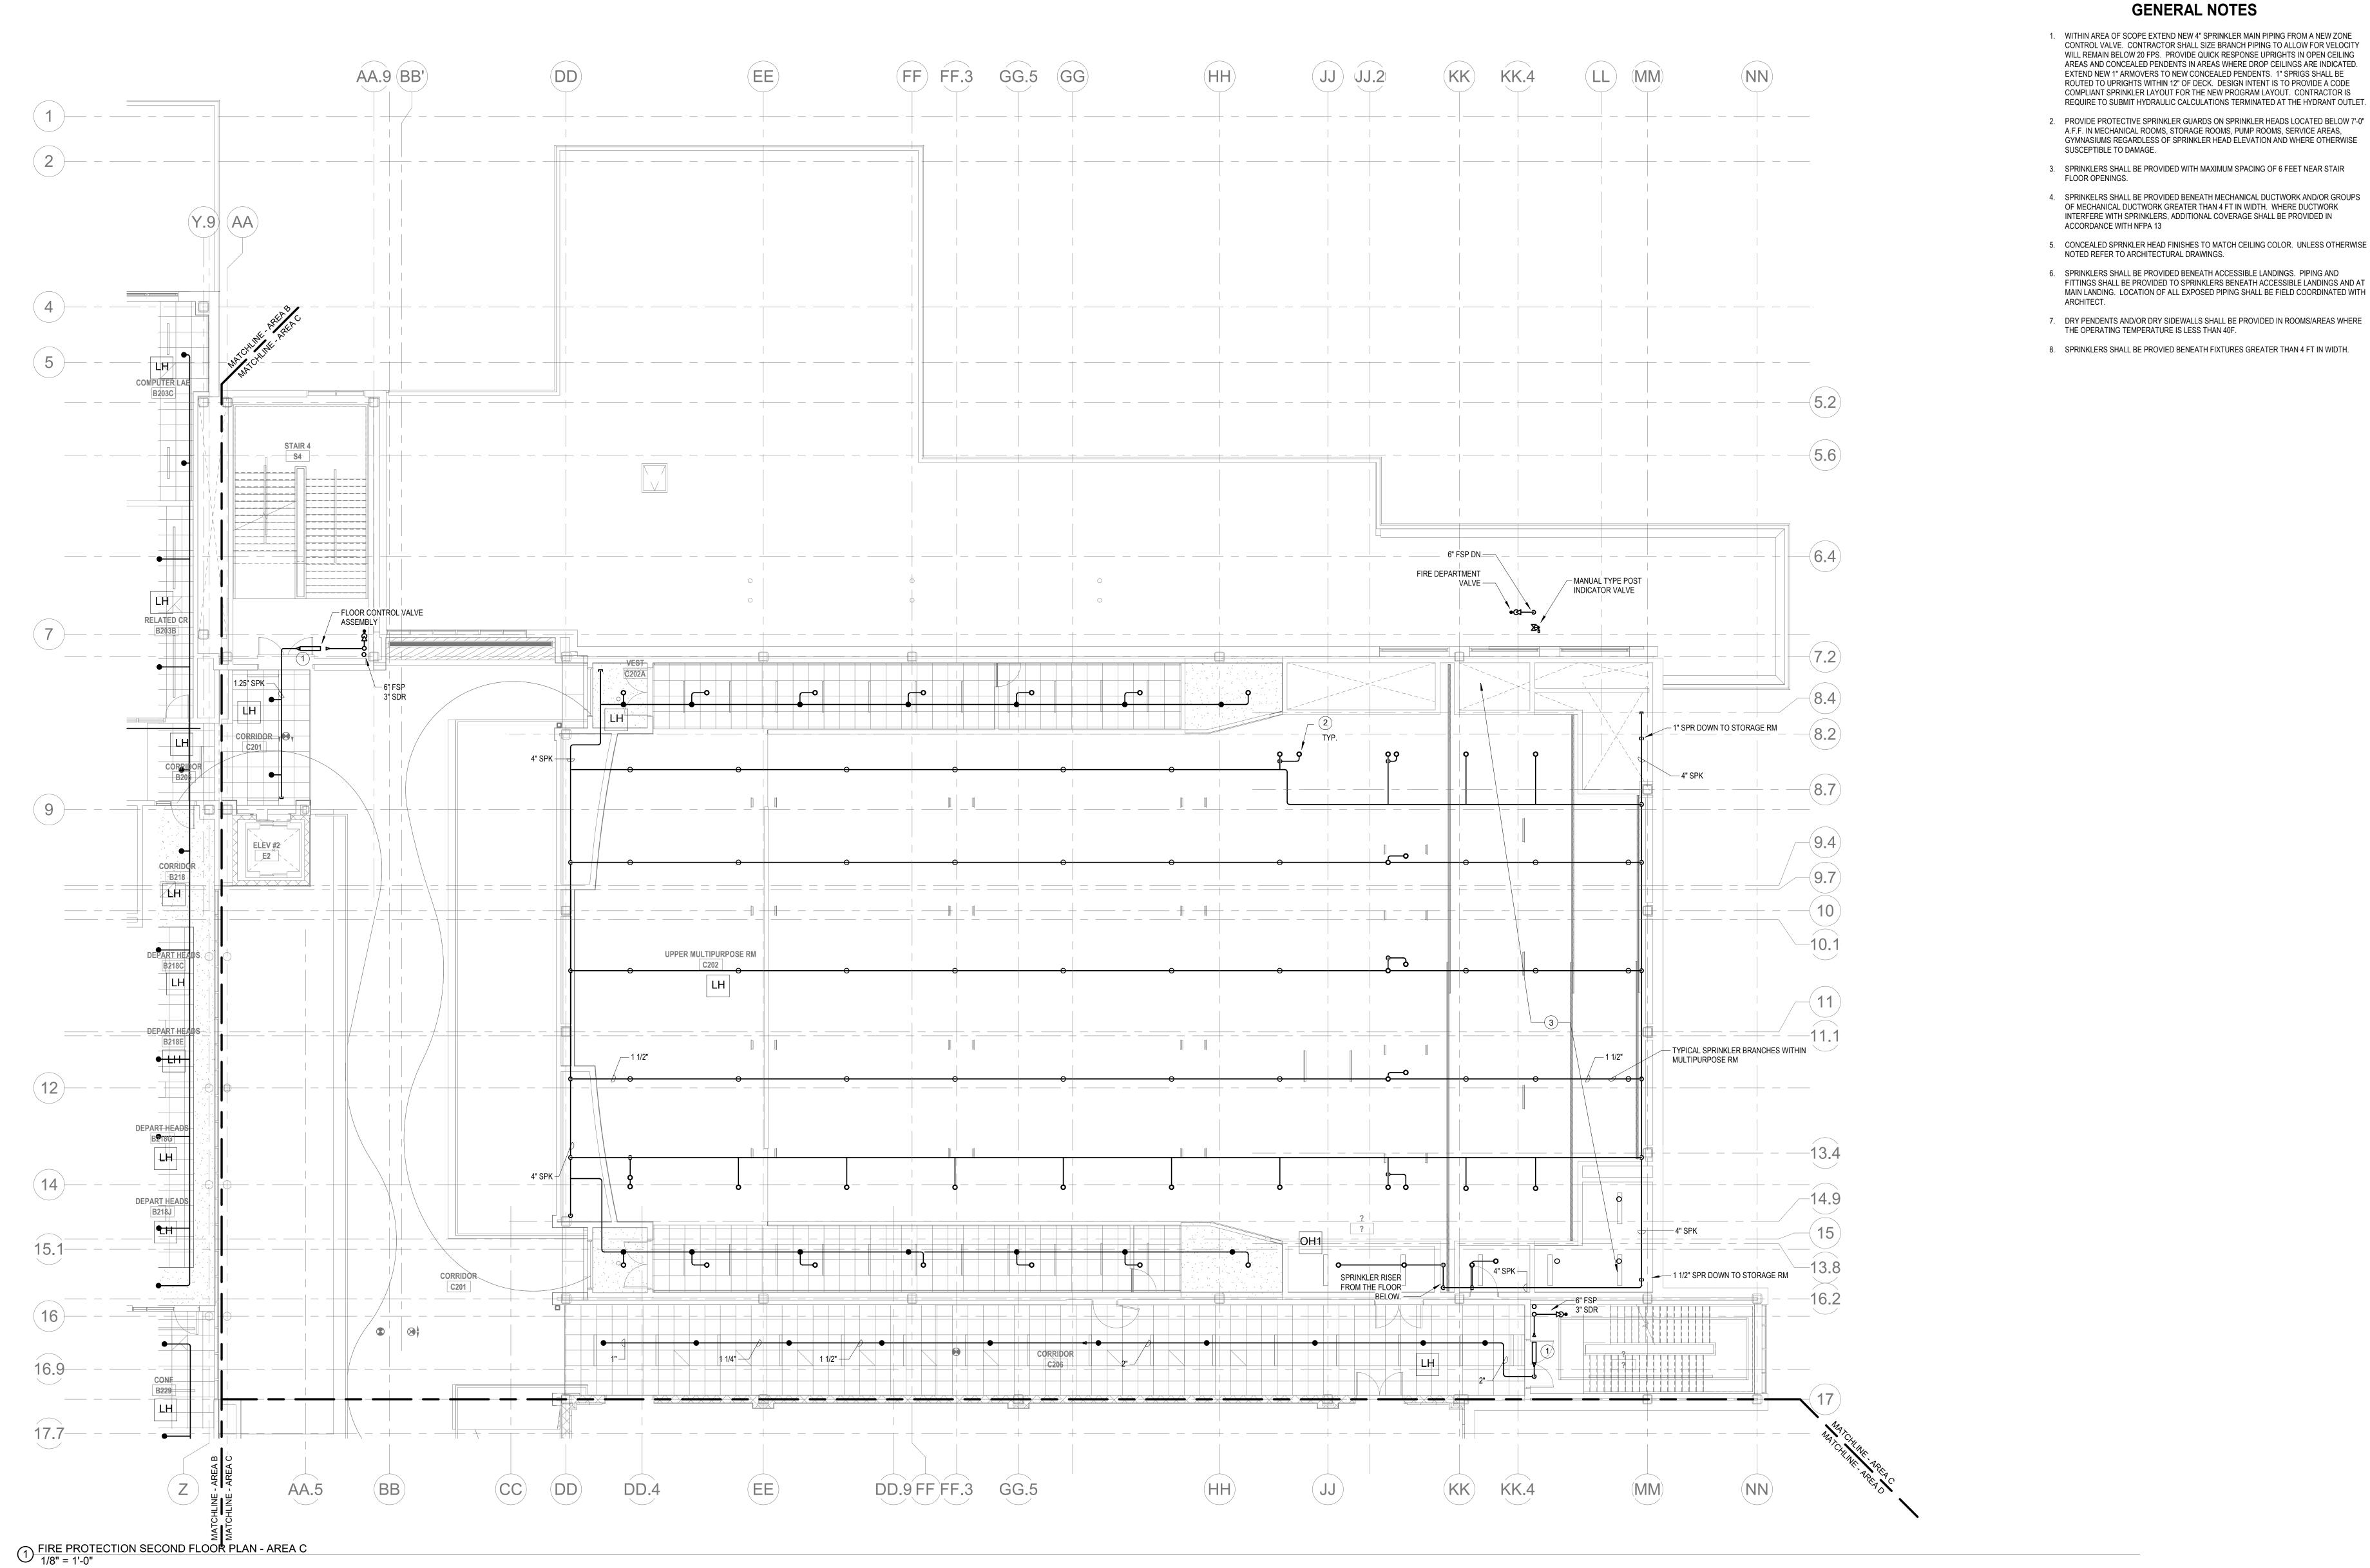

LH LIGHT HAZARD OCCUPANCY

OH ORDINARY HAZARD OCCUPANCY EH EXTRA HAZARD OCCUPANCY

(1) PROVIDE FLOOR CONTROL VALVE. THE FLOOR CONTROL VALVE ASSEMBLY SHALL CONSIST OF A BUTTERFLY VALVE, CHECK VALVE, FLOW SWITCH, PRESSURE GAUGE AND MAIN DRAIN VALVE WITH INSPECTOR'S

TEST CONNECTION. (AS REQUIRED PER DETAIL) (2) PROVIDE SPRINKLER UNDERSIDE OF DUCTWORK. FIELD COORDINATE.

3) PROVIDE SPRINKLER PROTECTION UNDERNEATH CATWALK ABOVE THE STAGE IN ACCORDANCE WITH 780 CMR 410.7.

GENERAL NOTES

- WITHIN AREA OF SCOPE EXTEND NEW 4" SPRINKLER MAIN PIPING FROM A NEW ZONE CONTROL VALVE. CONTRACTOR SHALL SIZE BRANCH PIPING TO ALLOW FOR VELOCITY WILL REMAIN BELOW 20 FPS. PROVIDE QUICK RESPONSE UPRIGHTS IN OPEN CEILING AREAS AND CONCEALED PENDENTS IN AREAS WHERE DROP CEILINGS ARE INDICATED. EXTEND NEW 1" ARMOVERS TO NEW CONCEALED PENDENTS. 1" SPRIGS SHALL BE ROUTED TO UPRIGHTS WITHIN 12" OF DECK. DESIGN INTENT IS TO PROVIDE A CODE COMPLIANT SPRINKLER LAYOUT FOR THE NEW PROGRAM LAYOUT. CONTRACTOR IS REQUIRE TO SUBMIT HYDRAULIC CALCULATIONS TERMINATED AT THE HYDRANT OUTLET.
- A.F.F. IN MECHANICAL ROOMS, STORAGE ROOMS, PUMP ROOMS, SERVICE AREAS, GYMNASIUMS REGARDLESS OF SPRINKLER HEAD ELEVATION AND WHERE OTHERWISE SUSCEPTIBLE TO DAMAGE.
- 3. SPRINKLERS SHALL BE PROVIDED WITH MAXIMUM SPACING OF 6 FEET NEAR STAIR FLOOR OPENINGS.
- 4. SPRINKELRS SHALL BE PROVIDED BENEATH MECHANICAL DUCTWORK AND/OR GROUPS OF MECHANICAL DUCTWORK GREATER THAN 4 FT IN WIDTH. WHERE DUCTWORK INTERFERE WITH SPRINKLERS, ADDITIONAL COVERAGE SHALL BE PROVIDED IN ACCORDANCE WITH NFPA 13
- 5. CONCEALED SPRNKLER HEAD FINISHES TO MATCH CEILING COLOR. UNLESS OTHERWISE NOTED REFER TO ARCHITECTURAL DRAWINGS.
- 6. SPRINKLERS SHALL BE PROVIDED BENEATH ACCESSIBLE LANDINGS. PIPING AND FITTINGS SHALL BE PROVIDED TO SPRINKLERS BENEATH ACCESSIBLE LANDINGS AND AT MAIN LANDING. LOCATION OF ALL EXPOSED PIPING SHALL BE FIELD COORDINATED WITH
- THE OPERATING TEMPERATURE IS LESS THAN 40F.

8. SPRINKLERS SHALL BE PROVIED BENEATH FIXTURES GREATER THAN 4 FT IN WIDTH.



Drummey Rosane Anderson, Inc. 225 Oakland Road 260 Charles Street Studio 205 Studio 300 South Windsor, CT Waltham, MA

06074

Tel: 617.964.1700 www.draws.com Northeast


Planning | Architecture | Interior Design


Metropolitan Regional Vocational High

Wakefield, MA 01880

PHILADELPHIA | NEW YORK | BOSTON | BALTIMORE | WASHINGTON, DC MECHANICAL | ELECTRICAL | PLUMBING | FIRE PROTECTION STRUCTURAL | TECHNOLOGY | COMMISSIONING


MSBA 60% CD SUBMISSION January 13, 2023

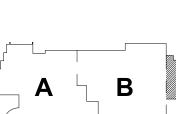

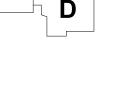


KEY PLAN MAGNETIC NORTH



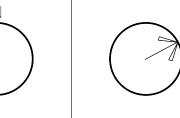

PROTECTION SECOND FLOOR PLAN - AREA C

FP1-1-2C

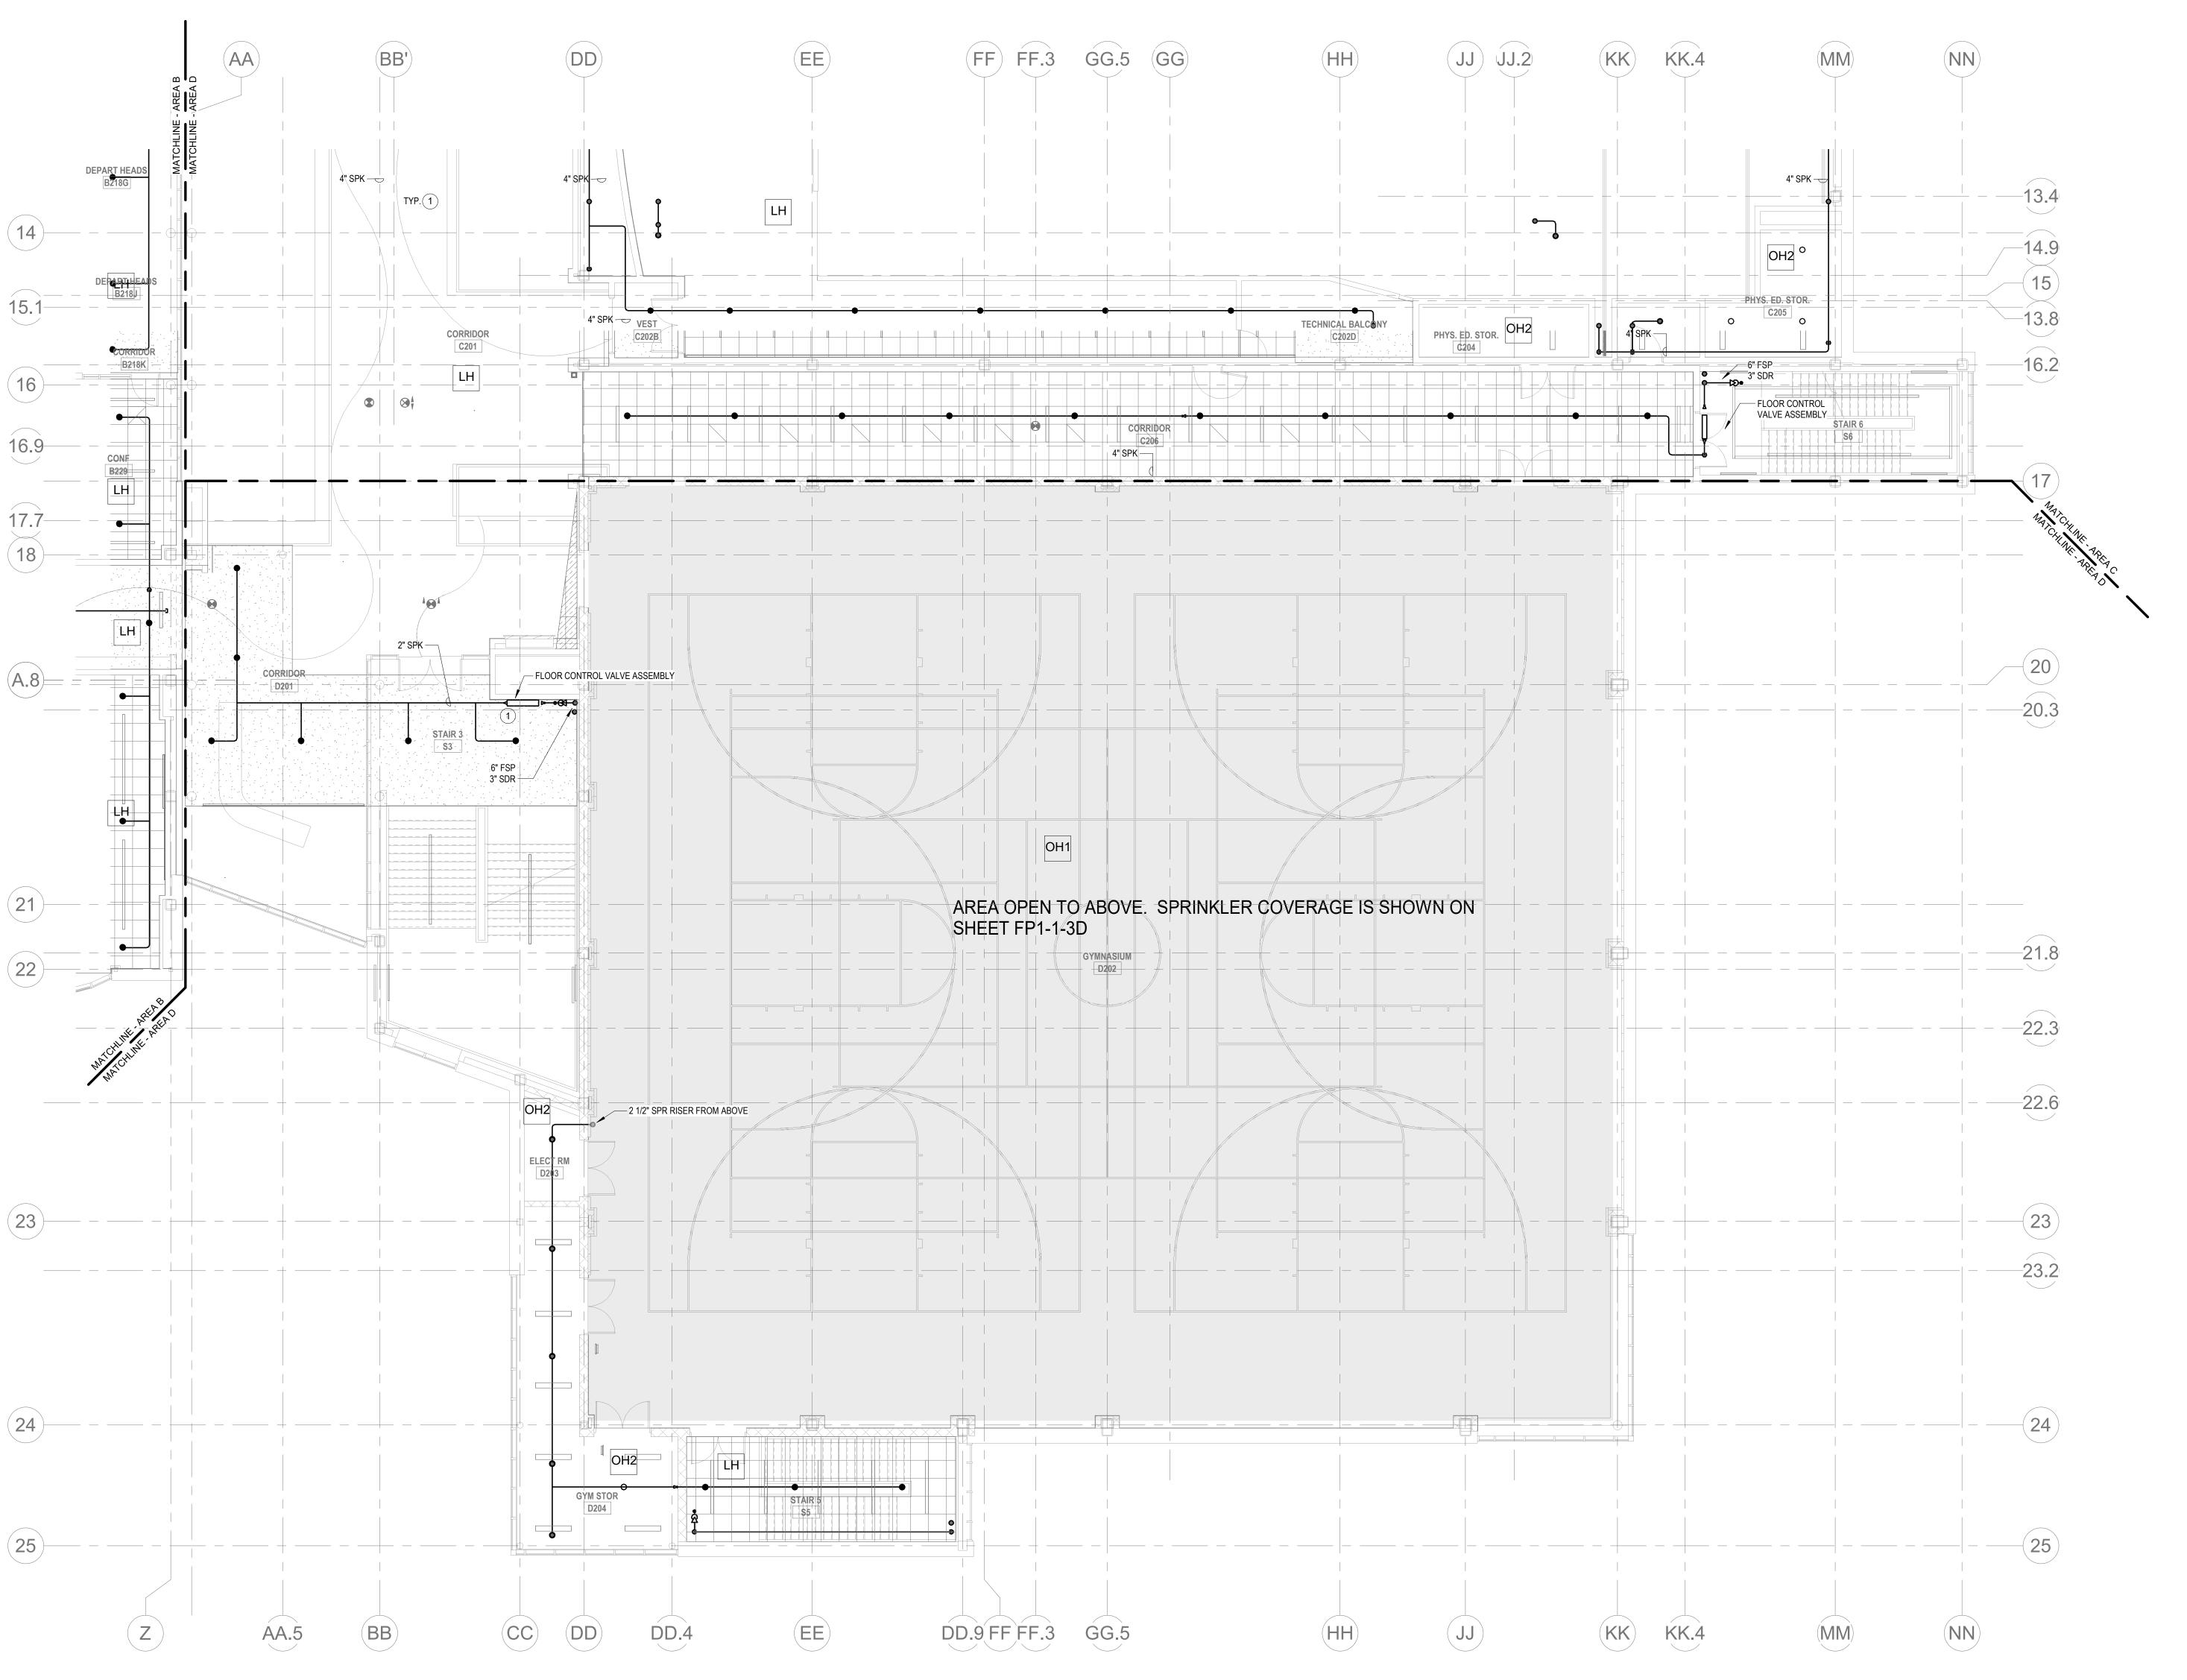

1 FIRE PROTECTION SECOND FLOOR PLAN - AREA D
1/8" = 1'-0"

KEYNOTES

- (LH) LIGHT HAZARD OCCUPANCY
- OH) ORDINARY HAZARD OCCUPANCY
- EH) EXTRA HAZARD OCCUPANCY
- (1) PROVIDE FLOOR CONTROL VALVE. THE FLOOR CONTROL VALVE ASSEMBLY SHALL CONSIST OF A BUTTERFLY VALVE, CHECK VALVE, FLOW SWITCH, PRESSURE GAUGE AND MAIN DRAIN VALVE WITH INSPECTOR'S TEST CONNECTION. (AS REQUIRED PER DETAIL)

GENERAL NOTES

- 1. WITHIN AREA OF SCOPE EXTEND NEW 4" SPRINKLER MAIN PIPING FROM A NEW ZONE CONTROL VALVE. CONTRACTOR SHALL SIZE BRANCH PIPING TO ALLOW FOR VELOCITY WILL REMAIN BELOW 20 FPS. PROVIDE QUICK RESPONSE UPRIGHTS IN OPEN CEILING AREAS AND CONCEALED PENDENTS IN AREAS WHERE DROP CEILINGS ARE INDICATED. EXTEND NEW 1" ARMOVERS TO NEW CONCEALED PENDENTS. 1" SPRIGS SHALL BE ROUTED TO UPRIGHTS WITHIN 12" OF DECK. DESIGN INTENT IS TO PROVIDE A CODE COMPLIANT SPRINKLER LAYOUT FOR THE NEW PROGRAM LAYOUT. CONTRACTOR IS REQUIRE TO SUBMIT HYDRAULIC CALCULATIONS TERMINATED AT THE HYDRANT OUTLET.
- 2. PROVIDE PROTECTIVE SPRINKLER GUARDS ON SPRINKLER HEADS LOCATED BELOW 7'-0" A.F.F. IN MECHANICAL ROOMS, STORAGE ROOMS, PUMP ROOMS, SERVICE AREAS, GYMNASIUMS REGARDLESS OF SPRINKLER HEAD ELEVATION AND WHERE OTHERWISE SUSCEPTIBLE TO DAMAGE.
- 3. SPRINKLERS SHALL BE PROVIDED WITH MAXIMUM SPACING OF 6 FEET NEAR STAIR FLOOR OPENINGS.
- 4. SPRINKELRS SHALL BE PROVIDED BENEATH MECHANICAL DUCTWORK AND/OR GROUPS OF MECHANICAL DUCTWORK GREATER THAN 4 FT IN WIDTH. WHERE DUCTWORK INTERFERE WITH SPRINKLERS, ADDITIONAL COVERAGE SHALL BE PROVIDED IN ACCORDANCE WITH NFPA 13
- 5. CONCEALED SPRNKLER HEAD FINISHES TO MATCH CEILING COLOR. UNLESS OTHERWISE NOTED REFER TO ARCHITECTURAL DRAWINGS. 6. SPRINKLERS SHALL BE PROVIDED BENEATH ACCESSIBLE LANDINGS. PIPING AND
- FITTINGS SHALL BE PROVIDED TO SPRINKLERS BENEATH ACCESSIBLE LANDINGS AND AT MAIN LANDING. LOCATION OF ALL EXPOSED PIPING SHALL BE FIELD COORDINATED WITH ARCHITECT.
- 7. DRY PENDENTS AND/OR DRY SIDEWALLS SHALL BE PROVIDED IN ROOMS/AREAS WHERE THE OPERATING TEMPERATURE IS LESS THAN 40F.
- 8. SPRINKLERS SHALL BE PROVIED BENEATH FIXTURES GREATER THAN 4 FT IN WIDTH.

Drummey Rosane Anderson, Inc. 225 Oakland Road 260 Charles Street Studio 205 Studio 300 South Windsor, CT Waltham, MA

Planning | Architecture | Interior Design Tel: 617.964.1700 www.draws.com Northeast Metropolitan

Regional Vocational High School


Wakefield, MA 01880


PHILADELPHIA | NEW YORK | BOSTON | BALTIMORE | WASHINGTON, DC MECHANICAL | ELECTRICAL | PLUMBING | FIRE PROTECTION STRUCTURAL | TECHNOLOGY | COMMISSIONING

SUBMISSION

MSBA 60% CD

January 13, 2023

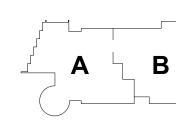

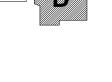


MAGNETIC NORTH

KEY PLAN

PROJECT NORTH

PROTECTION SECOND FLOOR PLAN - AREA D

FP1-1-2D

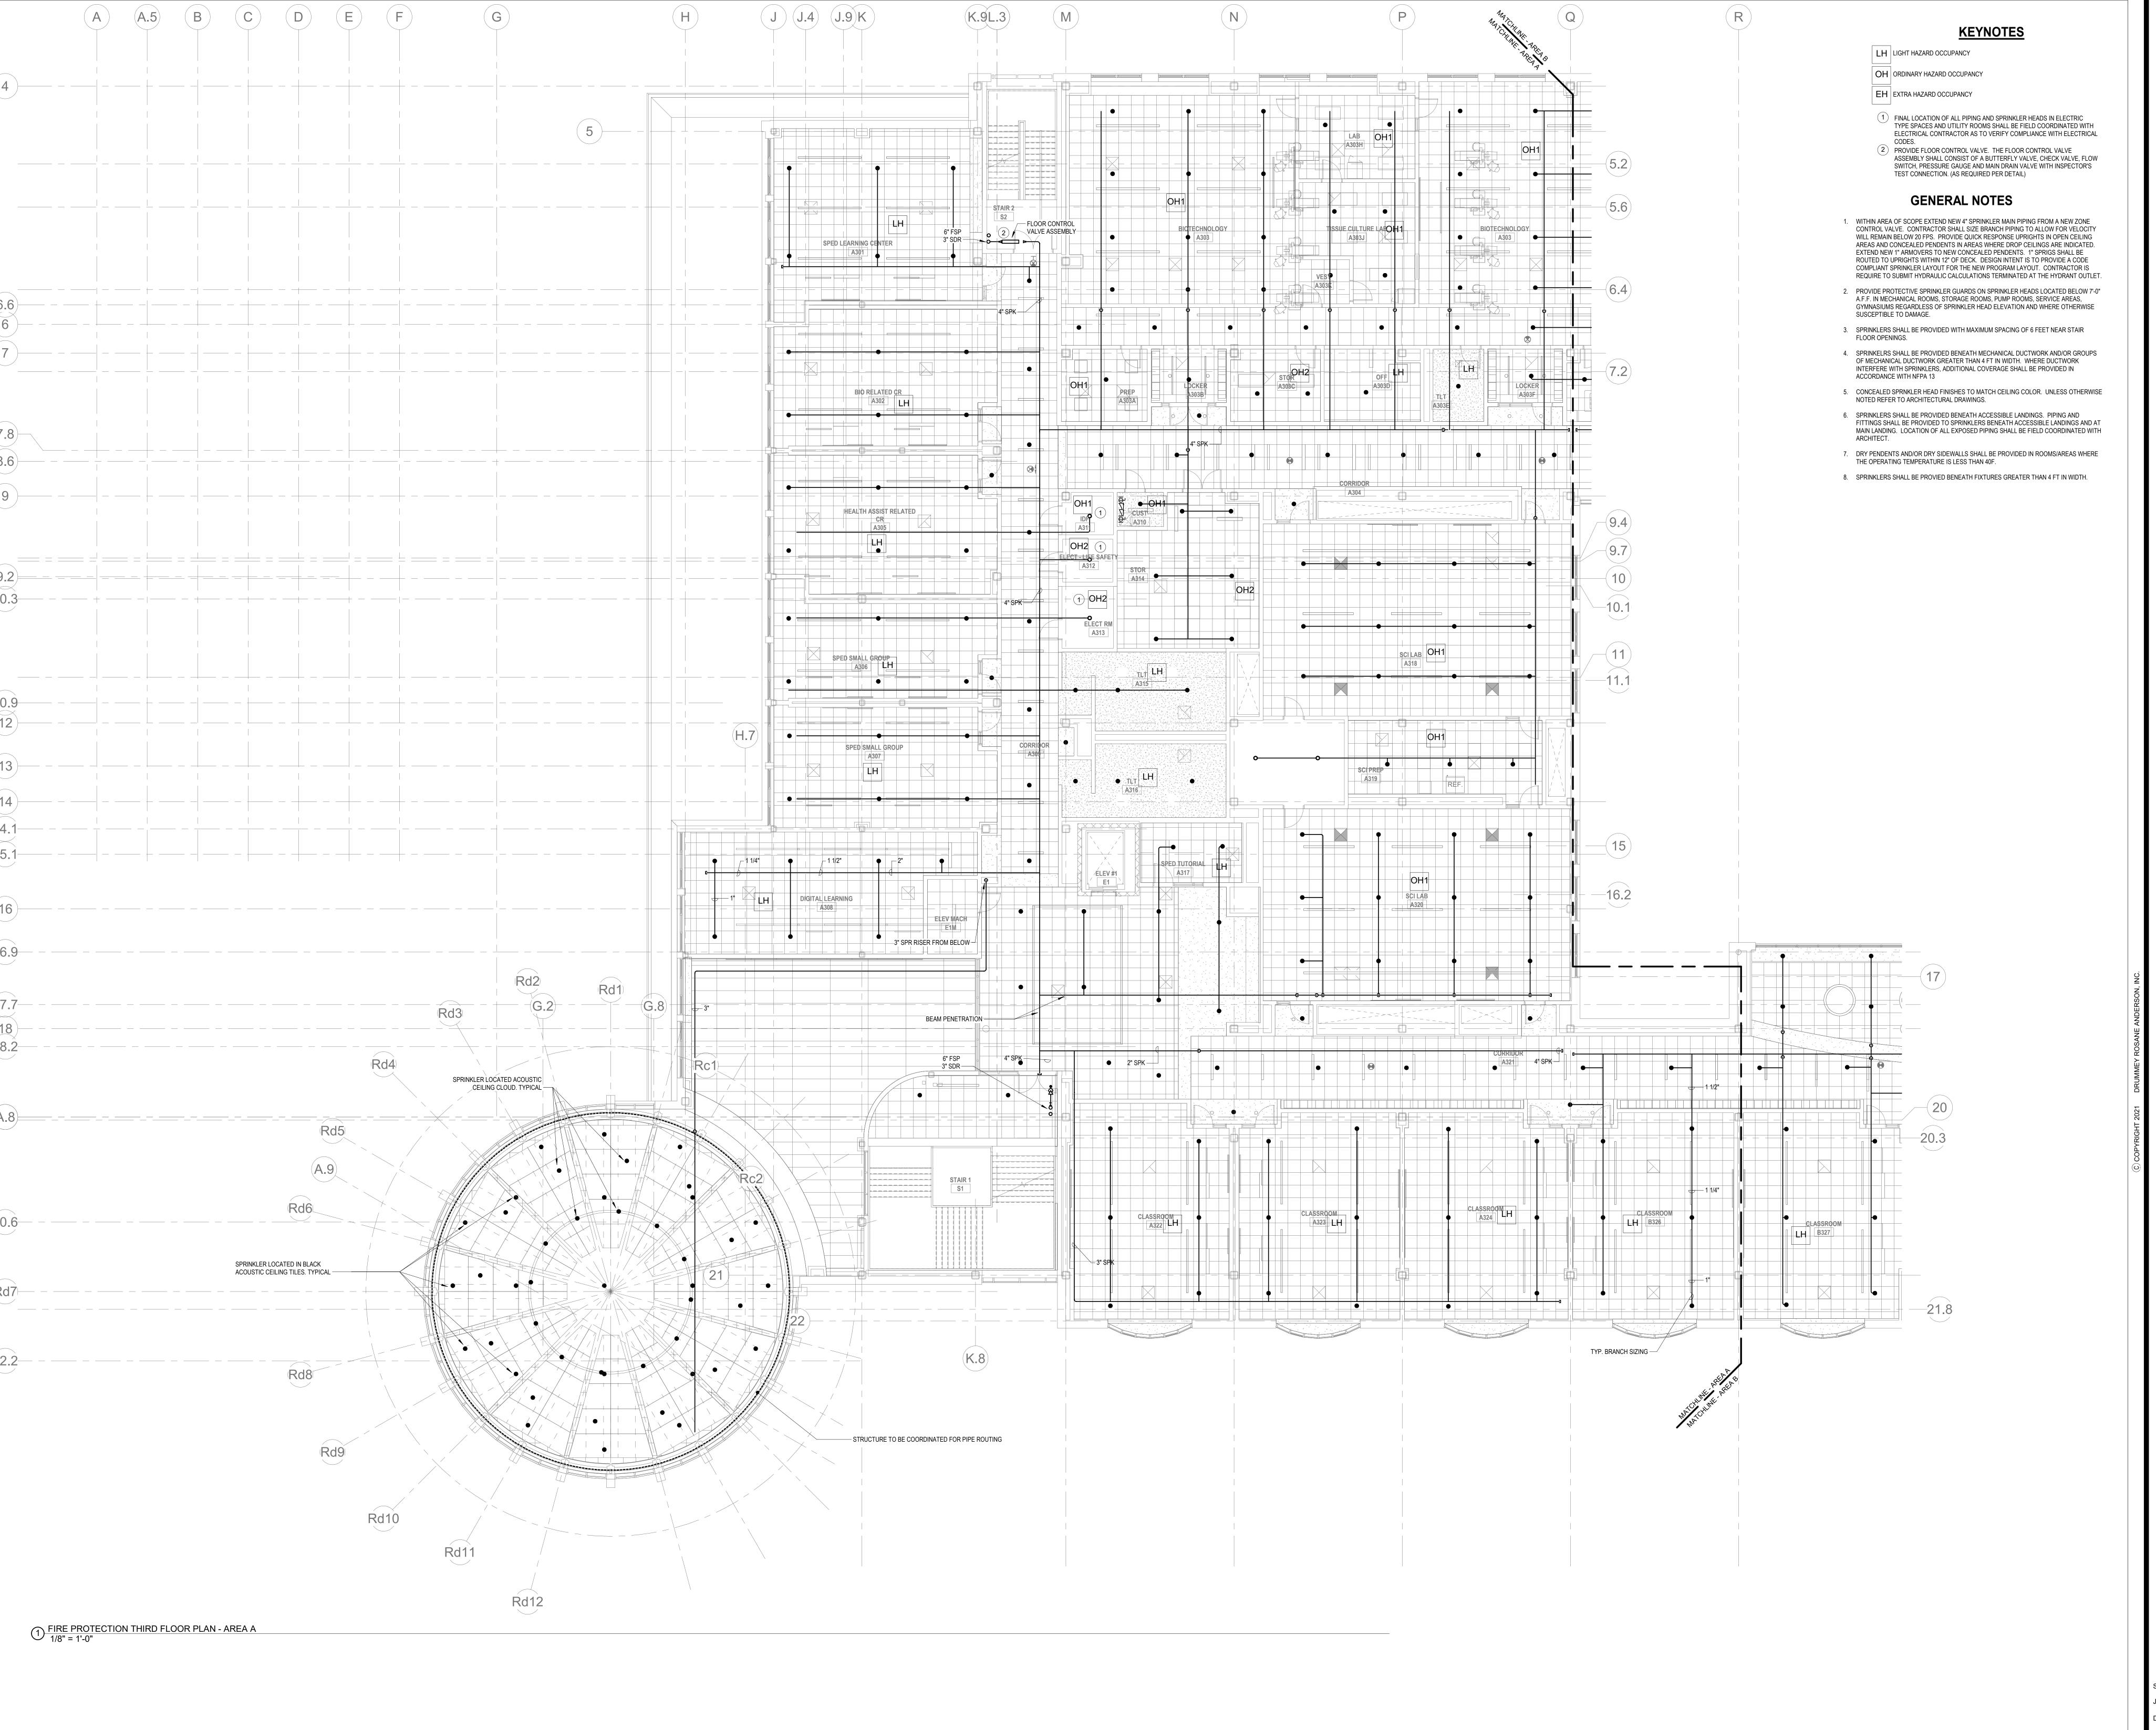

DRA

Drummey Rosane Anderson, Inc.

225 Oakland Road
Studio 205
South Windsor, CT

Studio 205
South Waltham, MA

Planning | Architecture | Interior Design
Tel: 617.964.1700
www.draws.com

Northeast Metropolitan Regional Vocational High

Wakefield, MA 01880

LA CONSULTING ENGINEERS, INC. TEMPLE PLACE STOM, MA 02111-1306 L: 617 357 6060 FAX: 617 357 5188 WV.BALA.COM

ENGINEERS


PHLADELPHA | NEW YORK | BOSTON | BALTIMORE | WASHINGTON, DC


MECHANICAL | ELECTRICAL | PLUMBING | FIRE PROTECTION
STRUCTURAL | TECHNOLOGY | COMMISSIONING

SUBMISSION

January 13, 2023


MSBA 60% CD

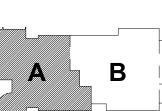

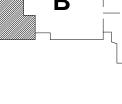

KEY PLAN

T NORTH MAGNETIC NORTH

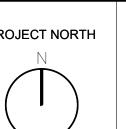


FIRE PROTECTION THIRD FLOOR PLAN - AREA A

Scale: 1/8" = 1'-0"

Job No.: 20202

Drawn By: DRA

FP1-1-3A

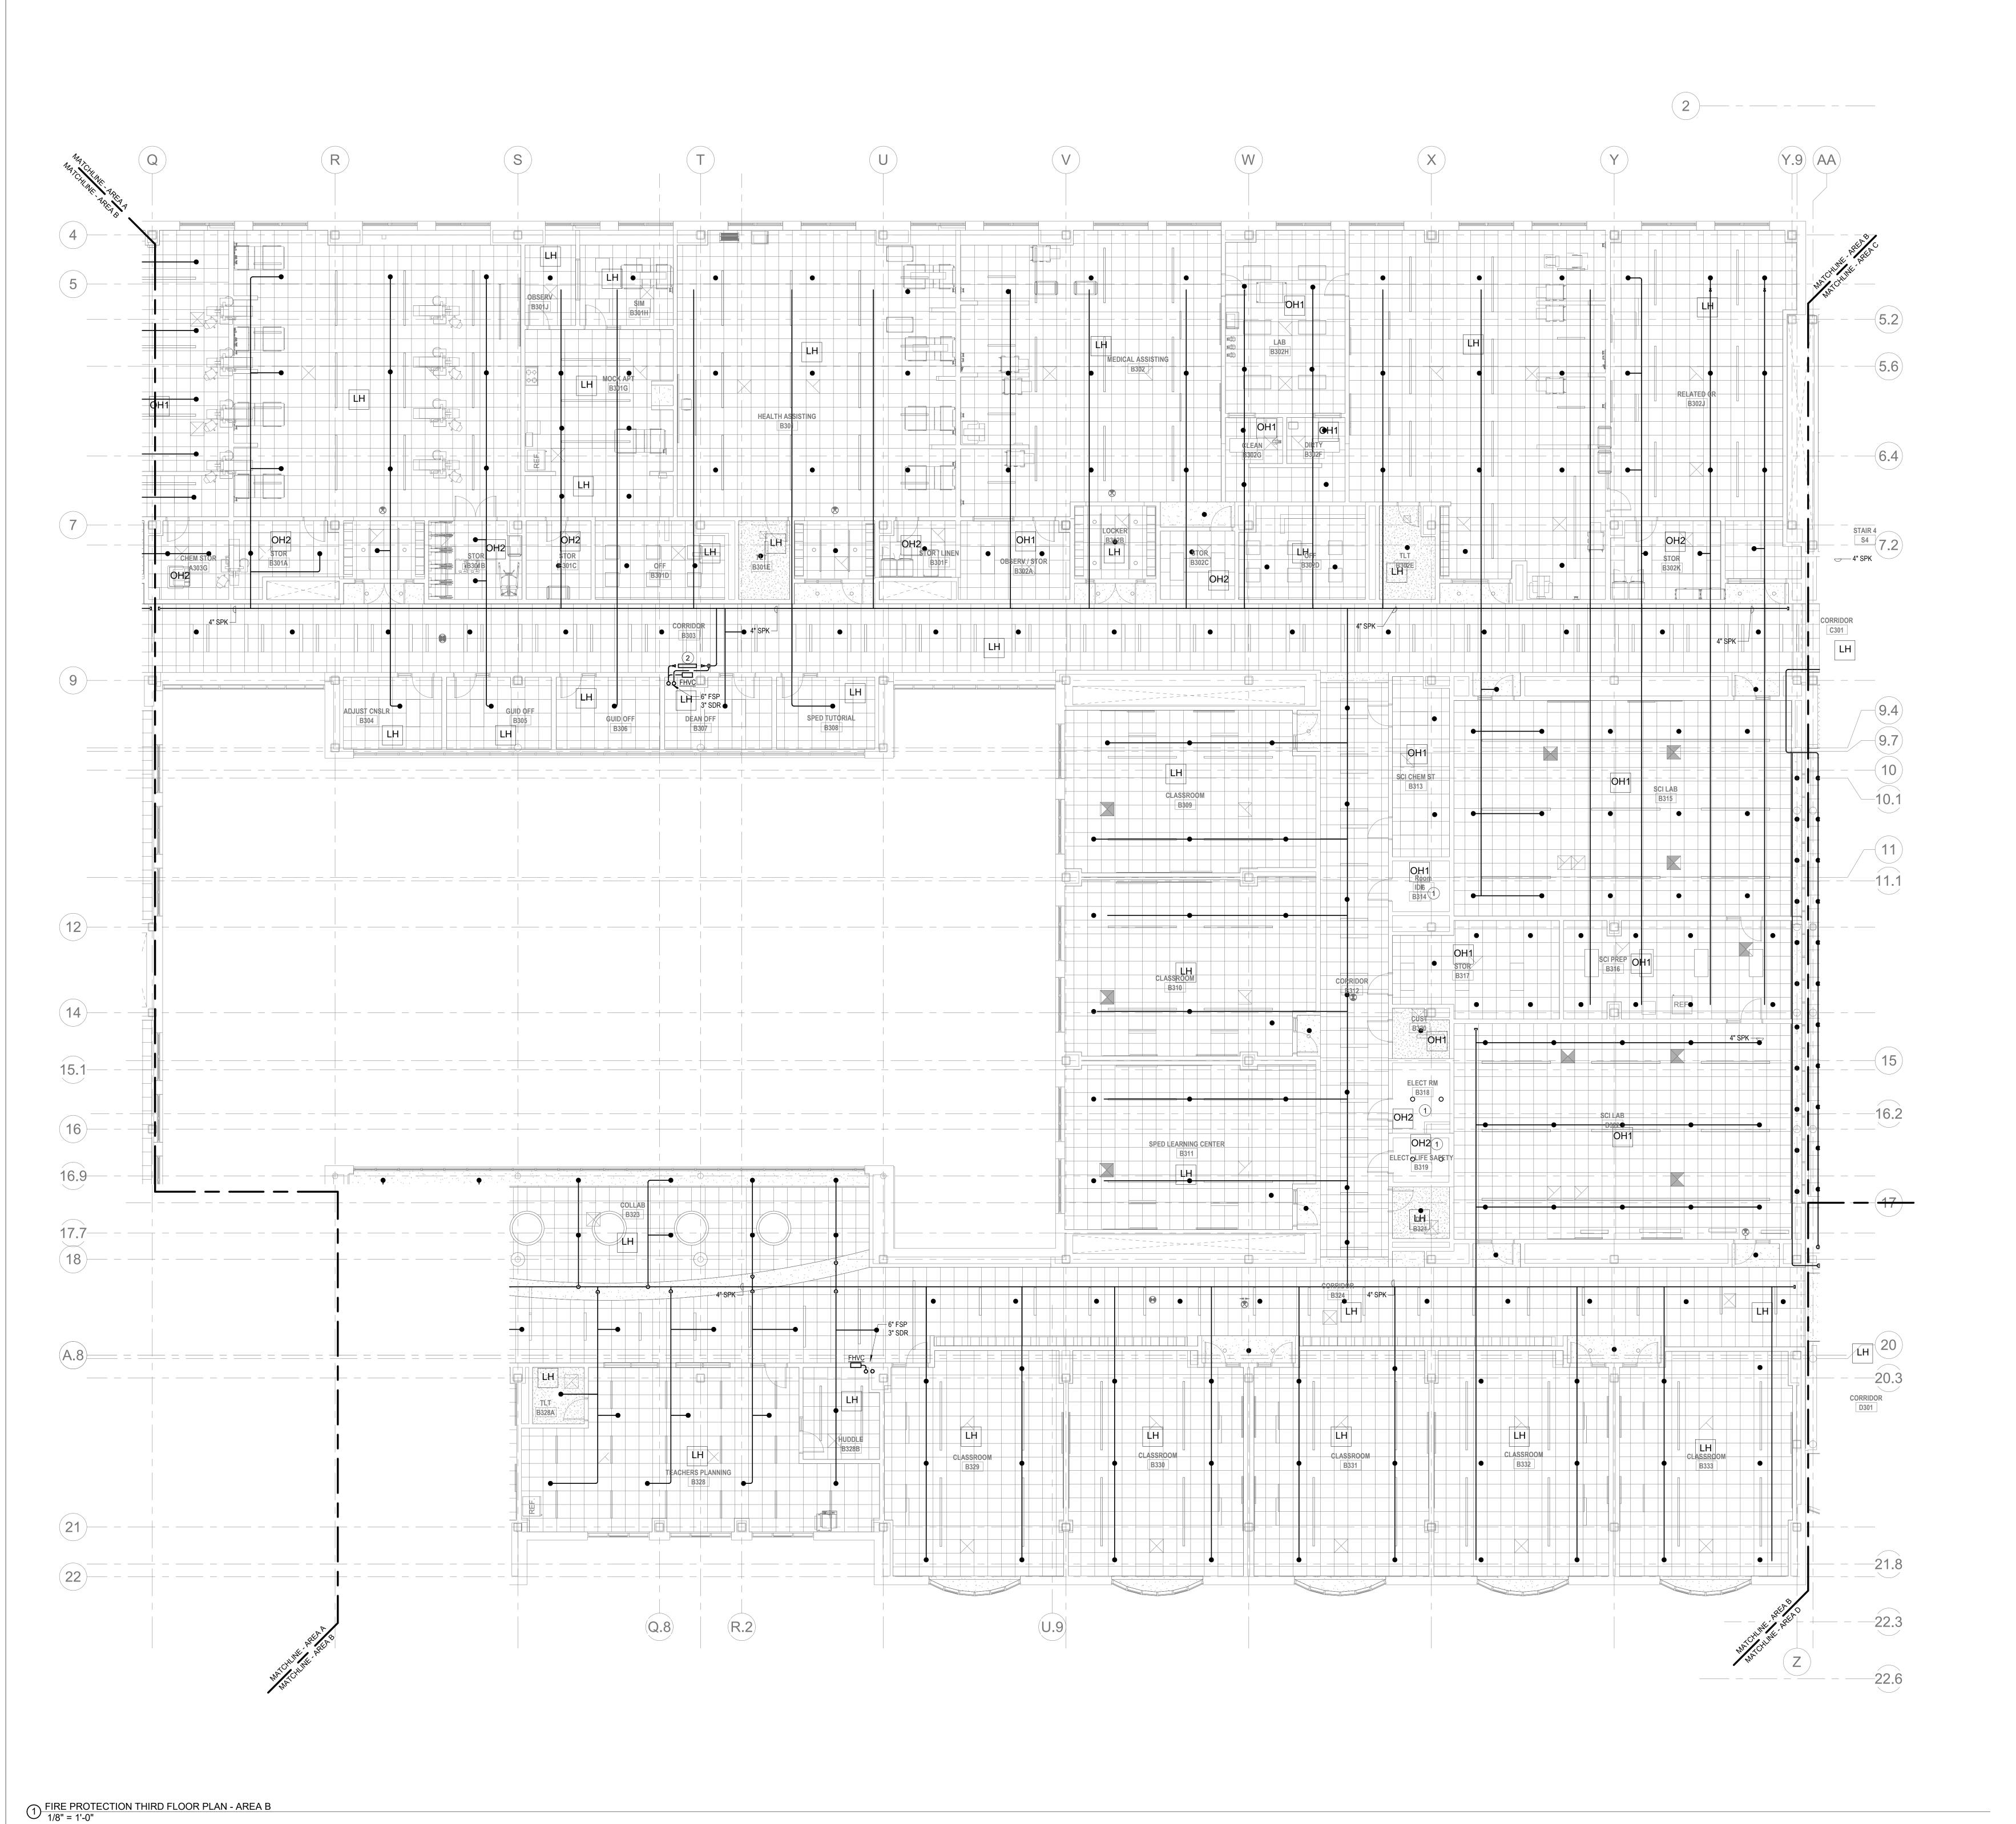

- (LH) LIGHT HAZARD OCCUPANCY
- OH) ORDINARY HAZARD OCCUPANCY EH) EXTRA HAZARD OCCUPANCY
- 1 FINAL LOCATION OF ALL PIPING AND SPRINKLER HEADS IN ELECTRIC TYPE SPACES AND UTILITY ROOMS SHALL BE FIELD COORDINATED WITH ELECTRICAL CONTRACTOR AS TO VERIFY COMPLIANCE WITH ELECTRICAL
- (2) PROVIDE FLOOR CONTROL VALVE. THE FLOOR CONTROL VALVE ASSEMBLY SHALL CONSIST OF A BUTTERFLY VALVE, CHECK VALVE, FLOW SWITCH, PRESSURE GAUGE AND MAIN DRAIN VALVE WITH INSPECTOR'S TEST CONNECTION. (AS REQUIRED PER DETAIL)

GENERAL NOTES

- 1. WITHIN AREA OF SCOPE EXTEND NEW 4" SPRINKLER MAIN PIPING FROM A NEW ZONE CONTROL VALVE. CONTRACTOR SHALL SIZE BRANCH PIPING TO ALLOW FOR VELOCITY WILL REMAIN BELOW 20 FPS. PROVIDE QUICK RESPONSE UPRIGHTS IN OPEN CEILING AREAS AND CONCEALED PENDENTS IN AREAS WHERE DROP CEILINGS ARE INDICATED. EXTEND NEW 1" ARMOVERS TO NEW CONCEALED PENDENTS. 1" SPRIGS SHALL BE ROUTED TO UPRIGHTS WITHIN 12" OF DECK. DESIGN INTENT IS TO PROVIDE A CODE COMPLIANT SPRINKLER LAYOUT FOR THE NEW PROGRAM LAYOUT. CONTRACTOR IS REQUIRE TO SUBMIT HYDRAULIC CALCULATIONS TERMINATED AT THE HYDRANT OUTLET.
- 2. PROVIDE PROTECTIVE SPRINKLER GUARDS ON SPRINKLER HEADS LOCATED BELOW 7'-0" A.F.F. IN MECHANICAL ROOMS, STORAGE ROOMS, PUMP ROOMS, SERVICE AREAS, GYMNASIUMS REGARDLESS OF SPRINKLER HEAD ELEVATION AND WHERE OTHERWISE SUSCEPTIBLE TO DAMAGE.
- 3. SPRINKLERS SHALL BE PROVIDED WITH MAXIMUM SPACING OF 6 FEET NEAR STAIR FLOOR OPENINGS.
- 4. SPRINKELRS SHALL BE PROVIDED BENEATH MECHANICAL DUCTWORK AND/OR GROUPS OF MECHANICAL DUCTWORK GREATER THAN 4 FT IN WIDTH. WHERE DUCTWORK INTERFERE WITH SPRINKLERS, ADDITIONAL COVERAGE SHALL BE PROVIDED IN ACCORDANCE WITH NFPA 13
- 5. CONCEALED SPRNKLER HEAD FINISHES TO MATCH CEILING COLOR. UNLESS OTHERWISE NOTED REFER TO ARCHITECTURAL DRAWINGS.
- 6. SPRINKLERS SHALL BE PROVIDED BENEATH ACCESSIBLE LANDINGS. PIPING AND FITTINGS SHALL BE PROVIDED TO SPRINKLERS BENEATH ACCESSIBLE LANDINGS AND AT MAIN LANDING. LOCATION OF ALL EXPOSED PIPING SHALL BE FIELD COORDINATED WITH ARCHITECT.
- 7. DRY PENDENTS AND/OR DRY SIDEWALLS SHALL BE PROVIDED IN ROOMS/AREAS WHERE THE OPERATING TEMPERATURE IS LESS THAN 40F.
- 8. SPRINKLERS SHALL BE PROVIED BENEATH FIXTURES GREATER THAN 4 FT IN WIDTH.



Drummey Rosane Anderson, Inc. 225 Oakland Road 260 Charles Street Studio 205 Studio 300 South Windsor, CT Waltham, MA Planning | Architecture | Interior Design Tel: 617.964.1700 www.draws.com Northeast Metropolitan Regional Vocational High

Wakefield, MA 01880


School



MECHANICAL | ELECTRICAL | PLUMBING | FIRE PROTECTION STRUCTURAL | TECHNOLOGY | COMMISSIONING


SUBMISSION January 13, 2023

MSBA 60% CD

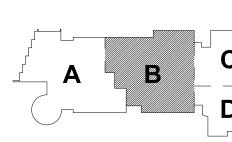


KEY PLAN

MAGNETIC NORTH

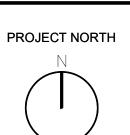

PROTECTION

THIRD FLOOR PLAN - AREA B

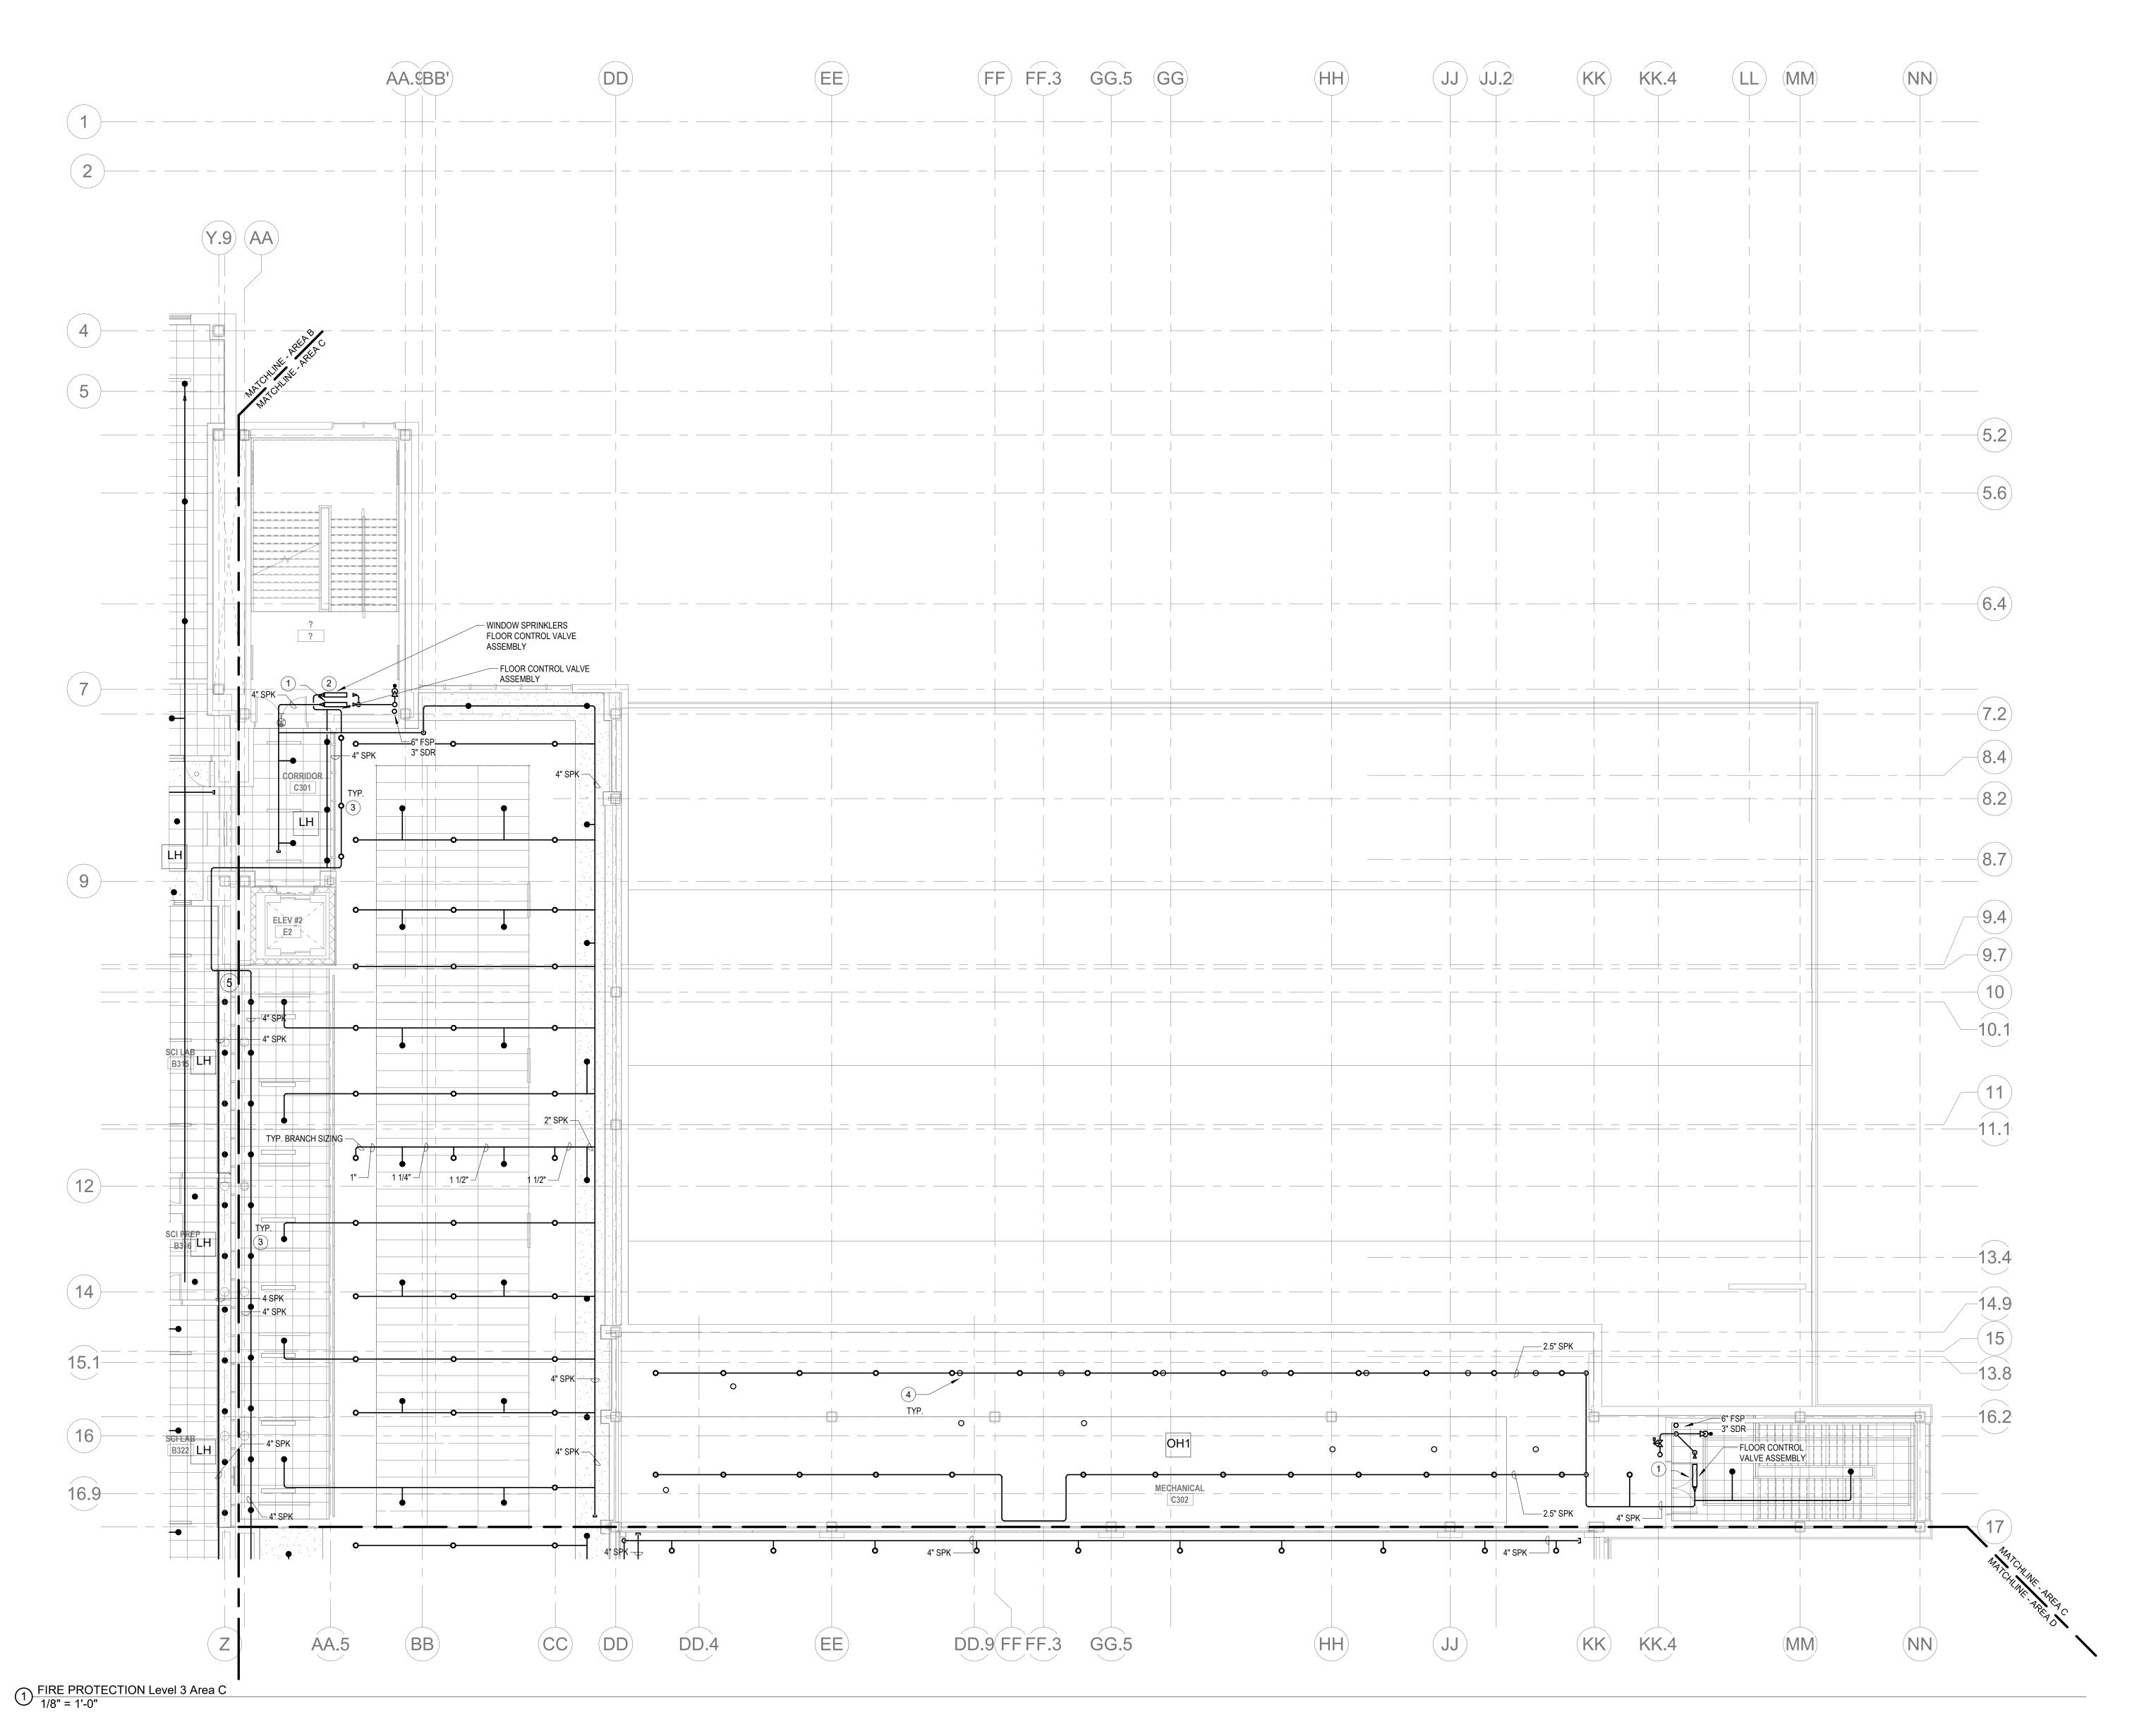

<u>KEYNOTES</u>

- (LH) LIGHT HAZARD OCCUPANCY
- (OH) ORDINARY HAZARD OCCUPANCY EH) EXTRA HAZARD OCCUPANCY

INSPECTOR'S TEST CONNECTION.

- (1) PROVIDE FLOOR CONTROL VALVE. THE FLOOR CONTROL VALVE ASSEMBLY SHALL CONSIST OF A BUTTERFLY VALVE, CHECK VALVE, FLOW SWITCH, PRESSURE GAUGE AND MAIN DRAIN VALVE WITH INSPECTOR'S TEST CONNECTION. (AS REQUIRED PER DETAIL)
- PROVIDE FLOOR CONTROL VALVE FOR THE WINDOW SPRINKLERS. THE FLOOR CONTROL VALVE SHALL CONSIST OF A BUTTERFLY VALVE, CHECK VALVE, FLOW SWITCH, PRESSURE GAUGE AND MAIN DRAIN VALVE WITH
- PROVIDE WINDOW SPRINKLERS WITHIN 2 IN. OF THE GLASS PARTITIONS IN ACCORDANCE WITH NFPA 13 TABLE 7.8.8.4. THESE SPRINLERS SHALL
- BE SPACED NOT MORE THAN 10 FT FROM EACH OTHER. (4) PROVIDE SPRINKLER UNDERSIDE OF DUCTWORK. FIELD COORDINATE.
- (5) FOR ALL PIPING PASSING THROUGH COORDINATE Y9, PROVIDE AN EXPANSION LOOP AND ADD FLEXIBLE COUPLINGS ON EITHER SIDE.

GENERAL NOTES

- 1. WITHIN AREA OF SCOPE EXTEND NEW 4" SPRINKLER MAIN PIPING FROM A NEW ZONE CONTROL VALVE. CONTRACTOR SHALL SIZE BRANCH PIPING TO ALLOW FOR VELOCITY WILL REMAIN BELOW 20 FPS. PROVIDE QUICK RESPONSE UPRIGHTS IN OPEN CEILING AREAS AND CONCEALED PENDENTS IN AREAS WHERE DROP CEILINGS ARE INDICATED. EXTEND NEW 1" ARMOVERS TO NEW CONCEALED PENDENTS. 1" SPRIGS SHALL BE ROUTED TO UPRIGHTS WITHIN 12" OF DECK. DESIGN INTENT IS TO PROVIDE A CODE COMPLIANT SPRINKLER LAYOUT FOR THE NEW PROGRAM LAYOUT. CONTRACTOR IS REQUIRE TO SUBMIT HYDRAULIC CALCULATIONS TERMINATED AT THE HYDRANT OUTLET.
- 2. PROVIDE PROTECTIVE SPRINKLER GUARDS ON SPRINKLER HEADS LOCATED BELOW 7'-0" A.F.F. IN MECHANICAL ROOMS, STORAGE ROOMS, PUMP ROOMS, SERVICE AREAS, GYMNASIUMS REGARDLESS OF SPRINKLER HEAD ELEVATION AND WHERE OTHERWISE SUSCEPTIBLE TO DAMAGE.
- 3. SPRINKLERS SHALL BE PROVIDED WITH MAXIMUM SPACING OF 6 FEET NEAR STAIR FLOOR OPENINGS.

4. SPRINKELRS SHALL BE PROVIDED BENEATH MECHANICAL DUCTWORK AND/OR GROUPS

- OF MECHANICAL DUCTWORK GREATER THAN 4 FT IN WIDTH. WHERE DUCTWORK INTERFERE WITH SPRINKLERS, ADDITIONAL COVERAGE SHALL BE PROVIDED IN ACCORDANCE WITH NFPA 13 5. CONCEALED SPRNKLER HEAD FINISHES TO MATCH CEILING COLOR. UNLESS OTHERWISE
- NOTED REFER TO ARCHITECTURAL DRAWINGS. 6. SPRINKLERS SHALL BE PROVIDED BENEATH ACCESSIBLE LANDINGS. PIPING AND FITTINGS SHALL BE PROVIDED TO SPRINKLERS BENEATH ACCESSIBLE LANDINGS AND AT
- MAIN LANDING. LOCATION OF ALL EXPOSED PIPING SHALL BE FIELD COORDINATED WITH
- 7. DRY PENDENTS AND/OR DRY SIDEWALLS SHALL BE PROVIDED IN ROOMS/AREAS WHERE THE OPERATING TEMPERATURE IS LESS THAN 40F.

8. SPRINKLERS SHALL BE PROVIED BENEATH FIXTURES GREATER THAN 4 FT IN WIDTH.

Drummey Rosane Anderson, Inc. 225 Oakland Road 260 Charles Street Studio 205 Studio 300 South Windsor, CT Waltham, MA 02453

06074

Northeast Metropolitan Regional Vocational High

Planning | Architecture | Interior Design Tel: 617.964.1700


www.draws.com

Wakefield, MA 01880

PHILADELPHIA | NEW YORK | BOSTON | BALTIMORE | WASHINGTON, DC

MSBA 60% CD SUBMISSION

January 13, 2023

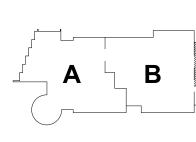




MAGNETIC NORTH

PROTECTION THIRD FLOOR PLAN - AREA C

FP1-1-3C

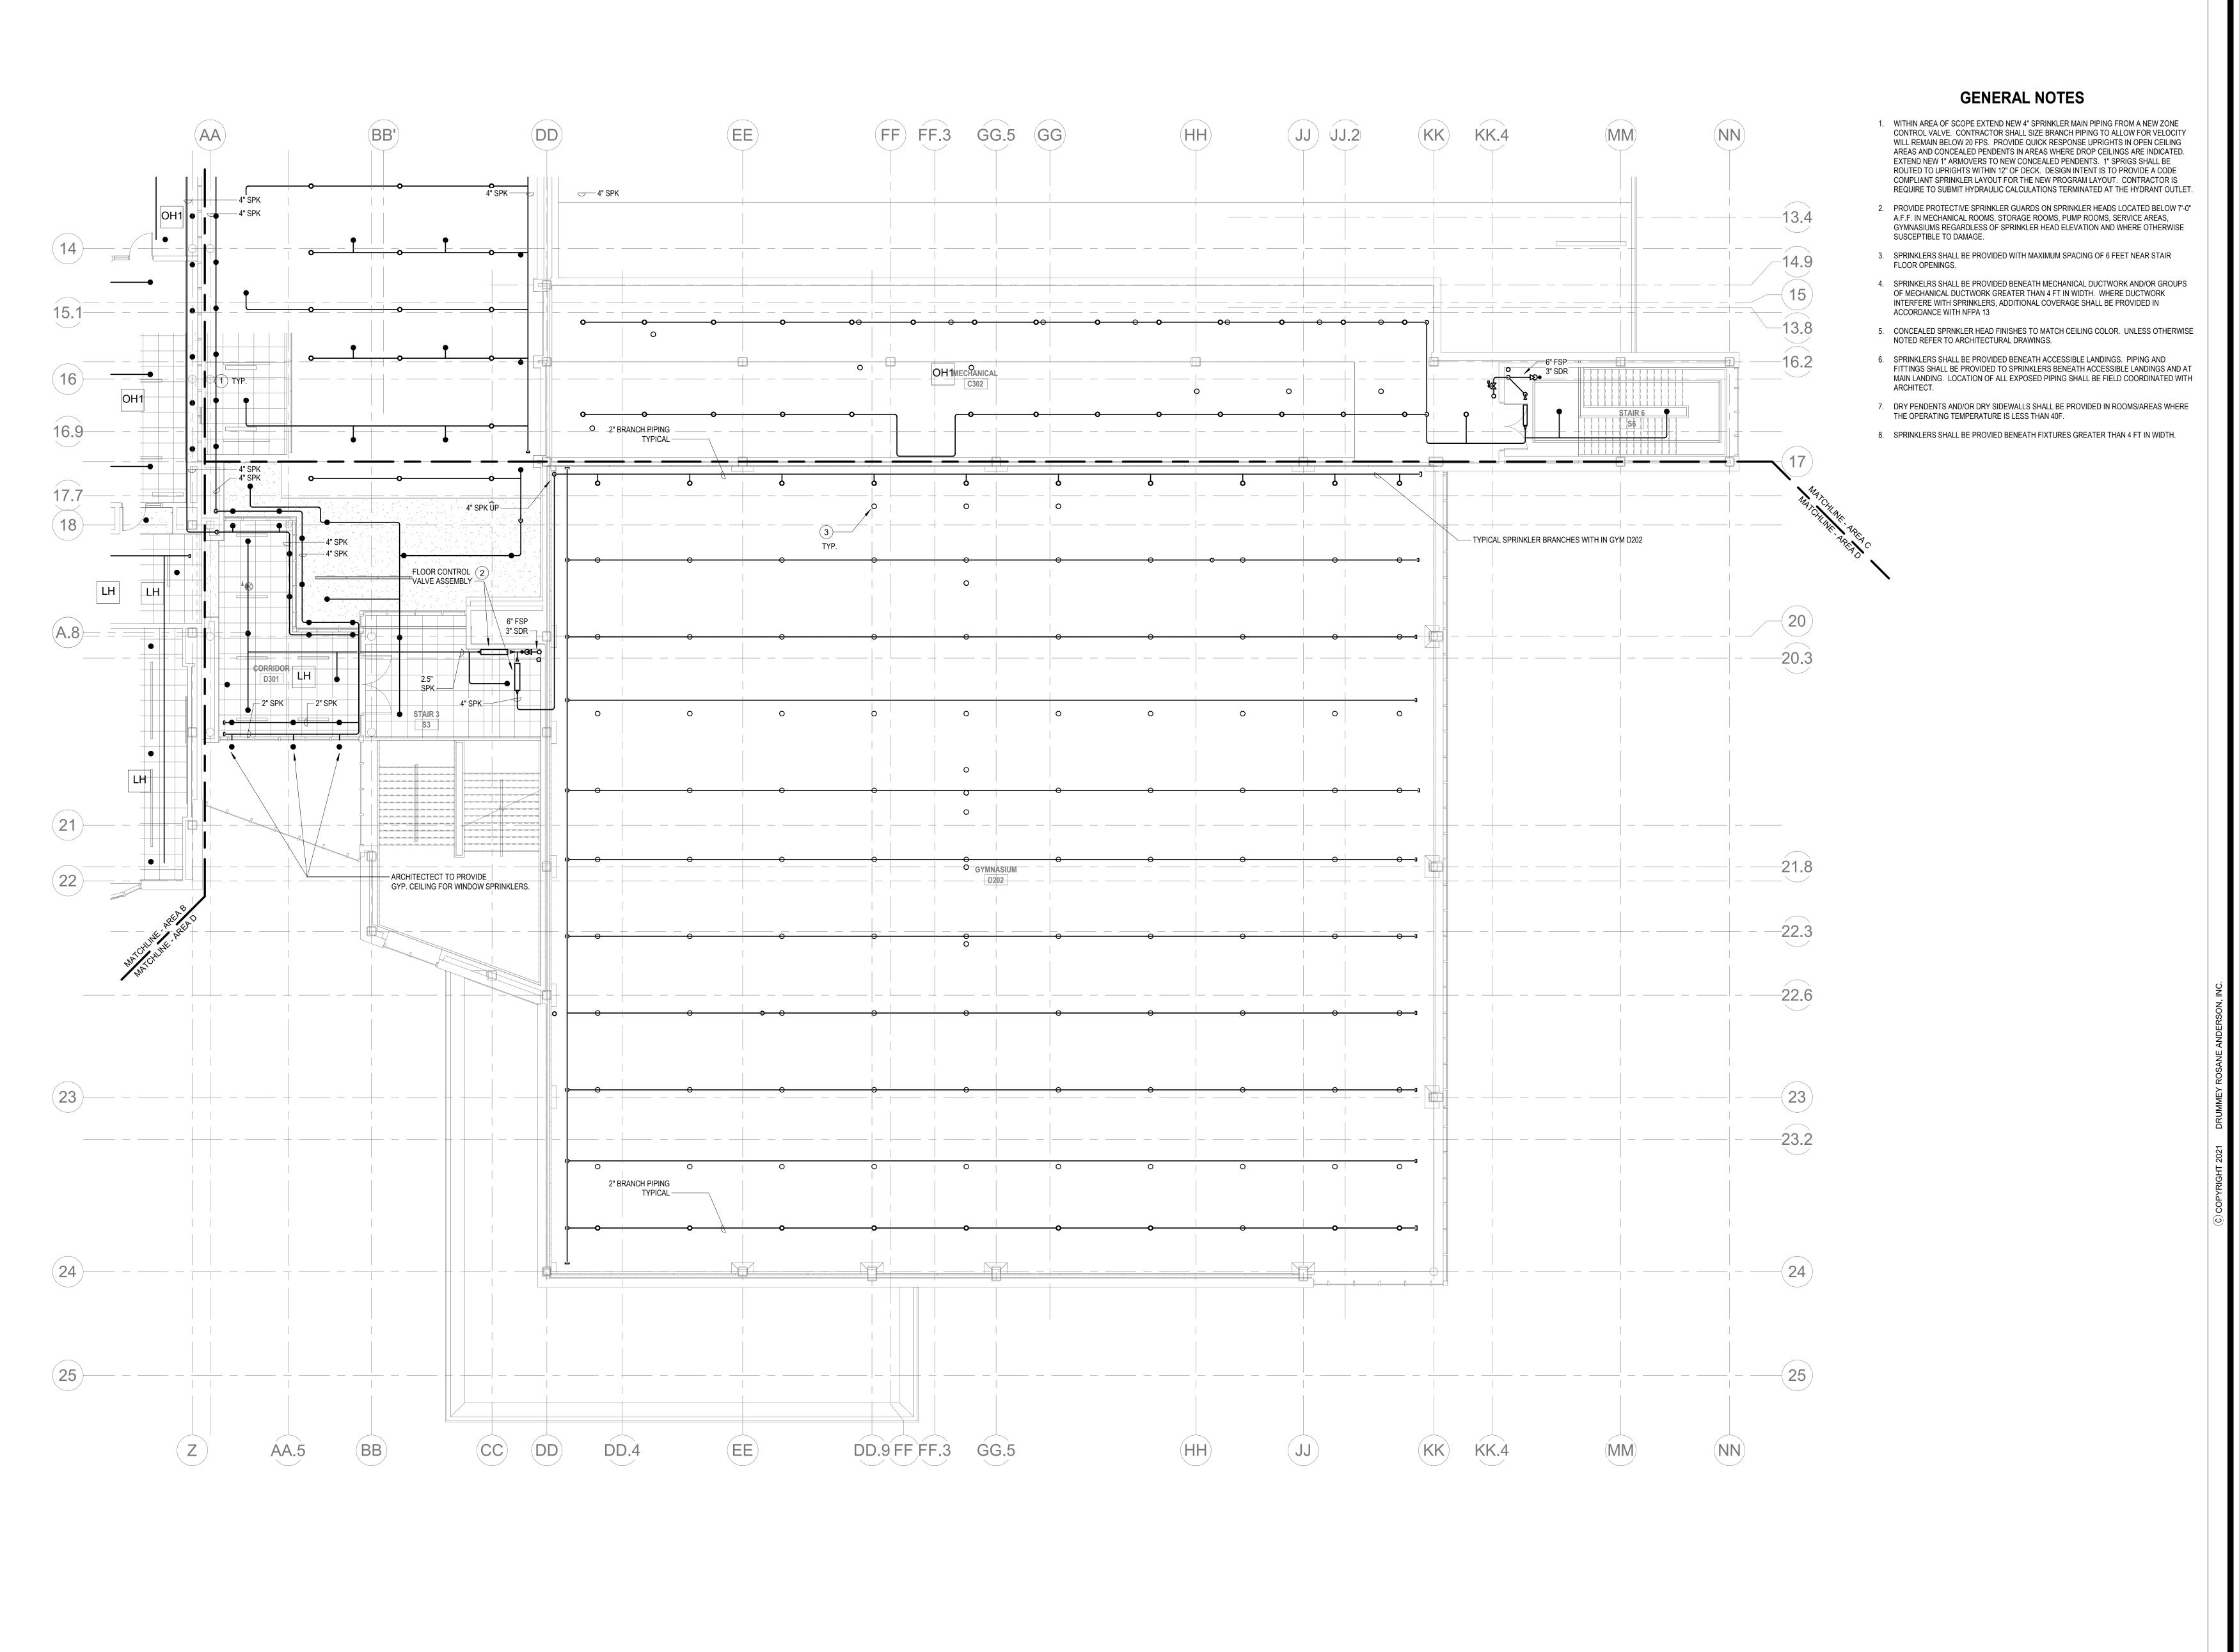

1) FIRE PROTECTION THIRD FLOOR PLAN - AREA D

KEYNOTES (LH) LIGHT HAZARD OCCUPANCY


OH) ORDINARY HAZARD OCCUPANCY

EH EXTRA HAZARD OCCUPANCY

1 PROVIDE WINDOW SPRINKLERS WITHIN 2 IN. OF THE GLASS PARTITIONS IN ACCORDANCE WITH NFPA 13 TABLE 7.8.8.4. THESE SPRINLERS SHALL BE SPACED NOT MORE THAN 10 FT FROM EACH OTHER.

PROVIDE FLOOR CONTROL VALVE. THE FLOOR CONTROL VALVE
ASSEMBLY SHALL CONSIST OF A BUTTERFLY VALVE, CHECK VALVE, FLOW
SWITCH, PRESSURE GAUGE AND MAIN DRAIN VALVE WITH INSPECTOR'S
TEST CONNECTION. (AS REQUIRED PER DETAIL)

(3) PROVIDE SPRINKLER UNDERSIDE OF DUCTWORK. FIELD COORDINATE.

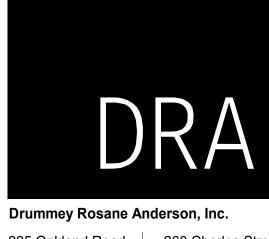

225 Oakland Road 260 Charles Street

Studio 205 Studio 300 South Windsor, CT Waltham, MA 06074 Planning | Architecture | Interior Design Tel: 617.964.1700 www.draws.com

Northeast Metropolitan Regional Vocational High


Wakefield, MA 01880

School

PHILADELPHIA | NEW YORK | BOSTON | BALTIMORE | WASHINGTON, DC MECHANICAL | ELECTRICAL | PLUMBING | FIRE PROTECTION STRUCTURAL | TECHNOLOGY | COMMISSIONING

MSBA 60% CD SUBMISSION


January 13, 2023

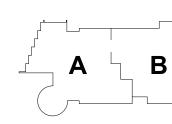



KEY PLAN




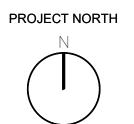

PROTECTION THIRD FLOOR PLAN - AREA D

Drawn By: DRA

FP1-1-3D

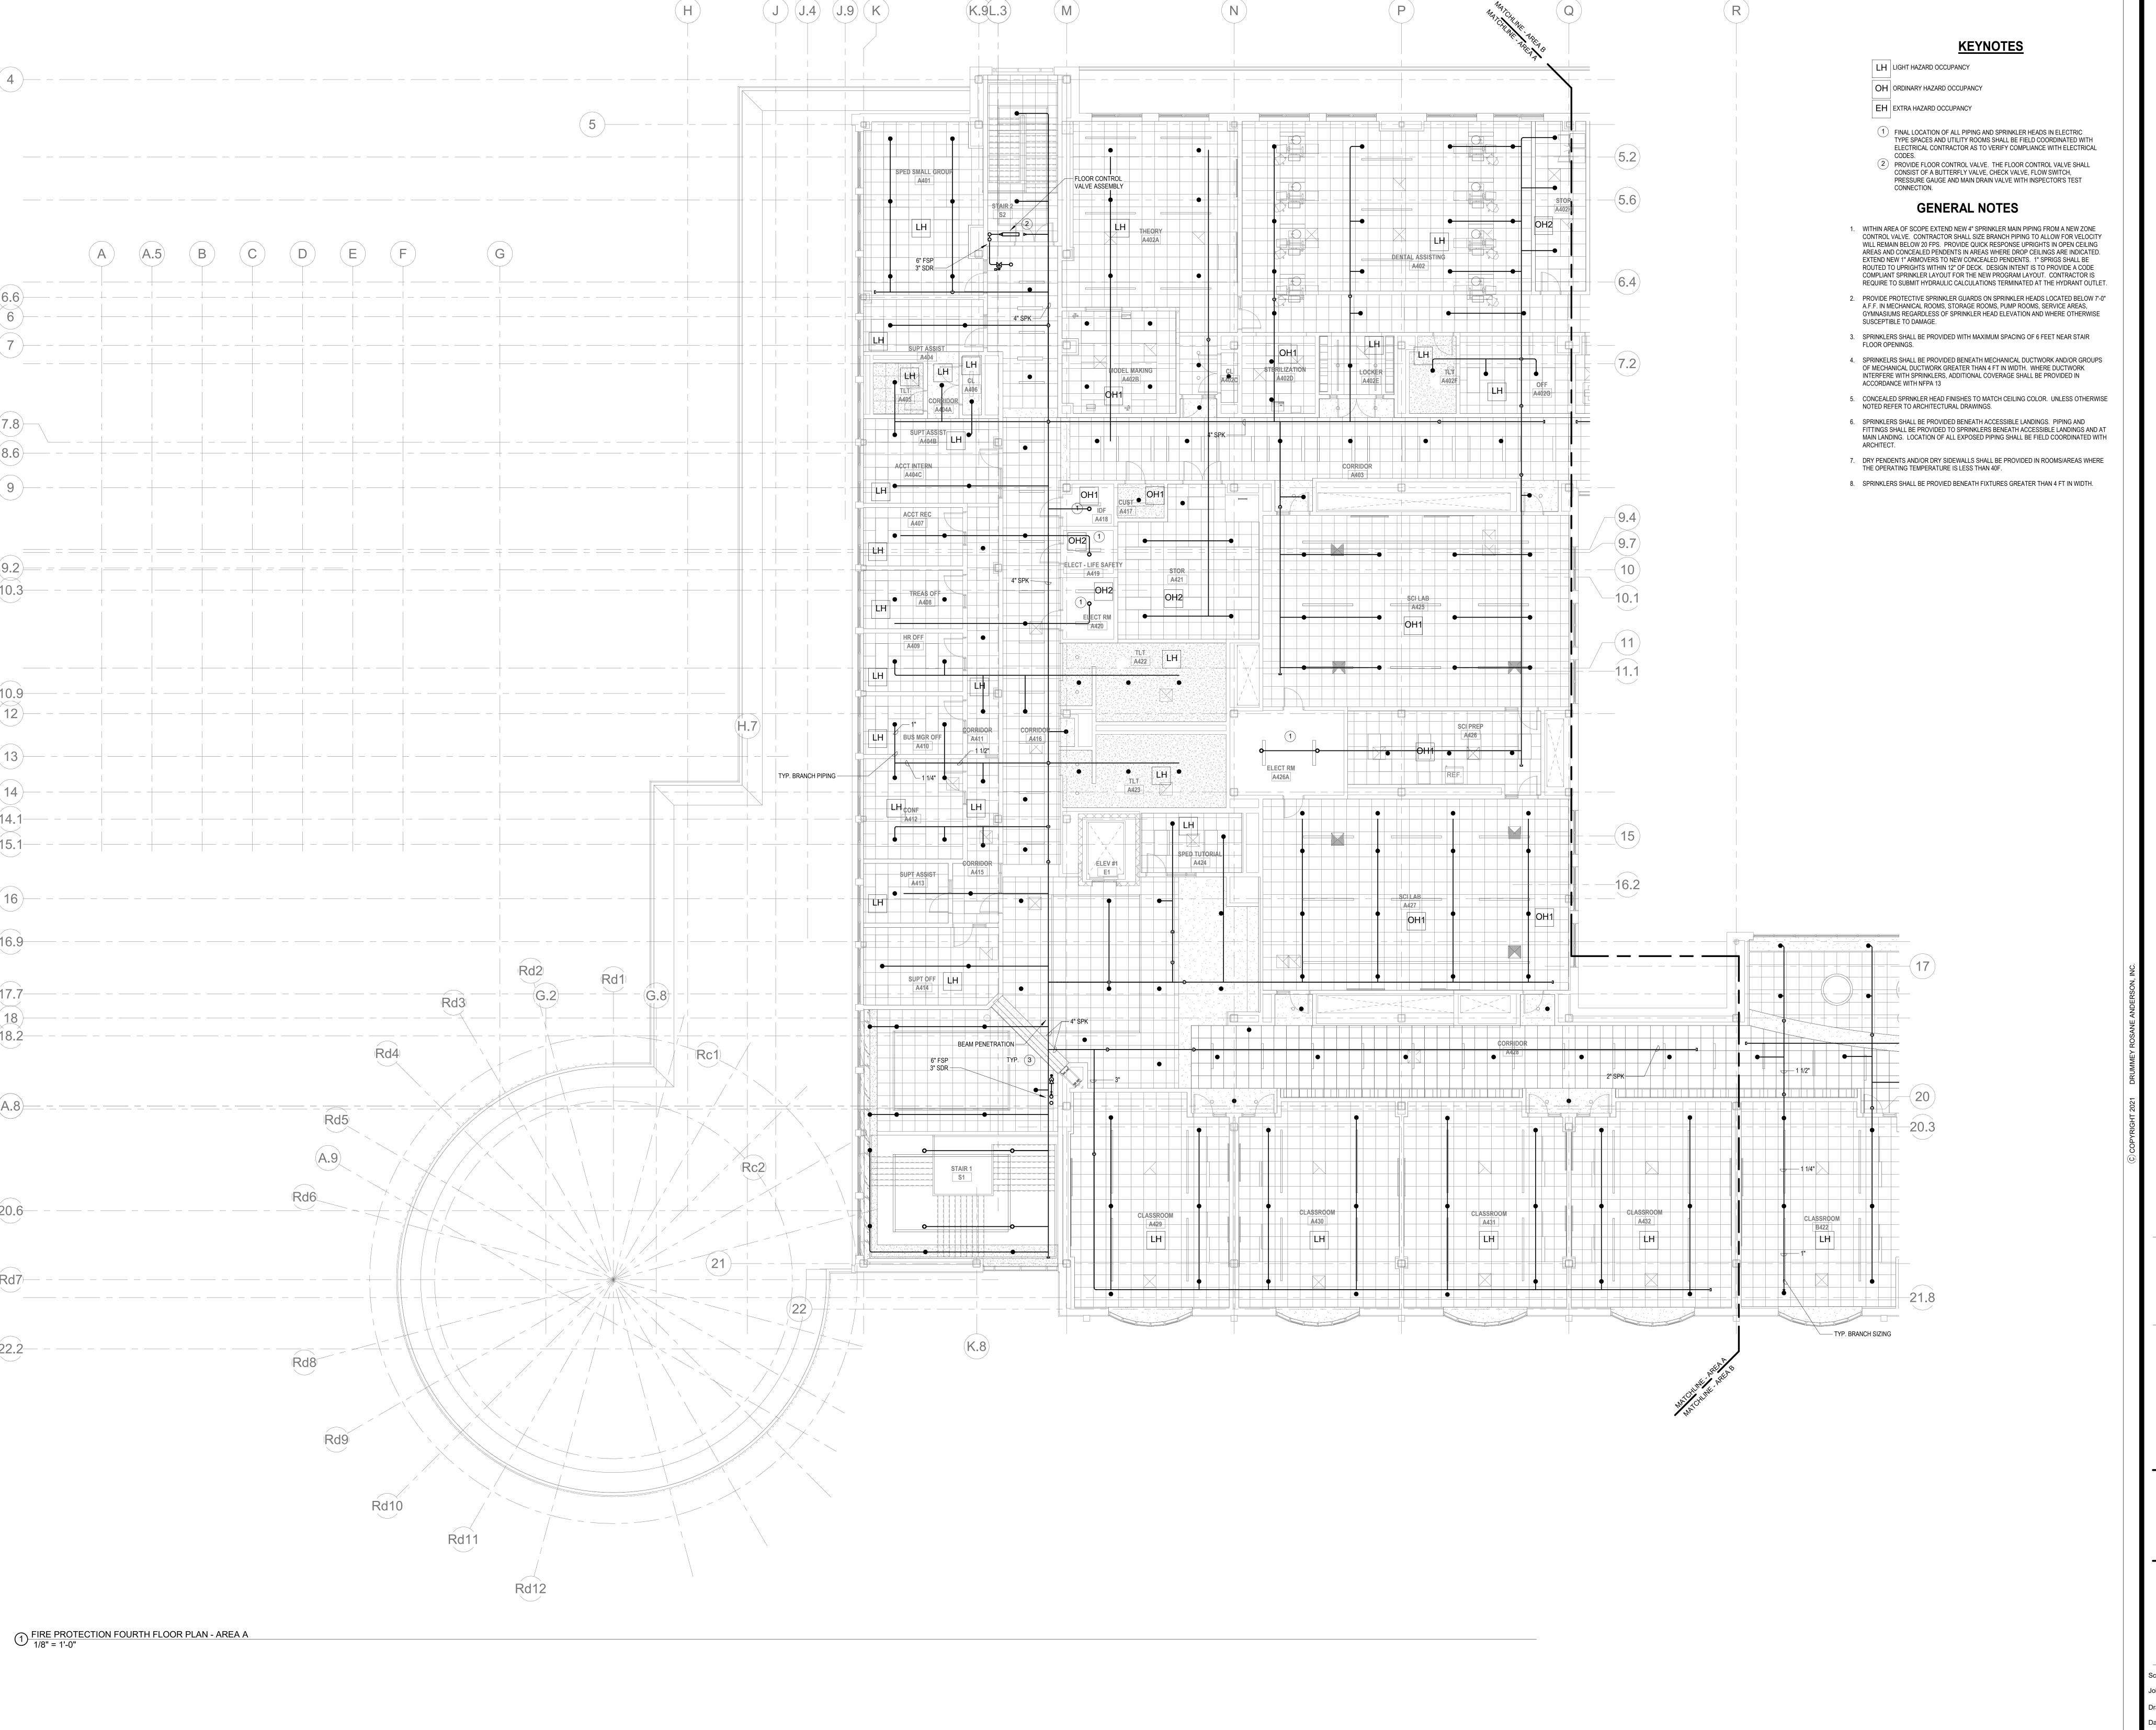

DRA

Drummey Rosane Anderson, Inc.

225 Oakland Road 260 Charles Street

Studio 205
South Windsor, CT
06074

Planning | Architecture | Interior Design
Tel: 617.964.1700

Northeast Metropolitan Regional Vocational High School

www.draws.com

Wakefield, MA 01880

ENGINEERS, INC.

1-1306


FAX: 617 357 5188

PHLADELPHA | NEW YORK |

MECHANICAL | ELECTRIC STRUCTURAL | TECHNOL


MSBA 60% CD SUBMISSION

January 13, 2023

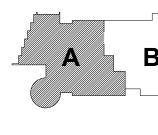

KEY PLAN

RTH MAGNETIC

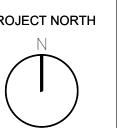


FIRE PROTECTION FOURTH FLOOR PLAN - AREA A

Scale: 1/8" = 1'-0"

Job No.: 20202

Drawn By: DRA

FP1-1-4A

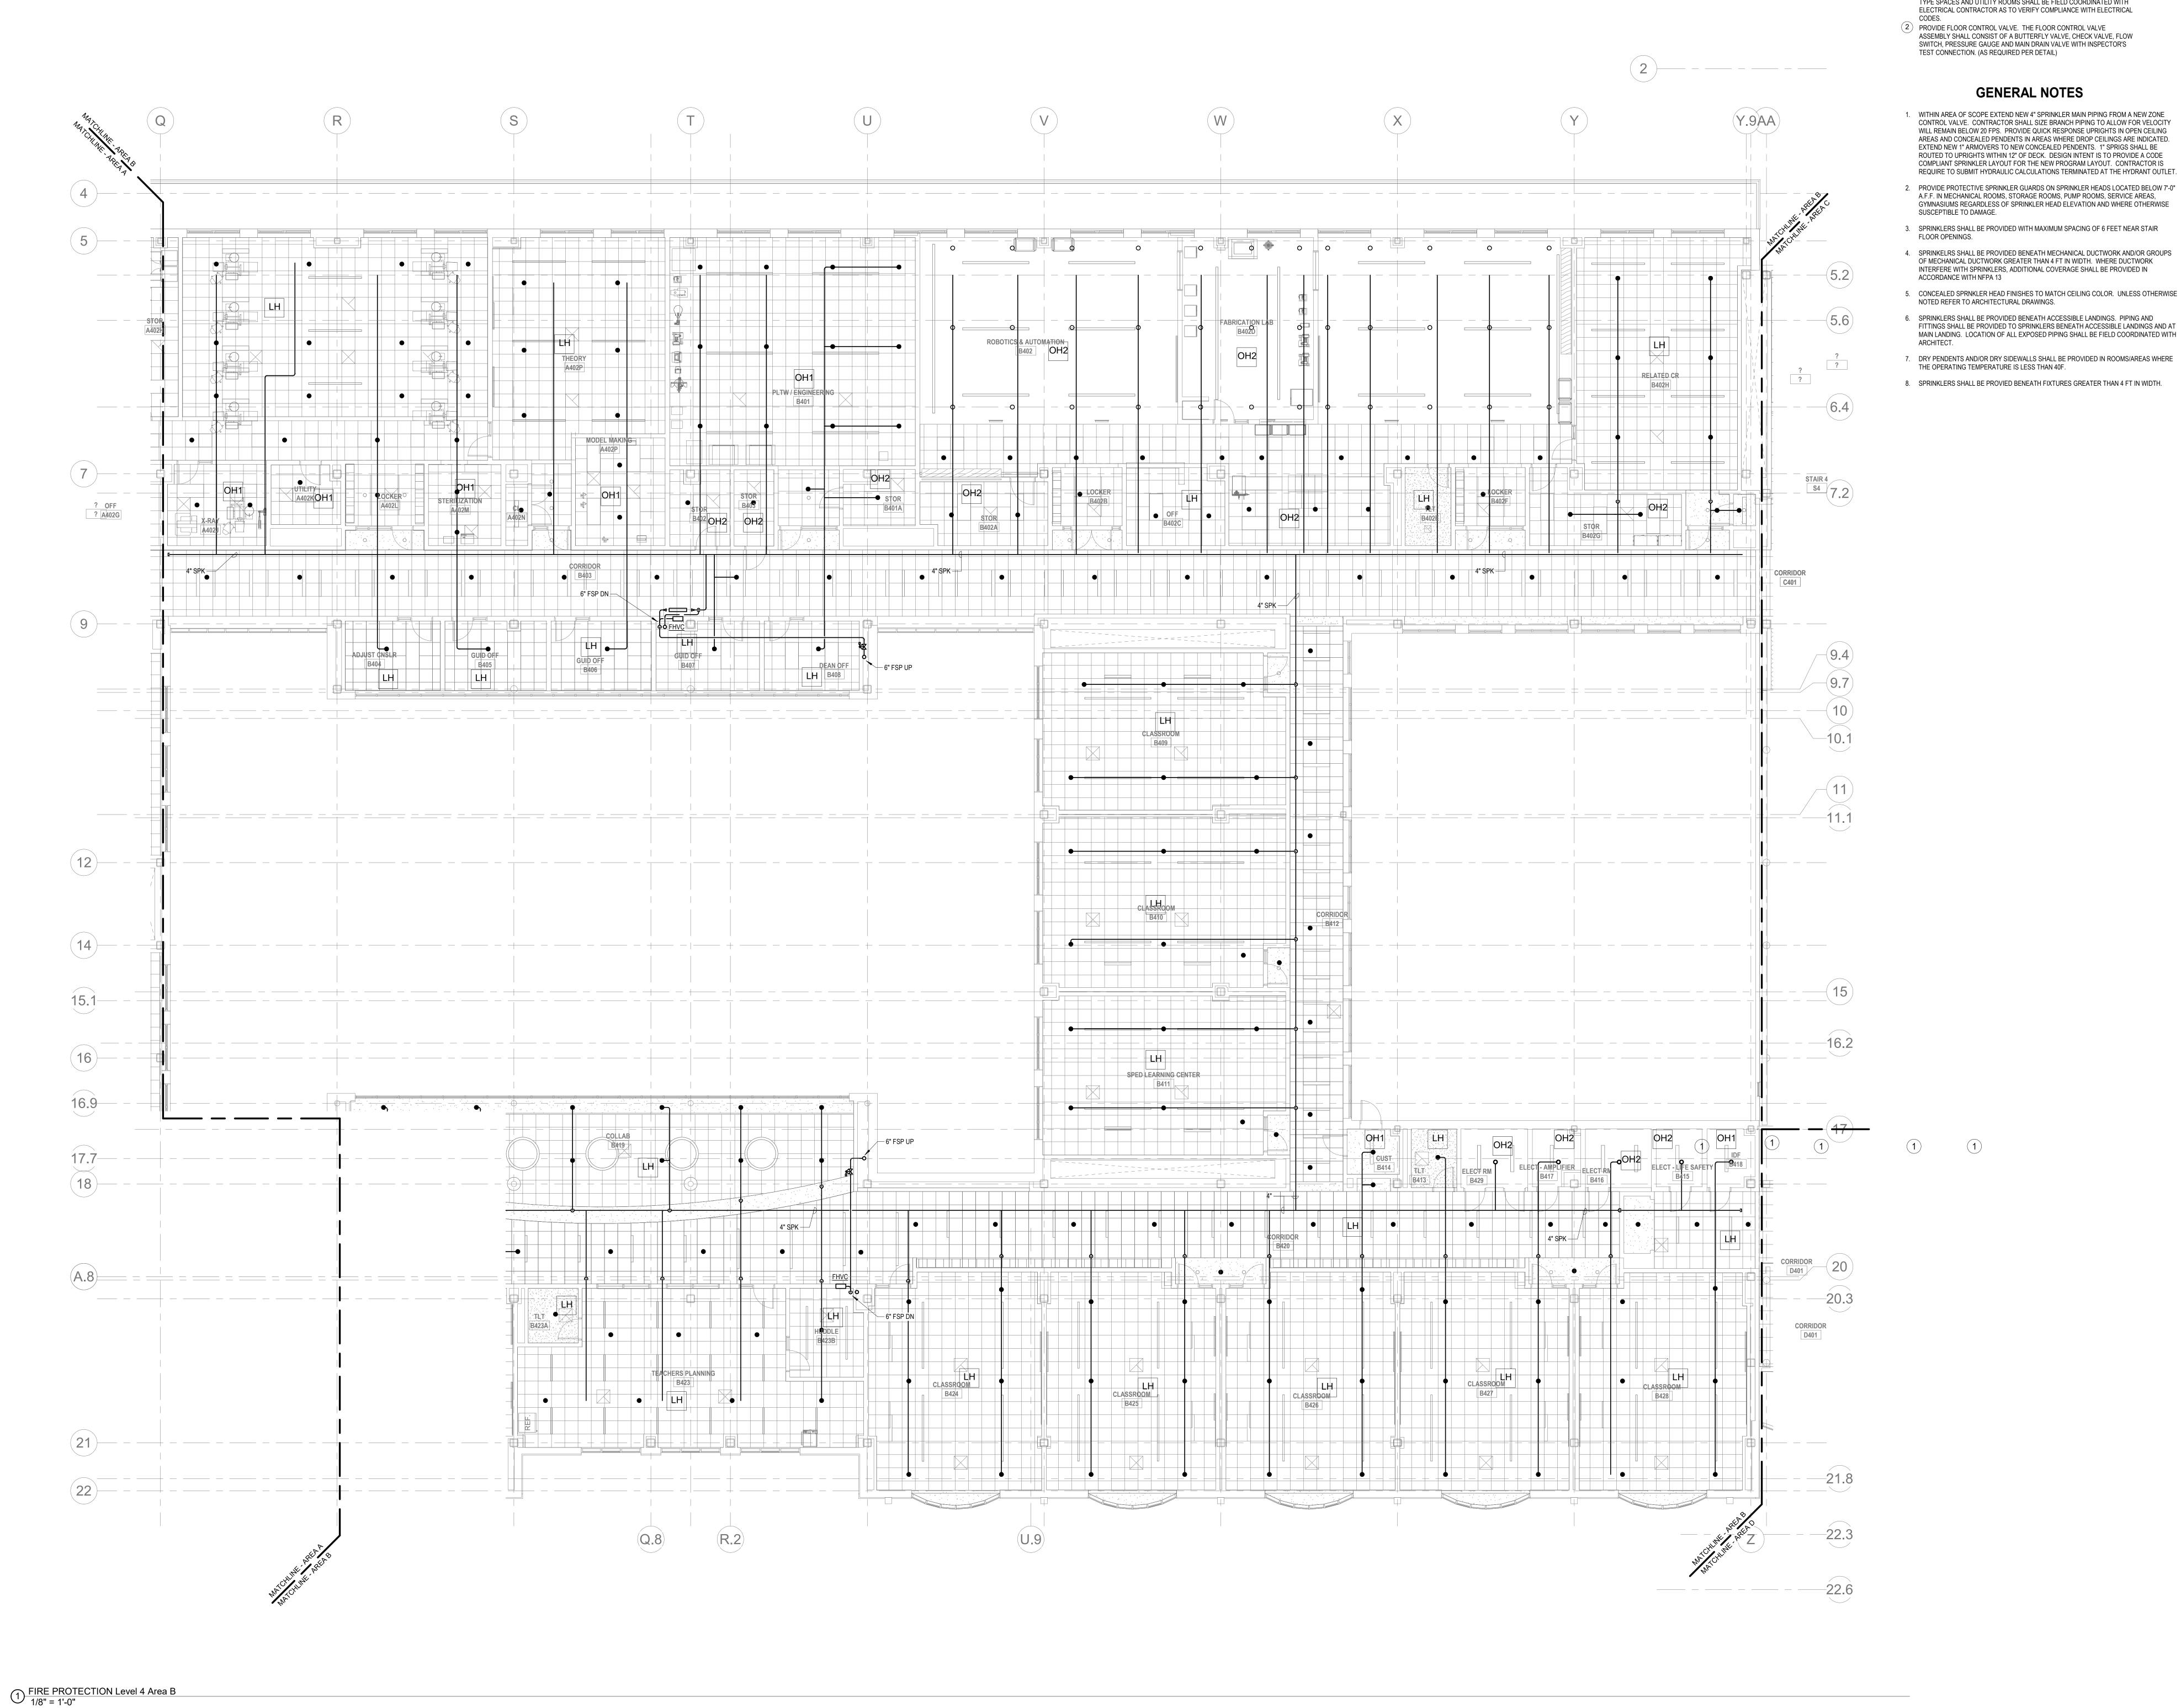

KEYNOTES (LH) LIGHT HAZARD OCCUPANCY

- OH) ORDINARY HAZARD OCCUPANCY
- EH) EXTRA HAZARD OCCUPANCY
- 1 FINAL LOCATION OF ALL PIPING AND SPRINKLER HEADS IN ELECTRIC TYPE SPACES AND UTILITY ROOMS SHALL BE FIELD COORDINATED WITH
- 2) PROVIDE FLOOR CONTROL VALVE. THE FLOOR CONTROL VALVE ASSEMBLY SHALL CONSIST OF A BUTTERFLY VALVE, CHECK VALVE, FLOW SWITCH, PRESSURE GAUGE AND MAIN DRAIN VALVE WITH INSPECTOR'S

GENERAL NOTES

- 1. WITHIN AREA OF SCOPE EXTEND NEW 4" SPRINKLER MAIN PIPING FROM A NEW ZONE CONTROL VALVE. CONTRACTOR SHALL SIZE BRANCH PIPING TO ALLOW FOR VELOCITY WILL REMAIN BELOW 20 FPS. PROVIDE QUICK RESPONSE UPRIGHTS IN OPEN CEILING AREAS AND CONCEALED PENDENTS IN AREAS WHERE DROP CEILINGS ARE INDICATED. EXTEND NEW 1" ARMOVERS TO NEW CONCEALED PENDENTS. 1" SPRIGS SHALL BE ROUTED TO UPRIGHTS WITHIN 12" OF DECK. DESIGN INTENT IS TO PROVIDE A CODE COMPLIANT SPRINKLER LAYOUT FOR THE NEW PROGRAM LAYOUT. CONTRACTOR IS REQUIRE TO SUBMIT HYDRAULIC CALCULATIONS TERMINATED AT THE HYDRANT OUTLET.
- 2. PROVIDE PROTECTIVE SPRINKLER GUARDS ON SPRINKLER HEADS LOCATED BELOW 7'-0" A.F.F. IN MECHANICAL ROOMS, STORAGE ROOMS, PUMP ROOMS, SERVICE AREAS, GYMNASIUMS REGARDLESS OF SPRINKLER HEAD ELEVATION AND WHERE OTHERWISE
- 3. SPRINKLERS SHALL BE PROVIDED WITH MAXIMUM SPACING OF 6 FEET NEAR STAIR
- OF MECHANICAL DUCTWORK GREATER THAN 4 FT IN WIDTH. WHERE DUCTWORK INTERFERE WITH SPRINKLERS, ADDITIONAL COVERAGE SHALL BE PROVIDED IN
- NOTED REFER TO ARCHITECTURAL DRAWINGS. 6. SPRINKLERS SHALL BE PROVIDED BENEATH ACCESSIBLE LANDINGS. PIPING AND
- FITTINGS SHALL BE PROVIDED TO SPRINKLERS BENEATH ACCESSIBLE LANDINGS AND AT MAIN LANDING. LOCATION OF ALL EXPOSED PIPING SHALL BE FIELD COORDINATED WITH

Drummey Rosane Anderson, Inc.

225 Oakland Road 260 Charles Street Studio 205 Studio 300 South Windsor, CT Waltham, MA

Planning | Architecture | Interior Design Tel: 617.964.1700 www.draws.com


Northeast Metropolitan Regional Vocational High School

Wakefield, MA 01880

January 13, 2023

MSBA 60% CD


SUBMISSION

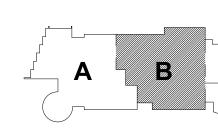

KEY PLAN

MAGNETIC NORTH

PROTECTION FOURTH FLOOR PLAN - AREA B

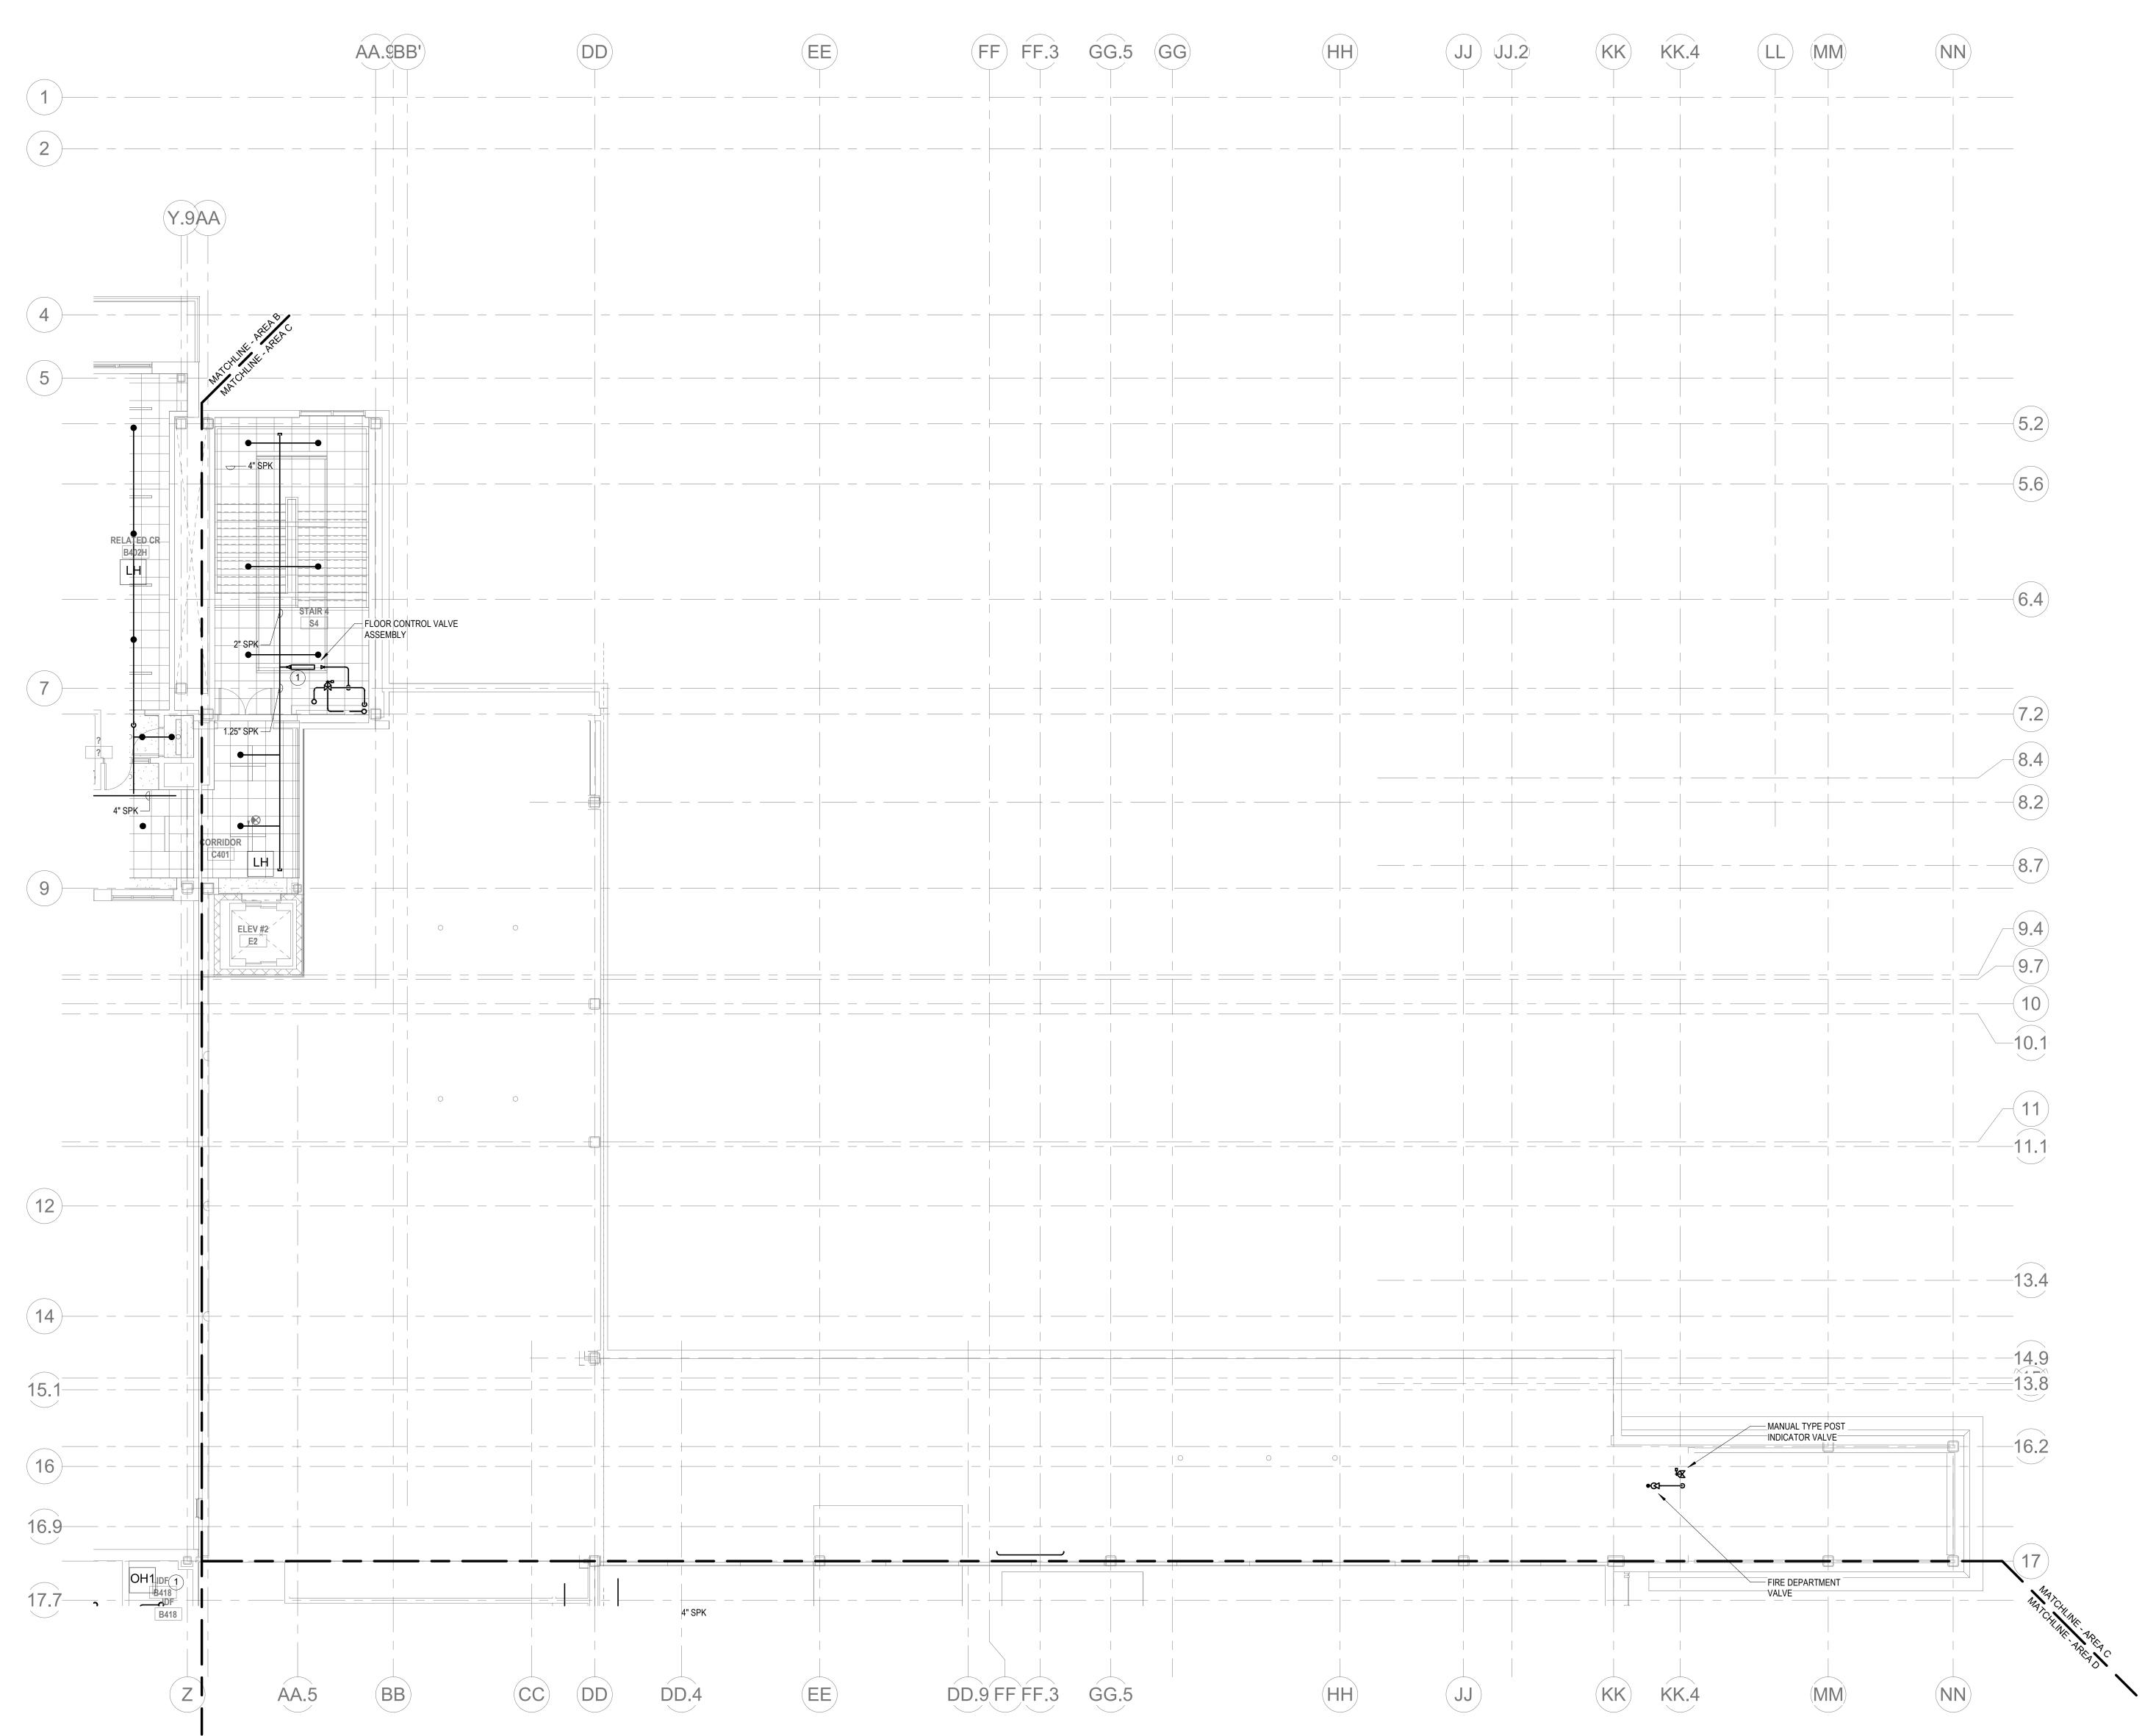

1/8" = 1'-0"

<u>KEYNOTES</u> (LH) LIGHT HAZARD OCCUPANCY

- OH) ORDINARY HAZARD OCCUPANCY
- (EH) EXTRA HAZARD OCCUPANCY
- 1) PROVIDE FLOOR CONTROL VALVE. THE FLOOR CONTROL VALVE ASSEMBLY SHALL CONSIST OF A BUTTERFLY VALVE, CHECK VALVE, FLOW SWITCH, PRESSURE GAUGE AND MAIN DRAIN VALVE WITH INSPECTOR'S TEST CONNECTION. (AS REQUIRED PER DETAIL)

GENERAL NOTES

- 1. WITHIN AREA OF SCOPE EXTEND NEW 4" SPRINKLER MAIN PIPING FROM A NEW ZONE CONTROL VALVE. CONTRACTOR SHALL SIZE BRANCH PIPING TO ALLOW FOR VELOCITY WILL REMAIN BELOW 20 FPS. PROVIDE QUICK RESPONSE UPRIGHTS IN OPEN CEILING AREAS AND CONCEALED PENDENTS IN AREAS WHERE DROP CEILINGS ARE INDICATED. EXTEND NEW 1" ARMOVERS TO NEW CONCEALED PENDENTS. 1" SPRIGS SHALL BE ROUTED TO UPRIGHTS WITHIN 12" OF DECK. DESIGN INTENT IS TO PROVIDE A CODE COMPLIANT SPRINKLER LAYOUT FOR THE NEW PROGRAM LAYOUT. CONTRACTOR IS REQUIRE TO SUBMIT HYDRAULIC CALCULATIONS TERMINATED AT THE HYDRANT OUTLET.
- 2. PROVIDE PROTECTIVE SPRINKLER GUARDS ON SPRINKLER HEADS LOCATED BELOW 7'-0" A.F.F. IN MECHANICAL ROOMS, STORAGE ROOMS, PUMP ROOMS, SERVICE AREAS, GYMNASIUMS REGARDLESS OF SPRINKLER HEAD ELEVATION AND WHERE OTHERWISE SUSCEPTIBLE TO DAMAGE.
- 3. SPRINKLERS SHALL BE PROVIDED WITH MAXIMUM SPACING OF 6 FEET NEAR STAIR FLOOR OPENINGS.
- 4. SPRINKELRS SHALL BE PROVIDED BENEATH MECHANICAL DUCTWORK AND/OR GROUPS OF MECHANICAL DUCTWORK GREATER THAN 4 FT IN WIDTH. WHERE DUCTWORK INTERFERE WITH SPRINKLERS, ADDITIONAL COVERAGE SHALL BE PROVIDED IN ACCORDANCE WITH NFPA 13

5. CONCEALED SPRNKLER HEAD FINISHES TO MATCH CEILING COLOR. UNLESS OTHERWISE

- NOTED REFER TO ARCHITECTURAL DRAWINGS. 6. SPRINKLERS SHALL BE PROVIDED BENEATH ACCESSIBLE LANDINGS. PIPING AND FITTINGS SHALL BE PROVIDED TO SPRINKLERS BENEATH ACCESSIBLE LANDINGS AND AT MAIN LANDING. LOCATION OF ALL EXPOSED PIPING SHALL BE FIELD COORDINATED WITH
- 7. DRY PENDENTS AND/OR DRY SIDEWALLS SHALL BE PROVIDED IN ROOMS/AREAS WHERE THE OPERATING TEMPERATURE IS LESS THAN 40F.
- 8. SPRINKLERS SHALL BE PROVIED BENEATH FIXTURES GREATER THAN 4 FT IN WIDTH.



225 Oakland Road 260 Charles Street Studio 205 Studio 300 South Windsor, CT Waltham, MA 06074 02453 Planning | Architecture | Interior Design Tel: 617.964.1700 www.draws.com

Northeast

Drummey Rosane Anderson, Inc.


Metropolitan Regional Vocational High

Wakefield, MA 01880

PHILADELPHIA | NEW YORK | BOSTON | BALTIMORE | WASHINGTON, DC MECHANICAL | ELECTRICAL | PLUMBING | FIRE PROTECTION STRUCTURAL | TECHNOLOGY | COMMISSIONING


MSBA 60% CD SUBMISSION

January 13, 2023

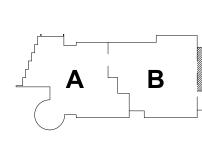



PROTECTION FOURTH FLOOR PLAN - AREA C

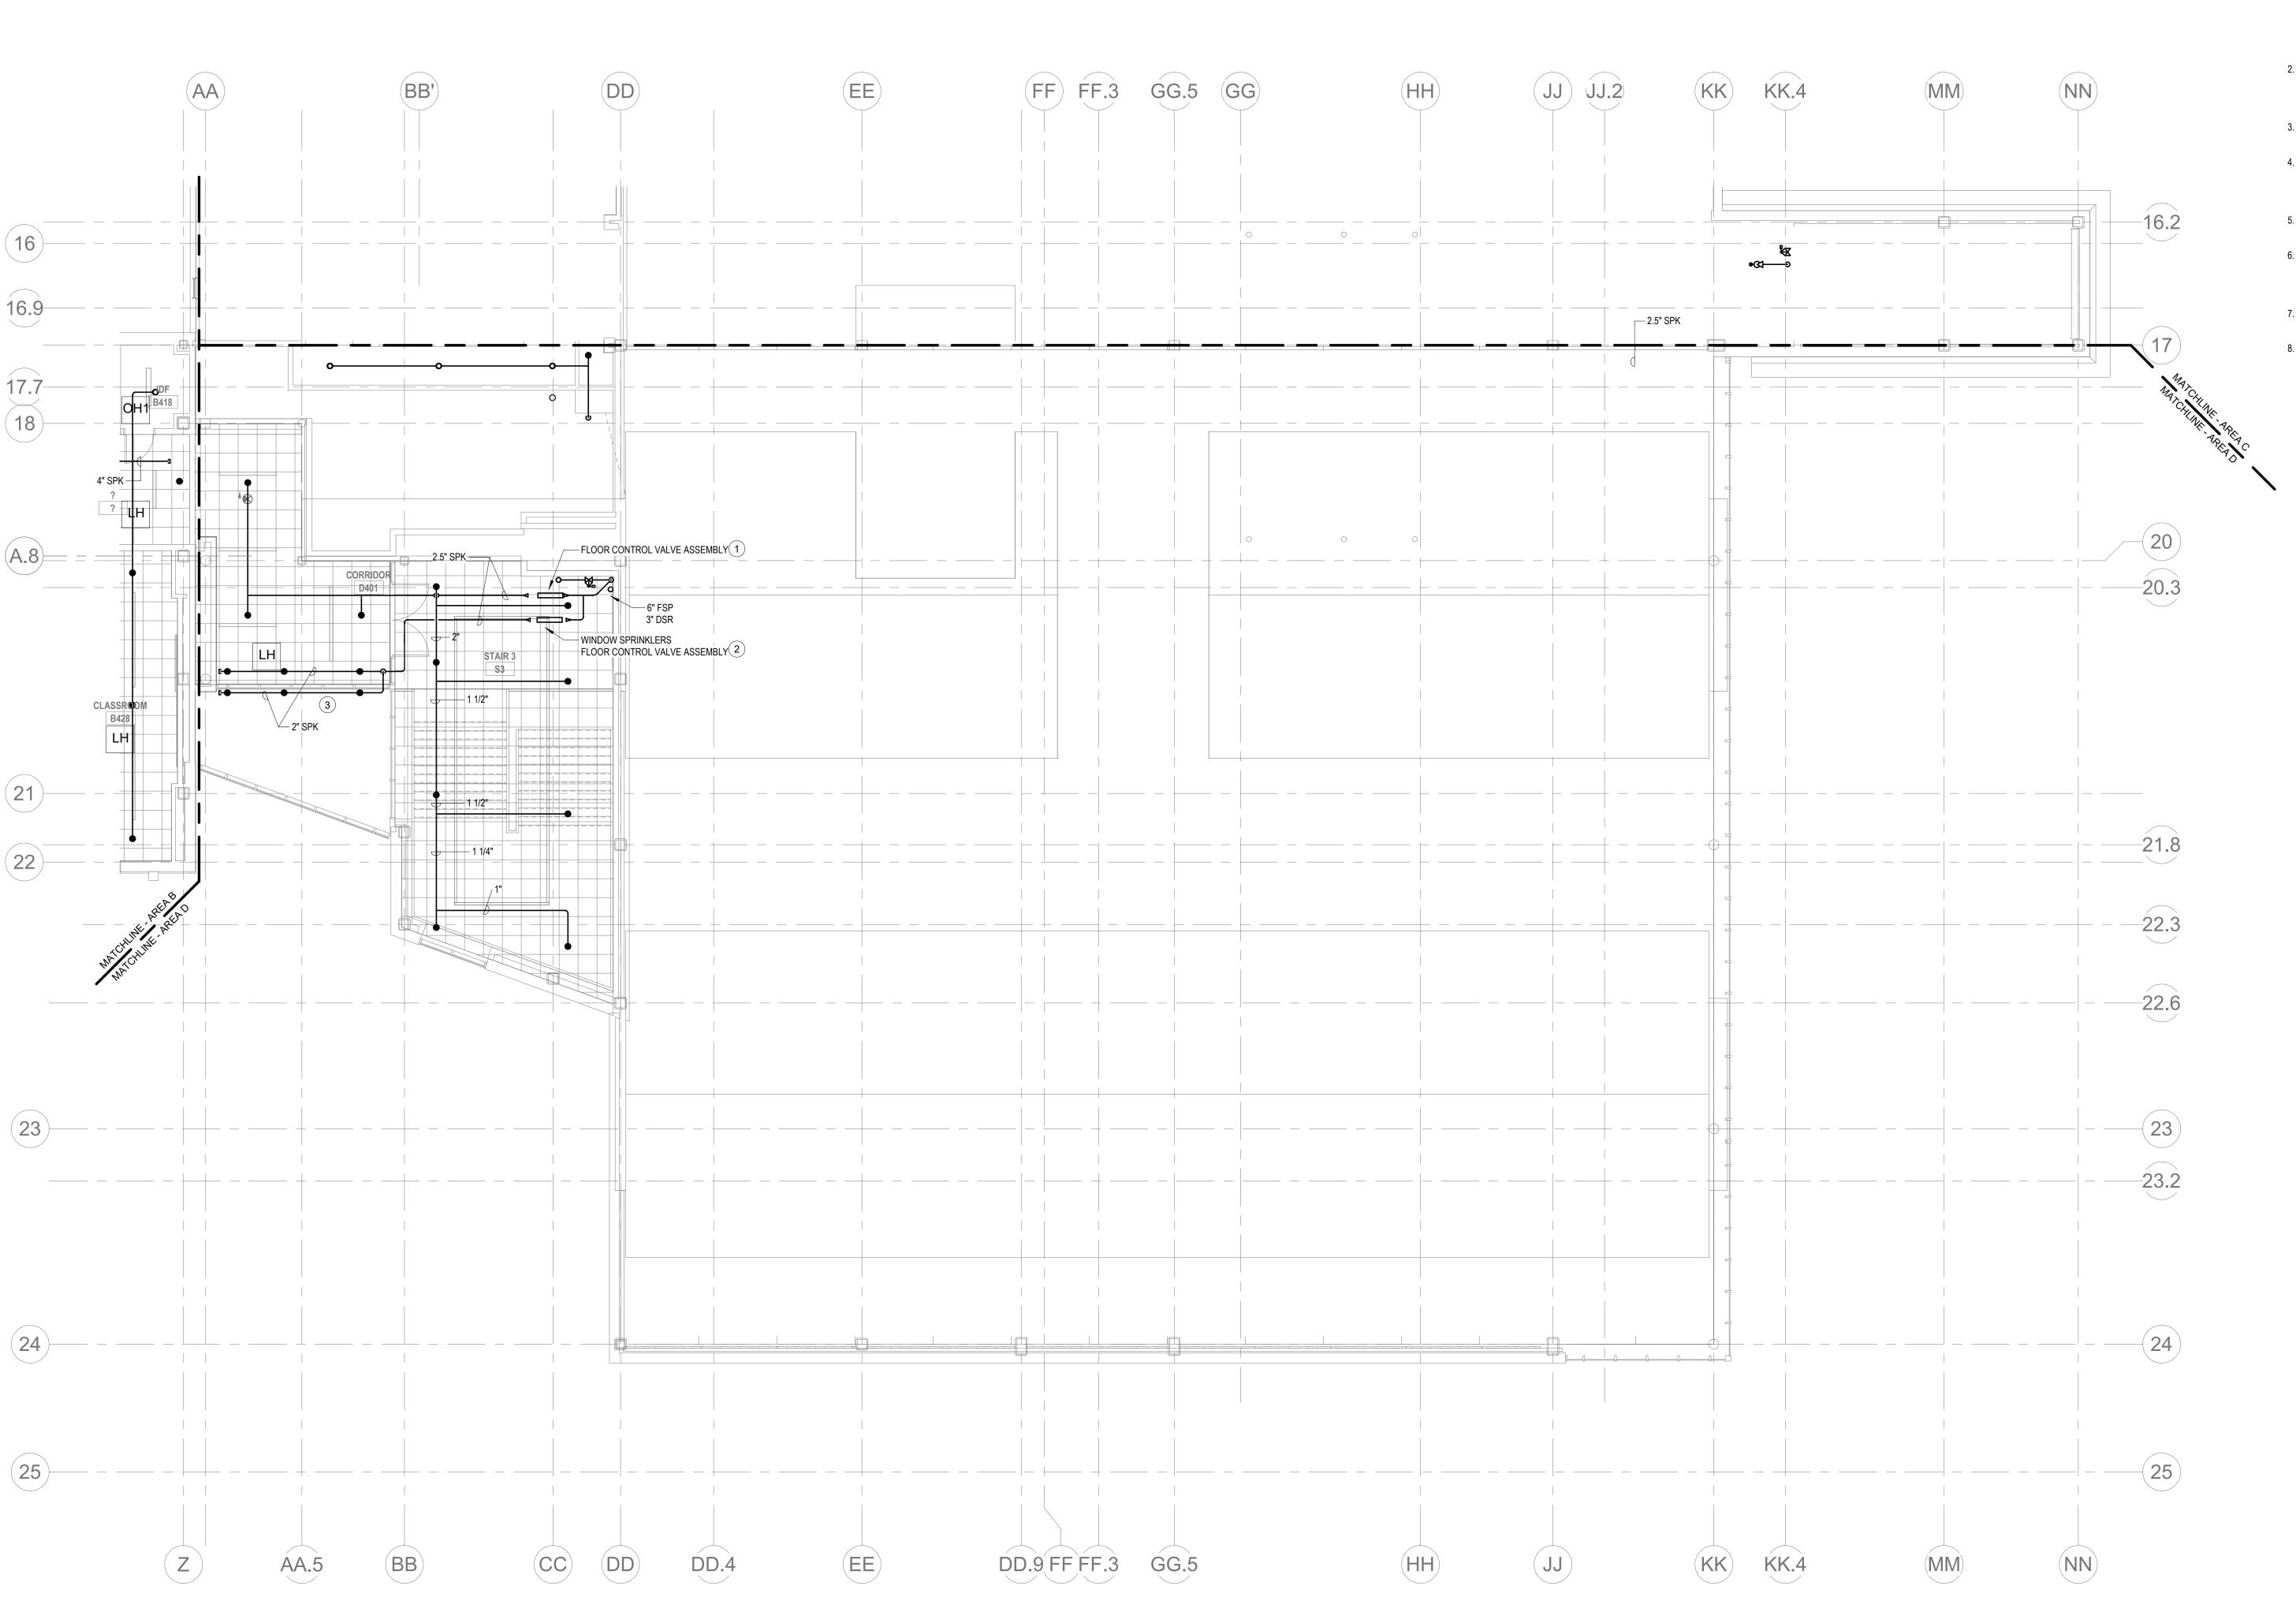

FIRE PROTECTION Level 4 Area D
1/8" = 1'-0"

KEYNOTES

- (LH) LIGHT HAZARD OCCUPANCY
- OH) ORDINARY HAZARD OCCUPANCY
- EH) EXTRA HAZARD OCCUPANCY
- (1) PROVIDE 2.5" FLOOR CONTROL VALVE. THE FLOOR CONTROL VALVE ASSEMBLY SHALL CONSIST OF A BUTTERFLY VALVE, CHECK VALVE, FLOW SWITCH, PRESSURE GAUGE AND MAIN DRAIN VALVE WITH INSPECTOR'S TEST CONNECTION. (AS REQUIRED PER DETAIL)
- PROVIDE 2.5" FLOOR CONTROL VALVE FOR THE WINDOW SPRINKLERS. THE FLOOR CONTROL VALVE SHALL CONSIST OF A BUTTERFLY VALVE, CHECK VALVE, FLOW SWITCH, PRESSURE GAUGE AND MAIN DRAIN VALVE
- 3 PROVIDE WINDOW SPRINKLERS WITHIN 2 IN. OF THE GLASS PARTITIONS IN ACCORDANCE WITH NFPA 13 TABLE 7.8.8.4. THESE SPRINLERS SHALL BE SPACED NOT MORE THAN 10 FT FROM EACH OTHER.

WITH INSPECTOR'S TEST CONNECTION.

GENERAL NOTES

1. WITHIN AREA OF SCOPE EXTEND NEW 4" SPRINKLER MAIN PIPING FROM A NEW ZONE CONTROL VALVE. CONTRACTOR SHALL SIZE BRANCH PIPING TO ALLOW FOR VELOCITY WILL REMAIN BELOW 20 FPS. PROVIDE QUICK RESPONSE UPRIGHTS IN OPEN CEILING AREAS AND CONCEALED PENDENTS IN AREAS WHERE DROP CEILINGS ARE INDICATED. EXTEND NEW 1" ARMOVERS TO NEW CONCEALED PENDENTS. 1" SPRIGS SHALL BE ROUTED TO UPRIGHTS WITHIN 12" OF DECK. DESIGN INTENT IS TO PROVIDE A CODE COMPLIANT SPRINKLER LAYOUT FOR THE NEW PROGRAM LAYOUT. CONTRACTOR IS REQUIRE TO SUBMIT HYDRAULIC CALCULATIONS TERMINATED AT THE HYDRANT OUTLET.

- 2. PROVIDE PROTECTIVE SPRINKLER GUARDS ON SPRINKLER HEADS LOCATED BELOW 7'-0" A.F.F. IN MECHANICAL ROOMS, STORAGE ROOMS, PUMP ROOMS, SERVICE AREAS, GYMNASIUMS REGARDLESS OF SPRINKLER HEAD ELEVATION AND WHERE OTHERWISE SUSCEPTIBLE TO DAMAGE.
- 3. SPRINKLERS SHALL BE PROVIDED WITH MAXIMUM SPACING OF 6 FEET NEAR STAIR FLOOR OPENINGS.
- 4. SPRINKELRS SHALL BE PROVIDED BENEATH MECHANICAL DUCTWORK AND/OR GROUPS OF MECHANICAL DUCTWORK GREATER THAN 4 FT IN WIDTH. WHERE DUCTWORK INTERFERE WITH SPRINKLERS, ADDITIONAL COVERAGE SHALL BE PROVIDED IN ACCORDANCE WITH NFPA 13
- 5. CONCEALED SPRNKLER HEAD FINISHES TO MATCH CEILING COLOR. UNLESS OTHERWISE NOTED REFER TO ARCHITECTURAL DRAWINGS.
- 6. SPRINKLERS SHALL BE PROVIDED BENEATH ACCESSIBLE LANDINGS. PIPING AND FITTINGS SHALL BE PROVIDED TO SPRINKLERS BENEATH ACCESSIBLE LANDINGS AND AT MAIN LANDING. LOCATION OF ALL EXPOSED PIPING SHALL BE FIELD COORDINATED WITH ARCHITECT.
- 7. DRY PENDENTS AND/OR DRY SIDEWALLS SHALL BE PROVIDED IN ROOMS/AREAS WHERE THE OPERATING TEMPERATURE IS LESS THAN 40F. 8. SPRINKLERS SHALL BE PROVIED BENEATH FIXTURES GREATER THAN 4 FT IN WIDTH.

Drummey Rosane Anderson, Inc.

Studio 205

06074

South Windsor, CT

225 Oakland Road 260 Charles Street

Planning | Architecture | Interior Design Tel: 617.964.1700

www.draws.com

Northeast

Studio 300

Waltham, MA


Metropolitan Regional Vocational High


Wakefield, MA 01880

PHILADELPHIA | NEW YORK | BOSTON | BALTIMORE | WASHINGTON, DC

MSBA 60% CD SUBMISSION

January 13, 2023

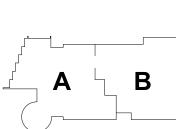

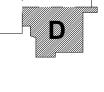

KEY PLAN


PROJECT NORTH

MAGNETIC NORTH

PROTECTION FOURTH FLOOR PLAN - AREA D

Drawn By: DRA

FP1-1-4D

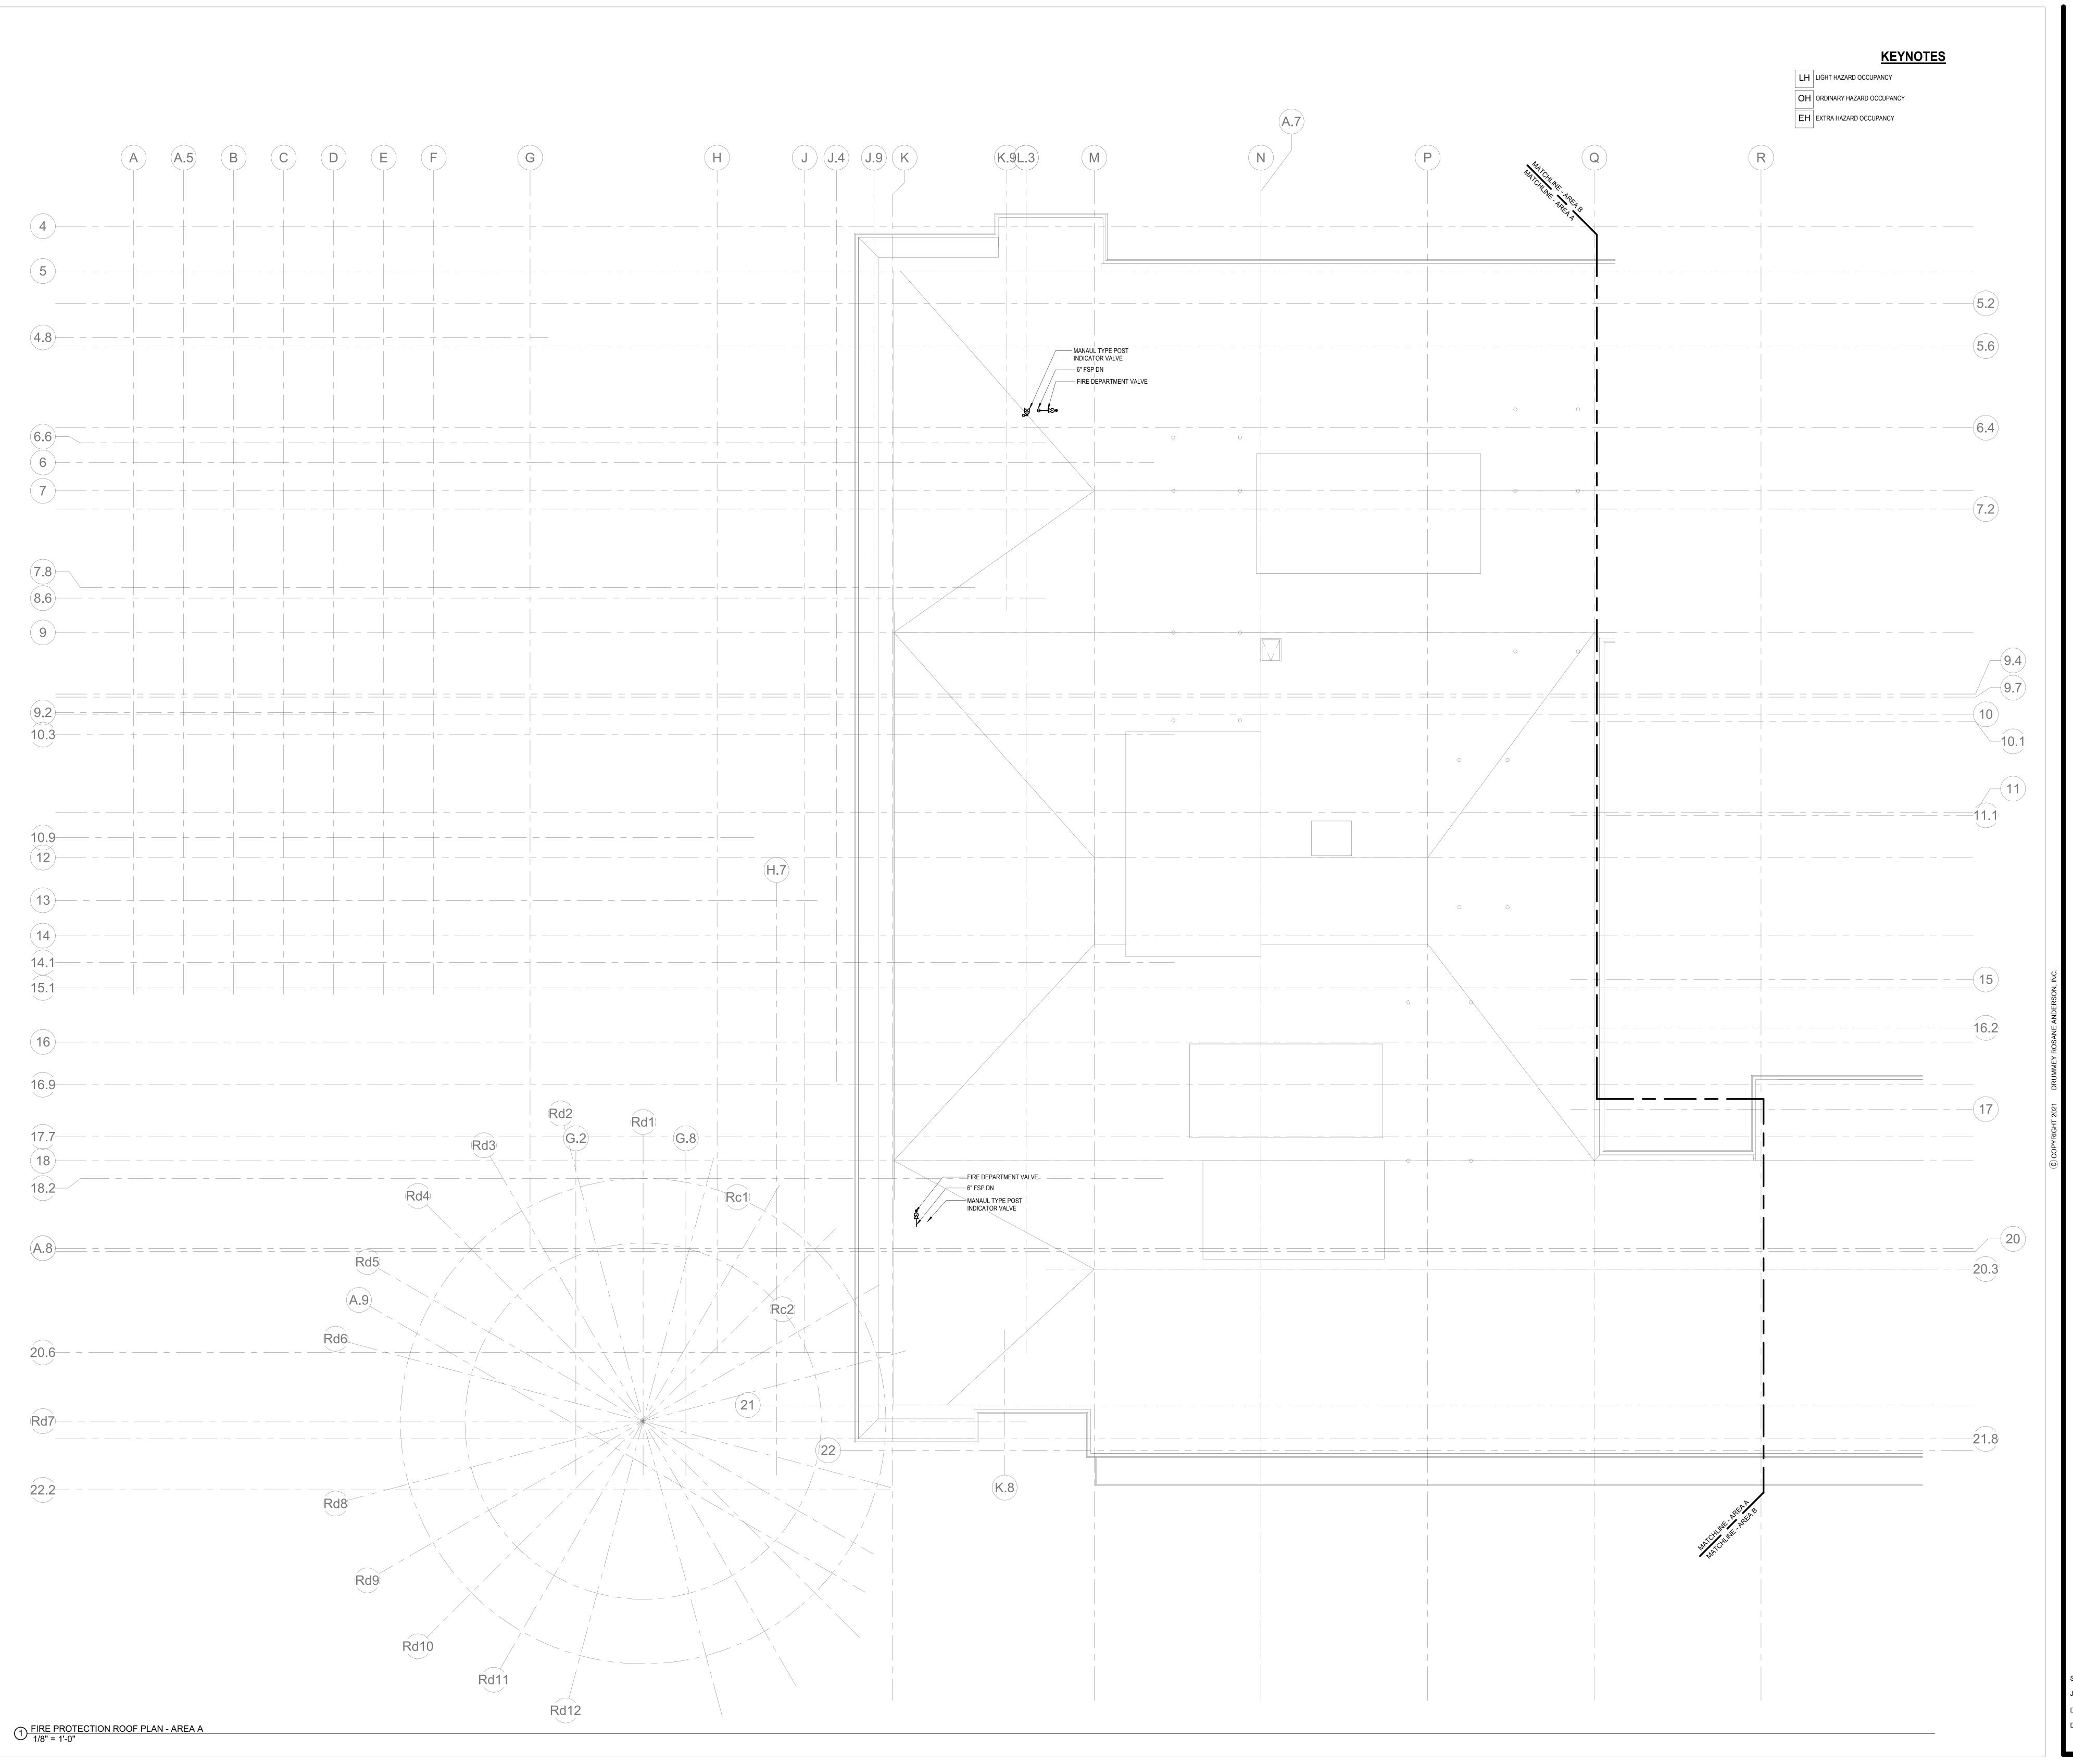



Drummey Rosane Anderson, Inc.

225 Oakland Road
Studio 205
South Windsor, CT
06074

260 Charles Street
Studio 300
Waltham, MA
02453

nning | Architecture | Interior Desi

Tel: 617.964.1700

www.draws.com

Northeast Metropolitan Regional Vocational High School

Wakefield, MA 01880

ENGINEERS, INC.


1306

FAX: 617 357 5188

PHLAGELPHA | NEW YORK | BOSTON | BALTINC
MECHANICAL | ELECTRICAL | PLUMBING |
STRUCTURAL | TECHNICOSY | COMMISSIO

MSBA 60% CD SUBMISSION


January 13, 2023

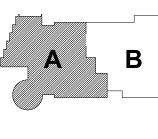

KEY PLAN

KEY PLAN

TH MAGNETIC NO

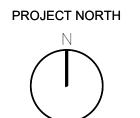

FIRE ROTECTION OOF PLAN

PROTECTION ROOF PLAN -AREA A

Scale: 1/8" = 1'-0'

Job No.: 20202

Drawn By: DRA

FP1-2-1A

Drummey Rosane Anderson, Inc. 225 Oakland Road Studio 205 South Windsor, CT 06074 260 Charles Street Studio 300 Waltham, MA 02453 Planning | Architecture | Interior Design Tel: 617.964.1700 www.draws.com **Northeast** Metropolitan Regional Vocational High School Wakefield, MA 01880

KEYNOTES

LH LIGHT HAZARD OCCUPANCY

OH ORDINARY HAZARD OCCUPANCY


EH EXTRA HAZARD OCCUPANCY

NSULTING ENGINEERS, INC.
LE PLACE
MA 02111-1306
337 6060 FAX: 617 357 5188
LA.COM

MECHANICAL | ELECTRICAL | PLUMBING | FREE PROTECTION
STRUCTURAL | ELECTRICAL | PLUMBING | FREE PROTECTION
STRUCTURAL | ELECTRICAL | PLUMBING | FREE PROTECTION

MSBA 60% CD SUBMISSION

January 13, 2023

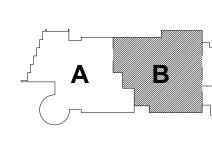

D

KEY PLAN

TH MAGNETIC NO

PROJECT NORTH

FIRE

PROTECTION ROOF PLAN -AREA B

Scale: 1/8" = 1'-0'

Job No.: 20202

Drawn By: DRA

D:: 20202

By: DRA

January 13, 2023


MANUAL TYPE POST = INDICATOR VALVE

MANUAL TYPE POST INDICATOR VALVE

6" FSP DN

FIRE DEPARTMENT

- LH LIGHT HAZARD OCCUPANCY
- OH ORDINARY HAZARD OCCUPANCY
- EH EXTRA HAZARD OCCUPANCY

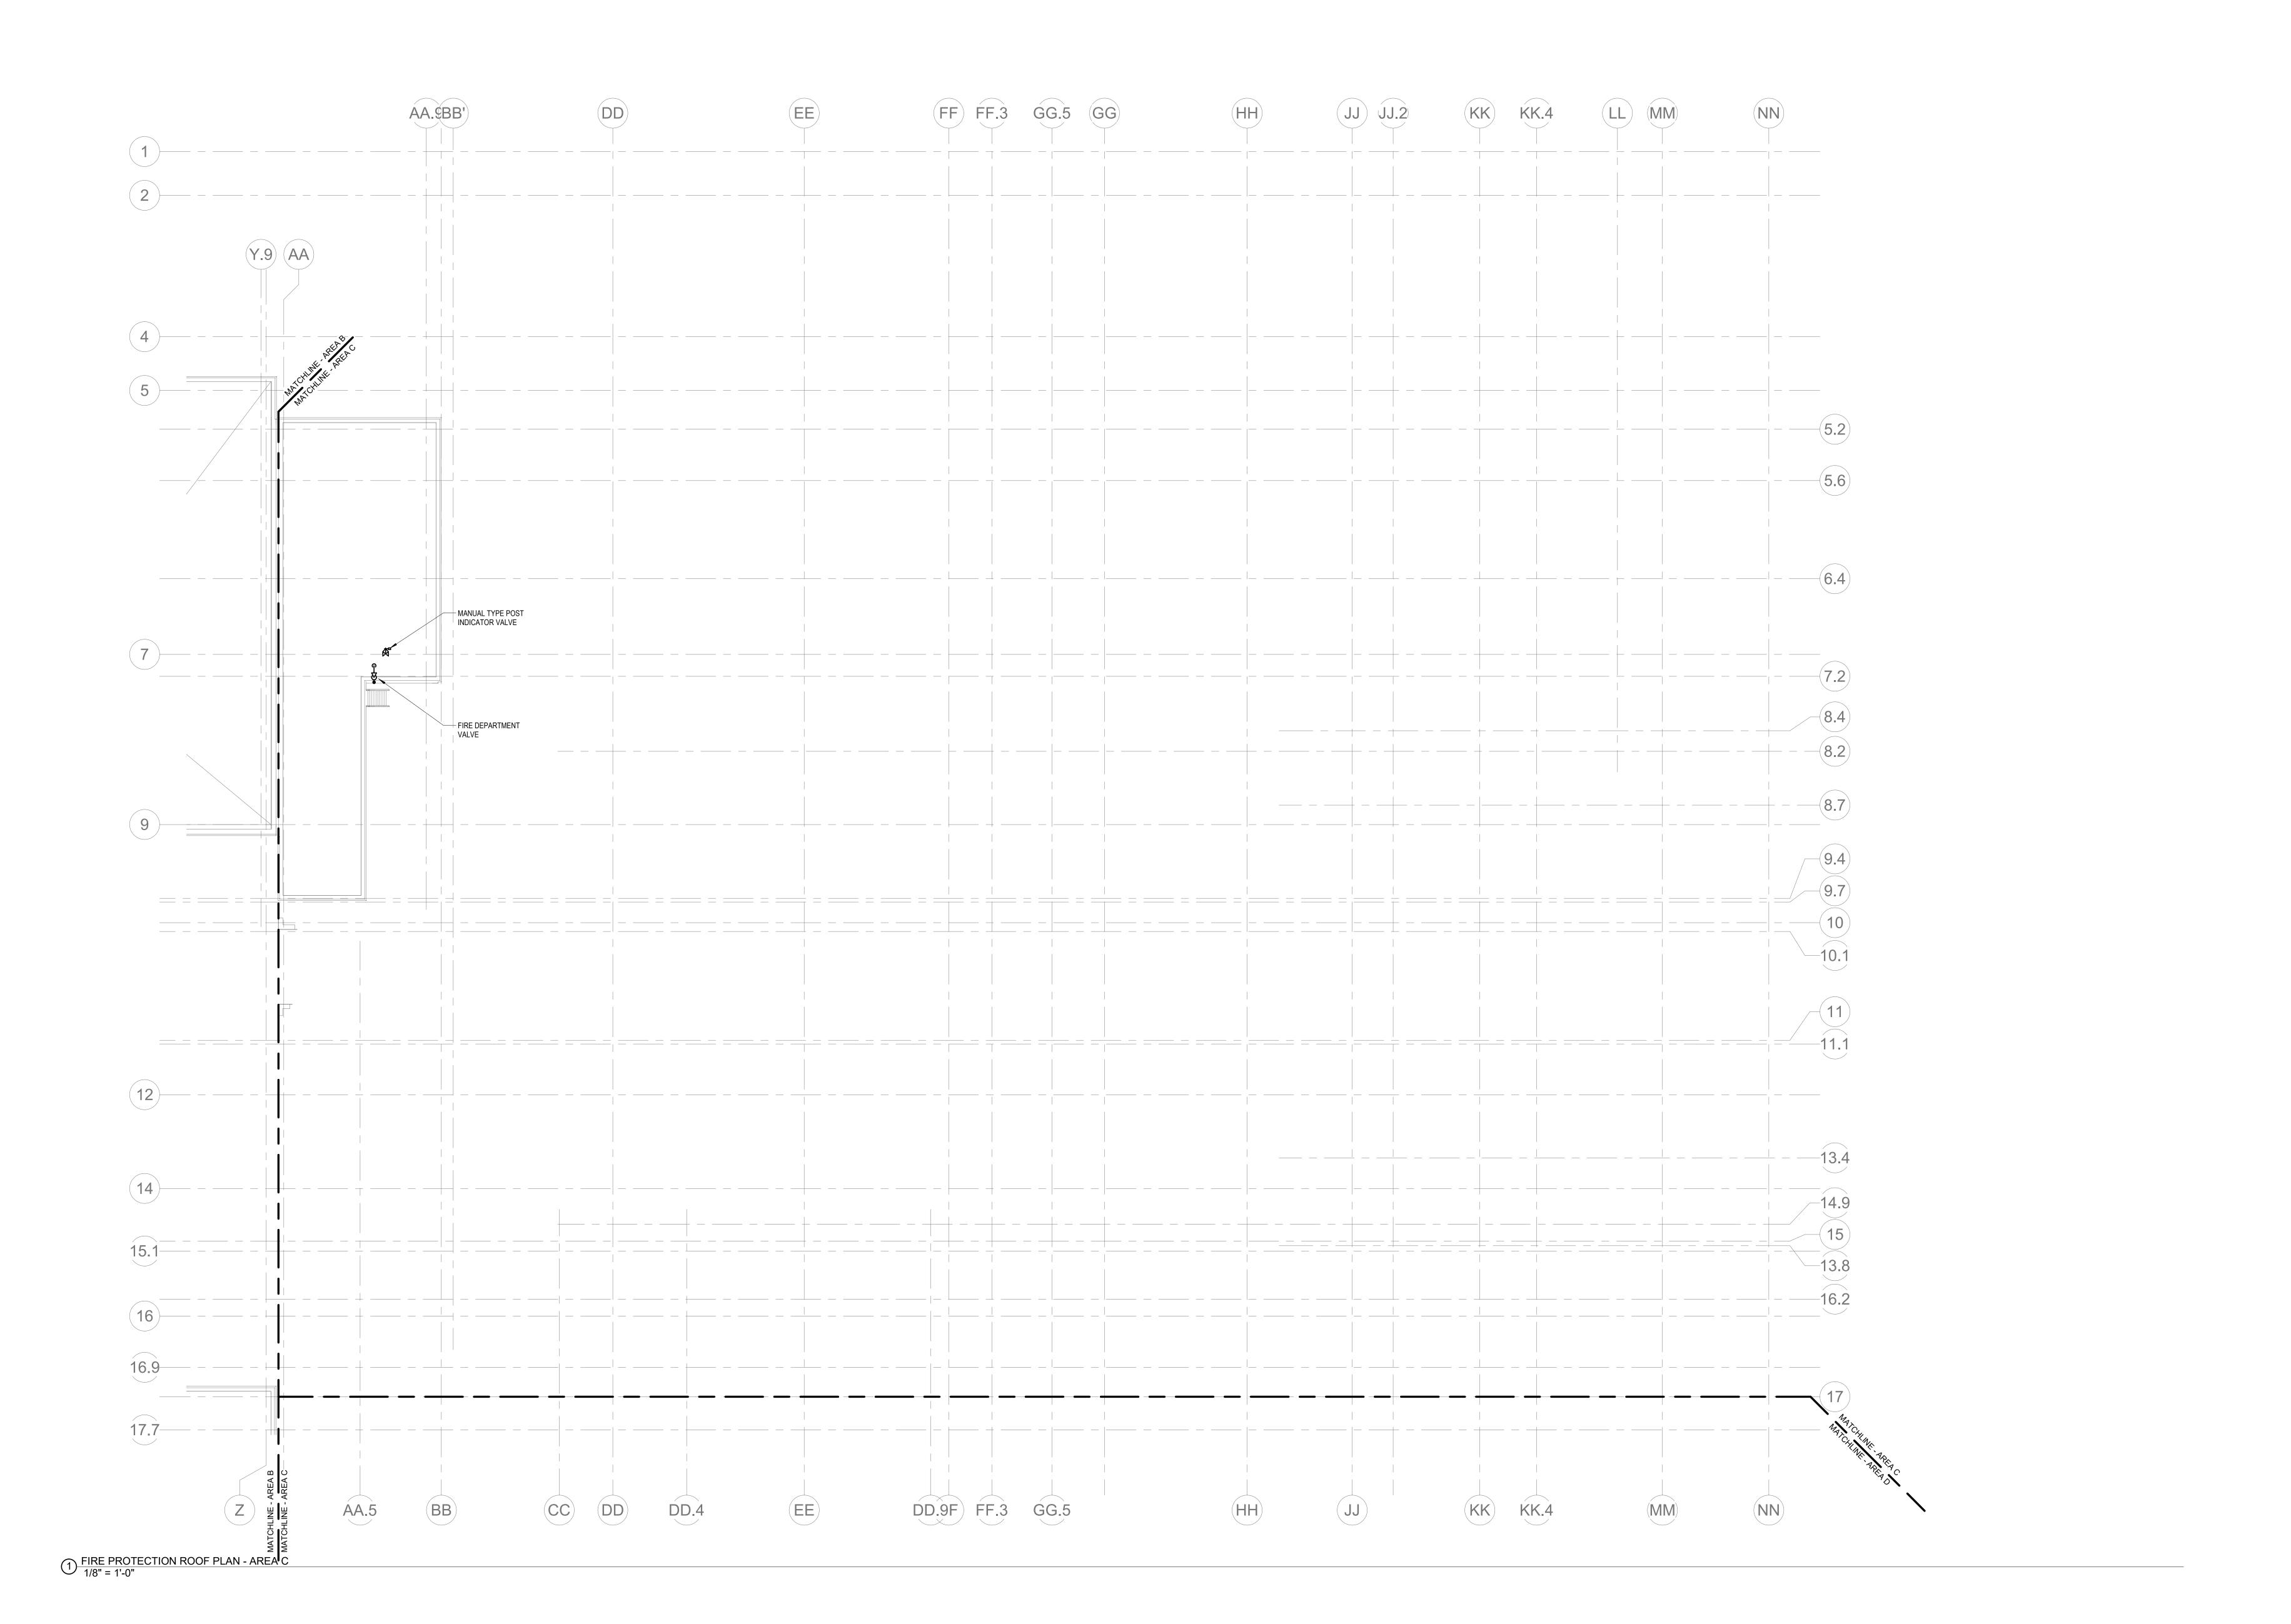



Drummey Rosane Anderson, Inc.

225 Oakland Road
Studio 205
South Windsor, CT

260 Charles Street
Studio 300
Waltham, MA

Studio 205
South Windsor, CT
06074

Planning | Architecture | Interior Design

Tel: 617.964.1700
www.draws.com

Northeast Metropolitan Regional Vocational High School

Wakefield, MA 01880


A CONSULTING ENGINEERS, INC. EMPLE PLACE TON, MA 02111-1306 617 357 6060 FAX: 617 357 5188 W.BALA.COM

ENGINEERS
PHLAGELPHA | NEW YORK | BOSTON | BULTIMORE | WASHINGTON,

MECHANICAL | ELECTROAL | PLUMBING | FREE PROTECTION
STRUCTURAL | TECHNOLOGY | COMMISSIONING

MSBA 60% CD SUBMISSION

January 13, 2023

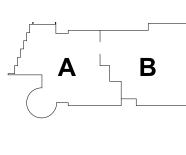

KEY PLAN

PROJECT NORTH MAGNETIC NORTH



FIRE PROTECTION ROOF PLAN -AREA C

Scale: 1/8" = 1'-0"


Job No.: 20202


Drawn By: DRA

FP1-2-1C

LH LIGHT HAZARD OCCUPANCY

OH ORDINARY HAZARD OCCUPANCY

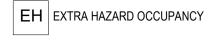

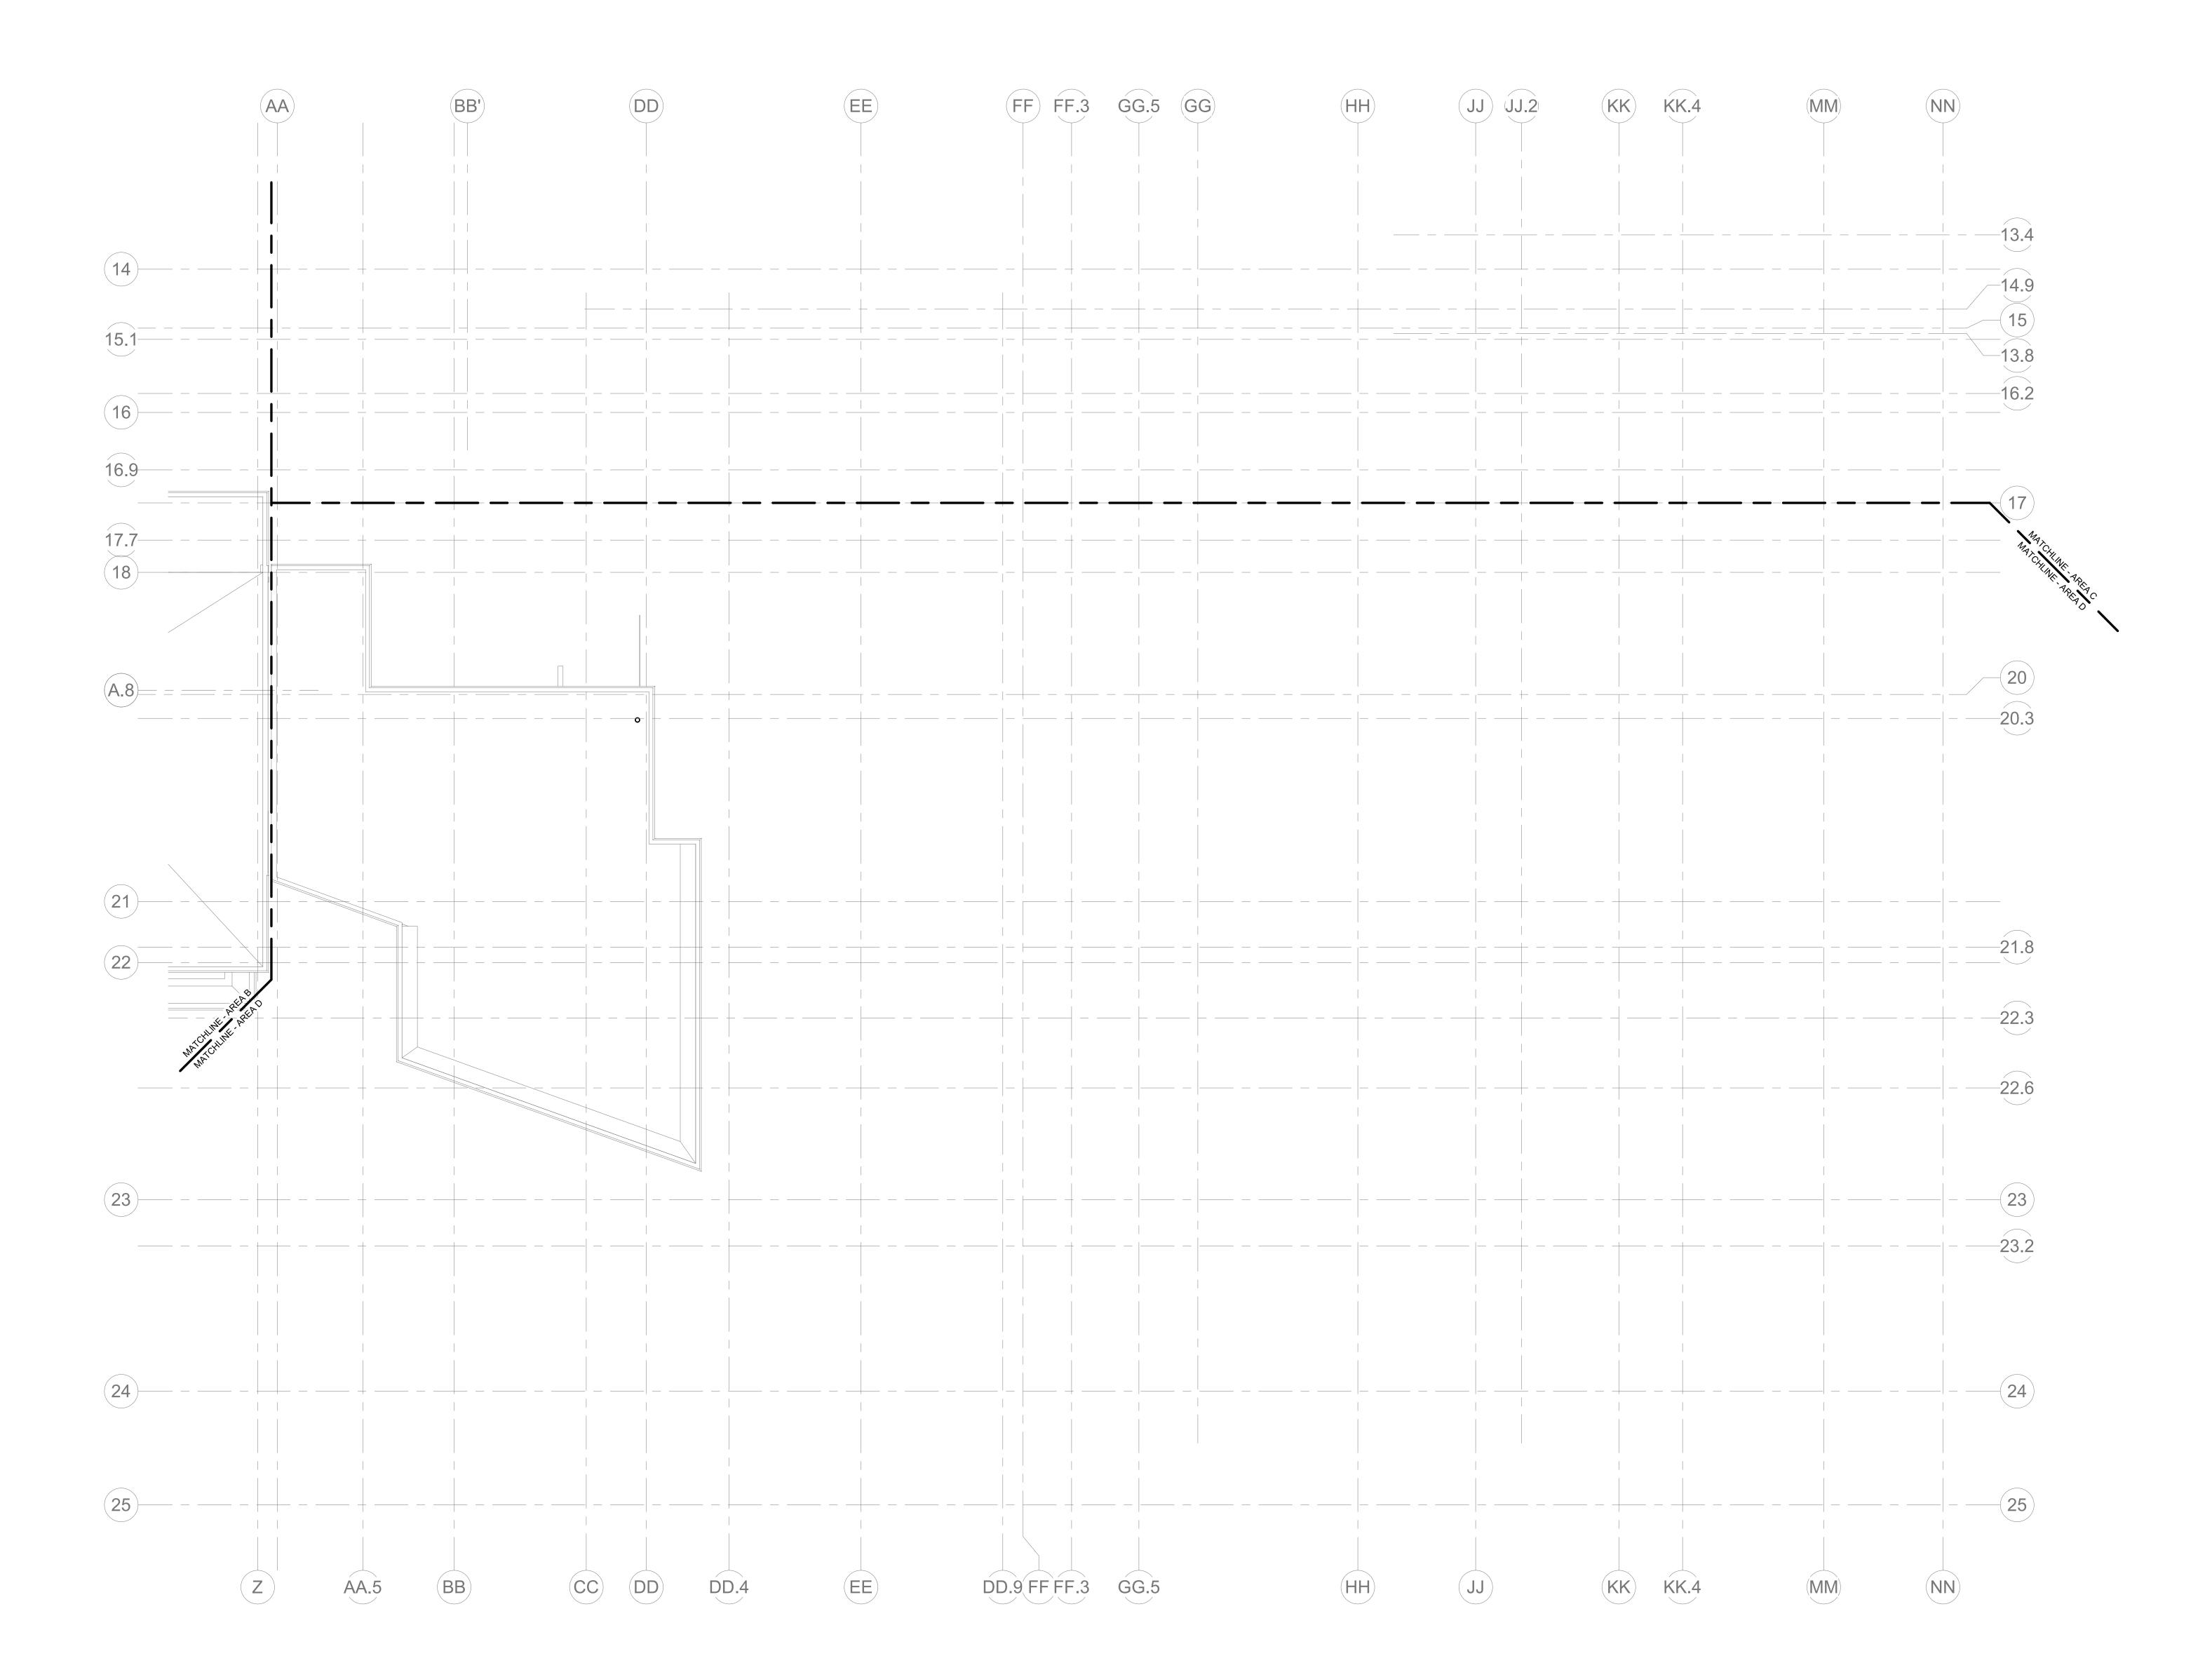

1/8" = 1'-0"



Drummey Rosane Anderson, Inc.

225 Oakland Road 260 Charles Street Studio 205 South Windsor, CT

Waltham, MA Planning | Architecture | Interior Design Tel: 617.964.1700 www.draws.com


Northeast Metropolitan Regional Vocational High School


Wakefield, MA 01880



BALLA ENGINEERS


MSBA 60% CD SUBMISSION

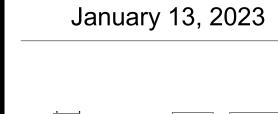

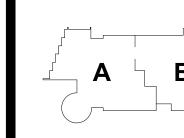

KEY PLAN

MAGNETIC NORTH

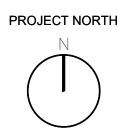


PROTECTION ROOF PLAN -AREA D

Drawn By: DRA

Date: January 13, 2023

FP1-2-1D

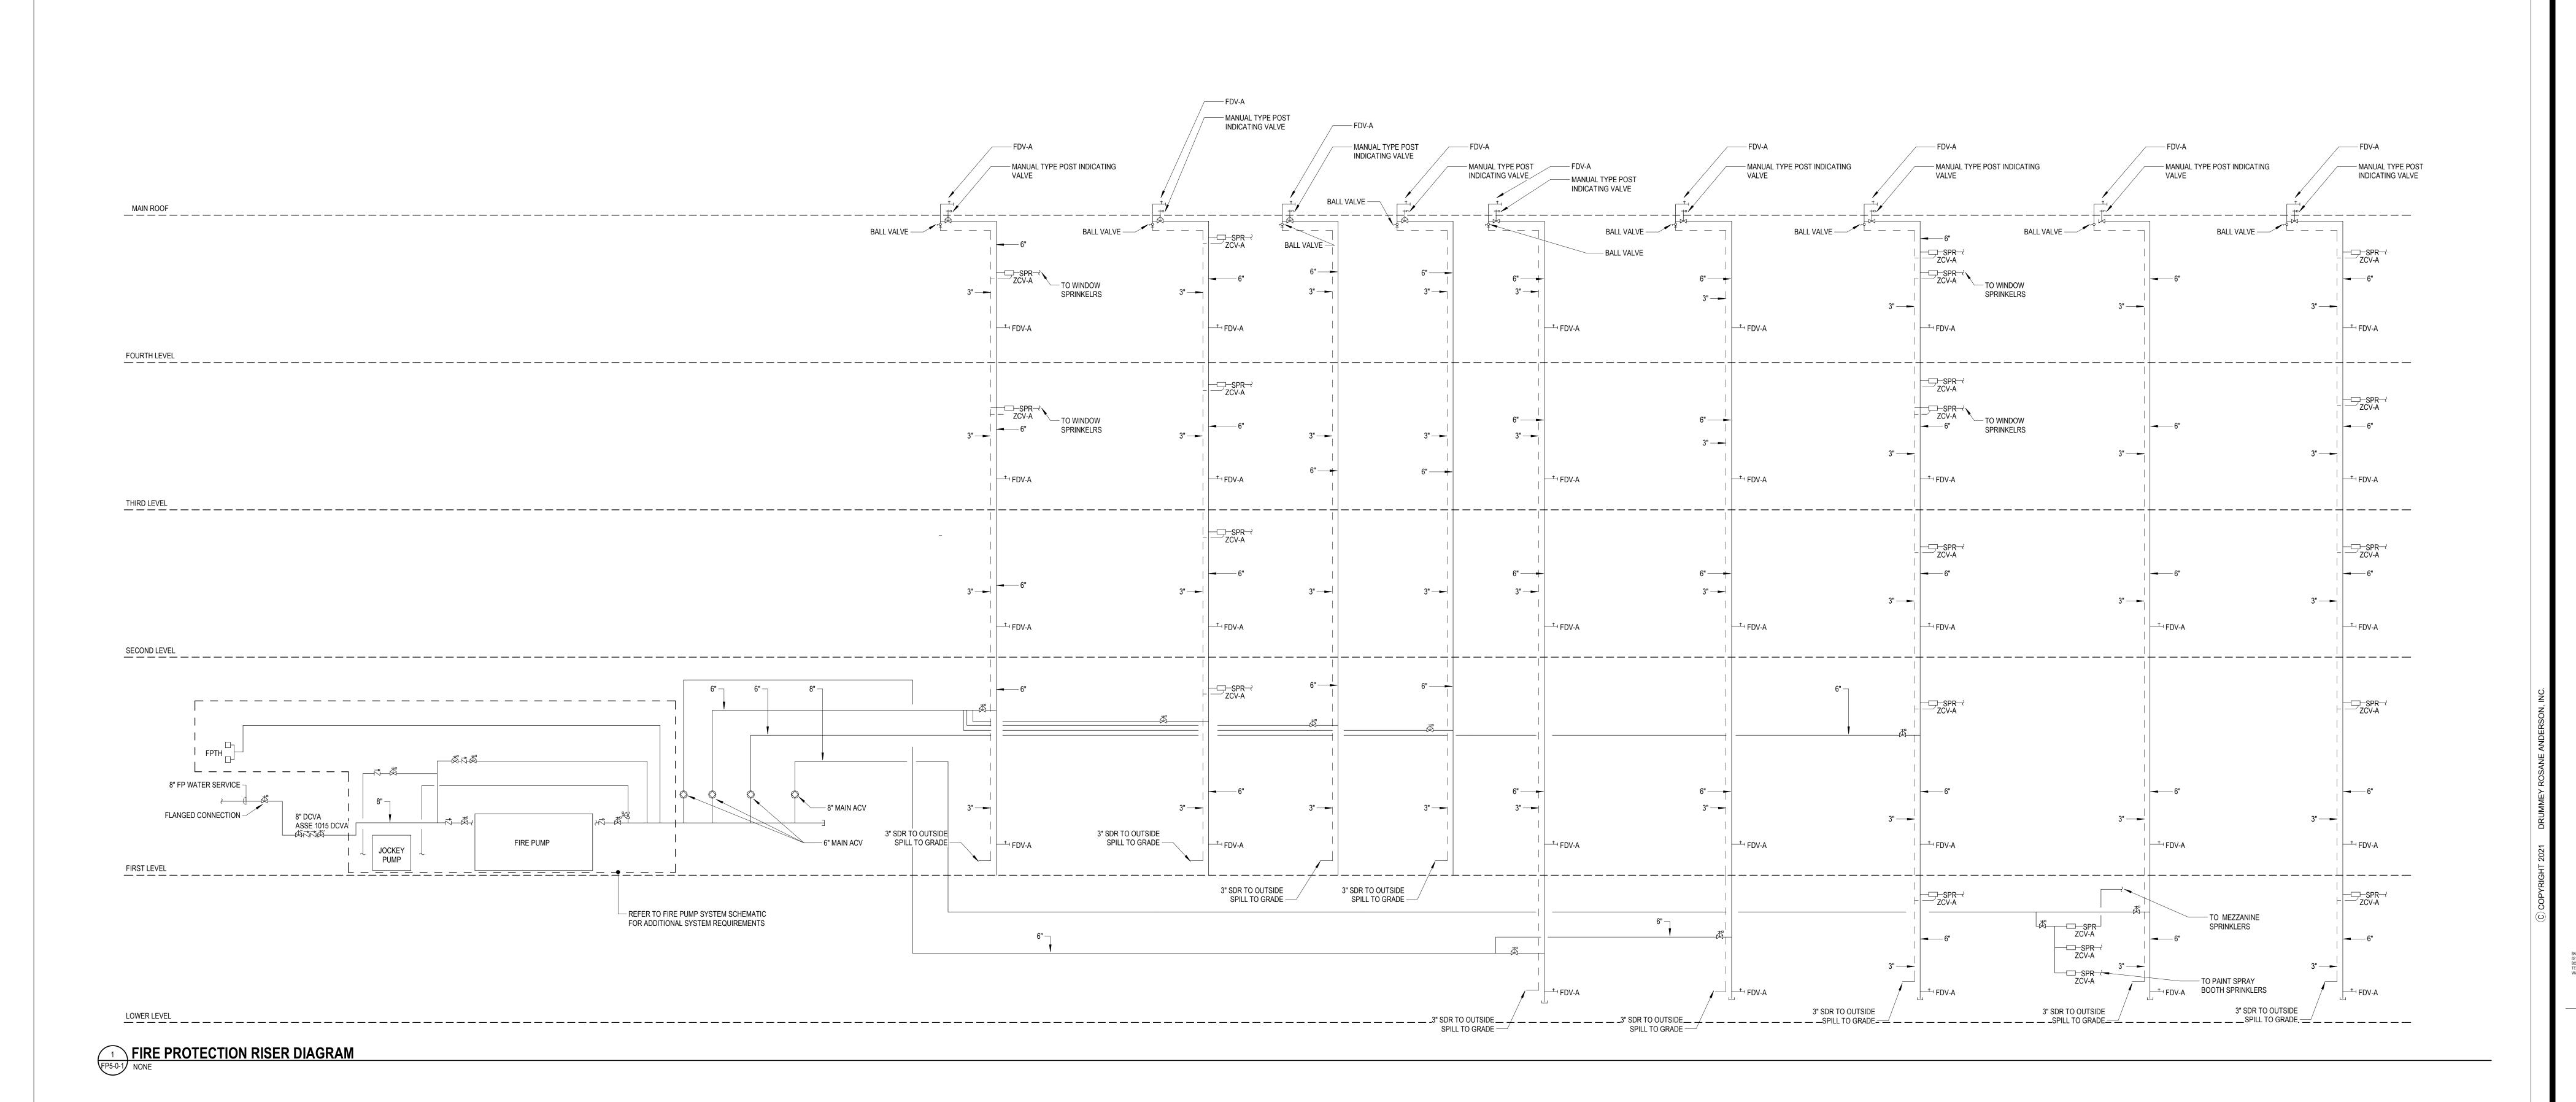


Studio 300

Drummey Rosane Anderson, Inc. 225 Oakland Road 260 Charles Street Studio 205 South Windsor, CT Waltham, MA

Northeast Metropolitan Regional Vocational High


Tel: 617.964.1700 www.draws.com


Wakefield, MA 01880

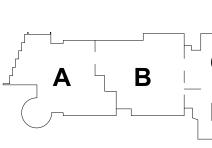



KEY PLAN




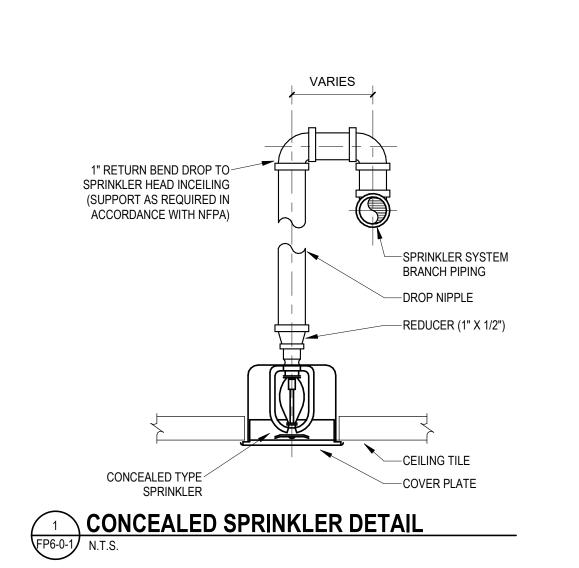


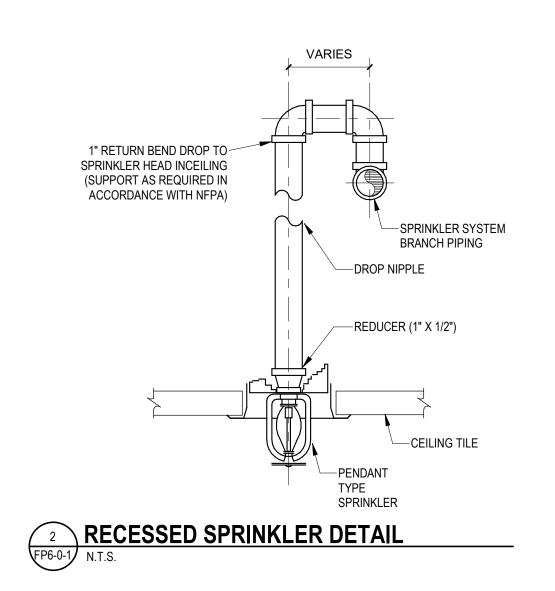


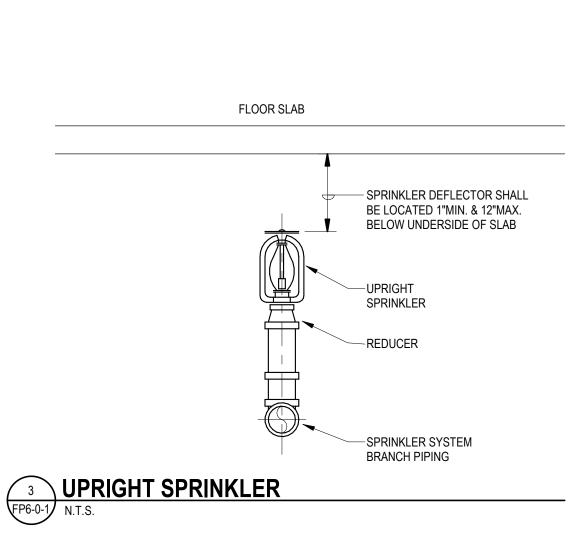


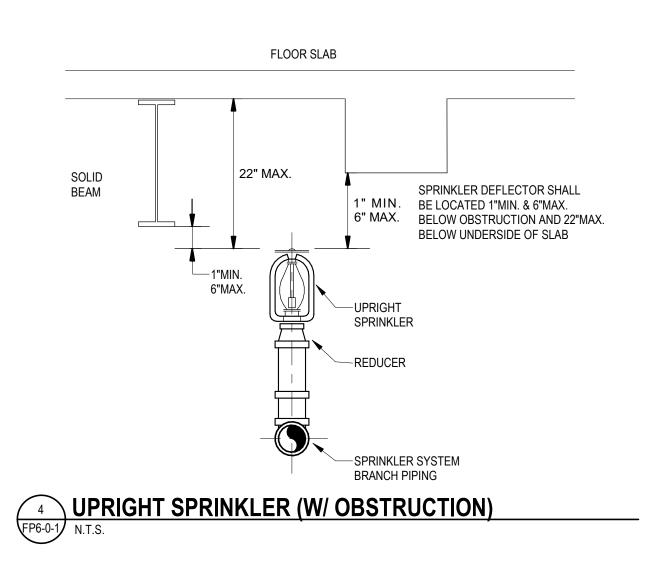


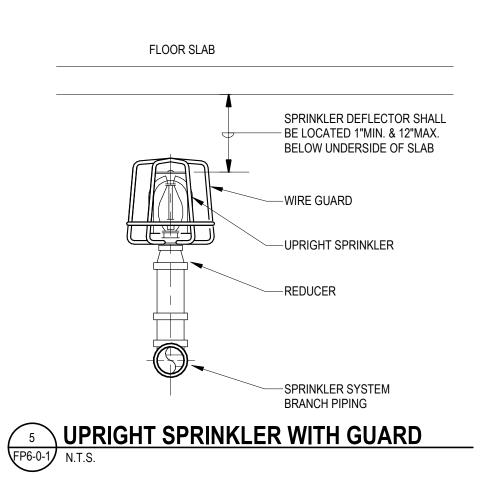

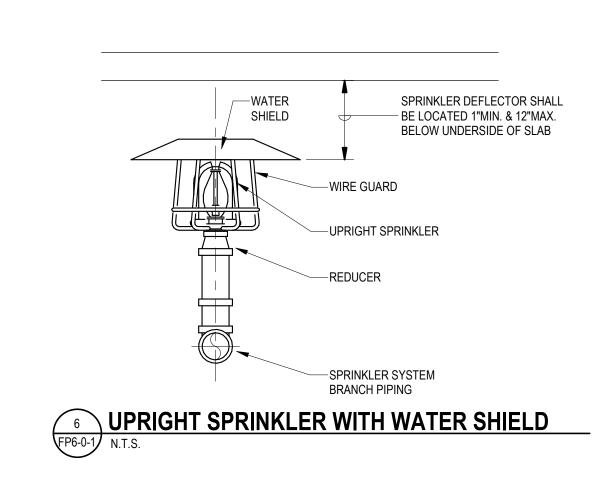

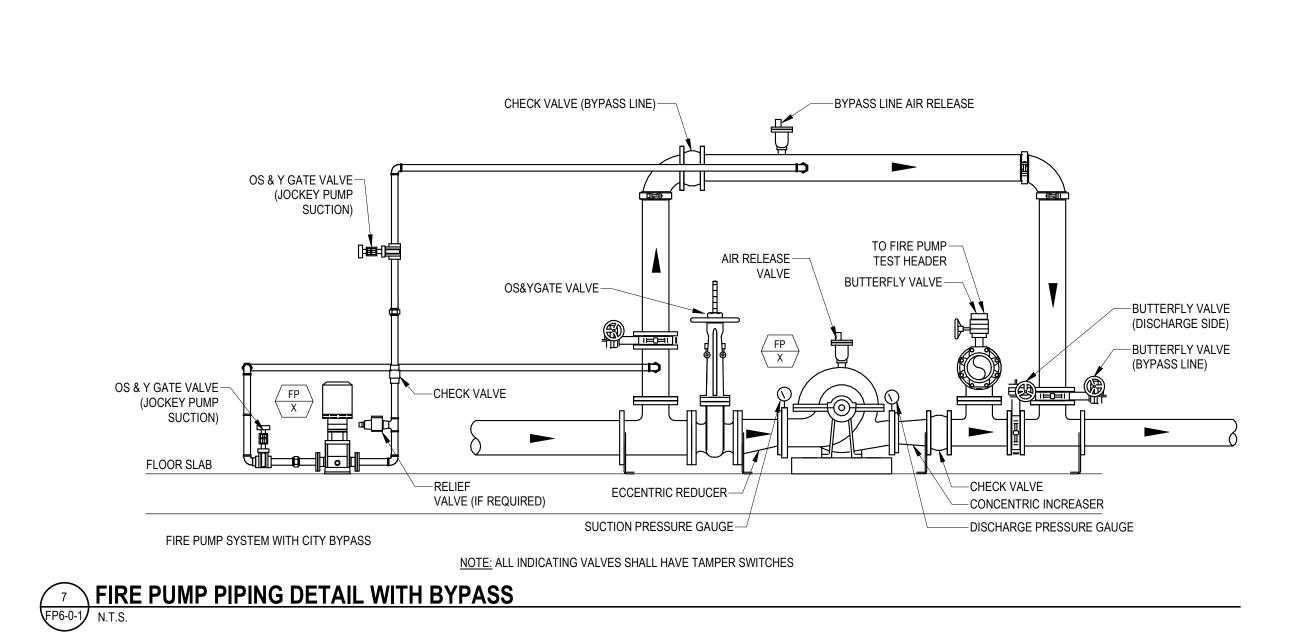

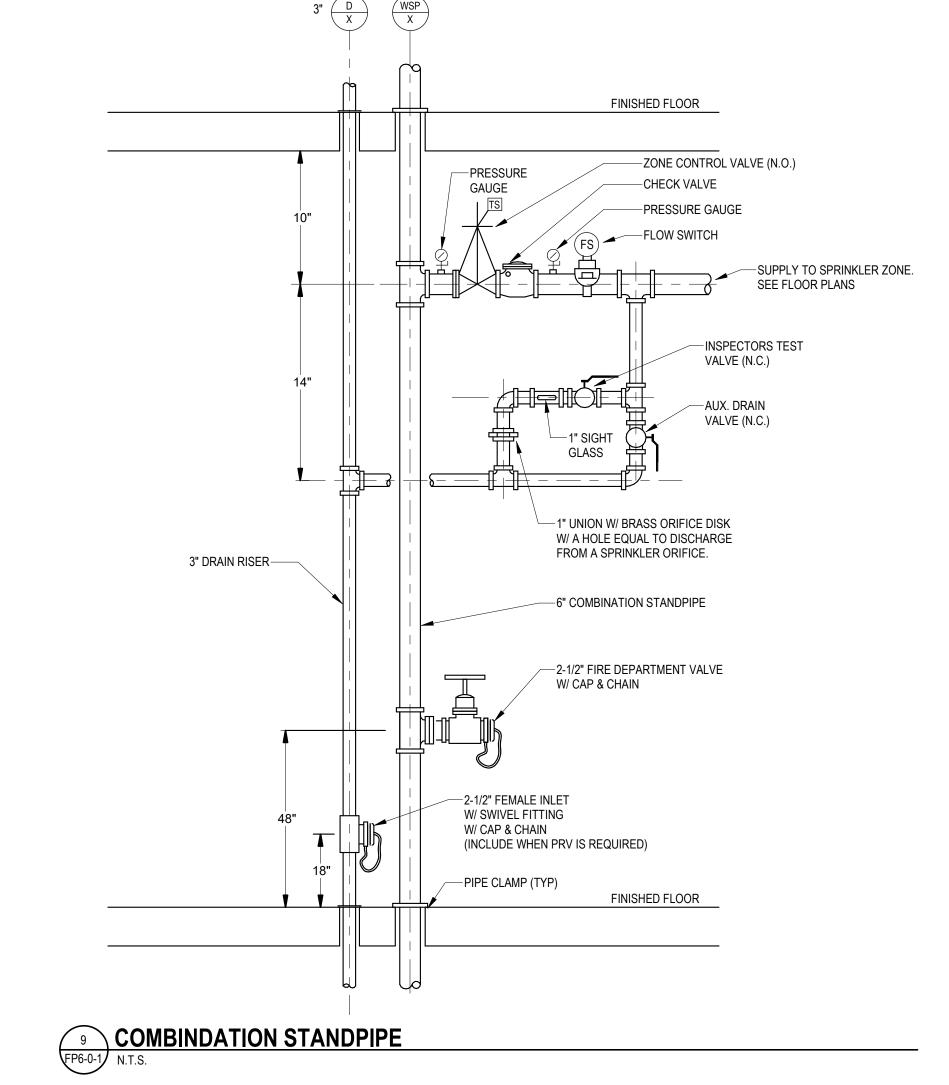

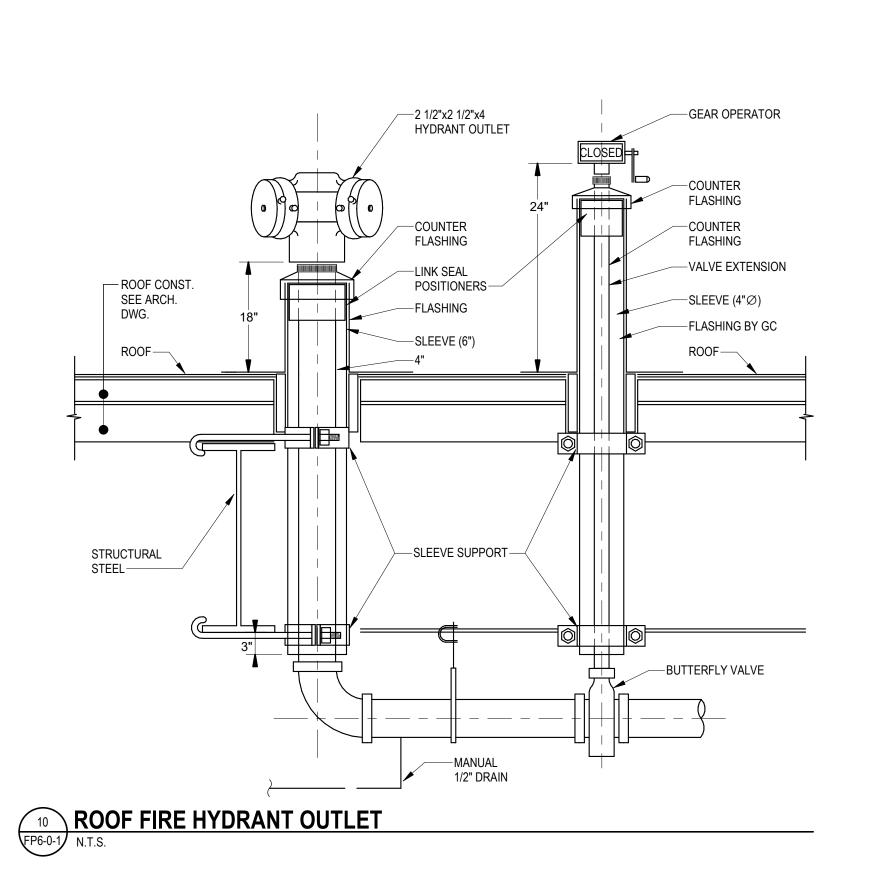



Northeast Metropolitan Regional Vocational High School

Wakefield, MA 01880


SULTING ENGINEERS, INC.
PLACE
AN 02111-1306
S7 8080 FAX: 617 357 5188
A.COM

PRILADELPRIA | NEW YORK | BOSTON | BULTMORE | WASHINGTON, DC

MECHANICAL | ELECTRICAL | PLUMBING | FIRE PROTECTION
STRUCTURAL | TECHNOLOGY | COMMISSIONING


MSBA 60% CD SUBMISSION

January 13, 2023

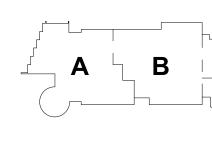

KEY PLAN

NORTH MAGNETIC NORTH

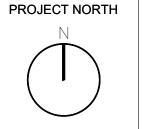

FIRE PROTECTION DETAILS

Scale: N.T.S.

Job No.: 20202

Drawn By: DRA

FP6-0-1